

	Exterior Finishes Schedule	
MATERIAL	DESCRIPTION	
EF1a	ARCHITECTURAL CONCRETE BLOCK: PRODUCT: SHOULDICE ARCHITECTURAL CONCRETE BLOCK PROFILE: DIMENSIONAL STONE 3 1/2"W x 7 1/2"H x 23 1/4"L FINISH: TAPESTRY COLOUR: COLBY MORTAR: SOLOMON 97A SUPER BLACK CONTROL JOINT AND CAULKING COLOUR TO MATCH MASONRY UNIT COLOUR.	FLEISCHEI
EF1b	CONCRETE PRECAST SILLS: PRODUCT: SHOULDICE CONCRETE SILL PROFILE: 424 SLOPED SILL WITH DRIP EDGE - 5 1/2"W X 3/2"H COLOUR: COLBY (COLOUR TO MATCH BLOCK BELOW) FINISH: TAPESTRY	67 Lesmill Toronto, ON, M30 T 416 425 turnerfleische
EF2a	BRICK: PRODUCT: SHOULDICE - BRICK PROFILE: URBAN - 3 1/2"W x 2 1/4"H x 15 5/8" L COLOUR: SMOOTH POLAR MORTAR: SOLOMON COLOURS INC - 60A WHITE CAULKING COLOURS TO MATCH MASONRY UNIT COLOUR.	This drawing, as an instrument of service, is provided by and is the property of Turner Fleic contractor must verify and accept responsibility for all dimensions and conditions on site a notify Turner Fleischer. of any variations from the supplied information. This drawing is no scaled. The architect is not responsible for the accuracy of survey, structural, mechanical, etc., information shown on this drawing. Refer to the appropriate consultant's drawings bed proceeding with the work. Construction must conform to all applicable codes and requirem authorities having jurisdiction. The contractor working from drawings not specifically marker Construction' must assume full responsibility and bear costs for any corrections or damage resulting from his work.
EF2b	BRICK: PRODUCT: SHOULDICE - BRICK PROFILE: URBAN - 3 1/2"W x 2 1/4"H x 15 5/8" L COLOUR: SMOOTH GALAXY MORTAR: SOLOMON COLOURS INC - 94X IRON BLACK CAULKING COLOURS TO MATCH MASONRY UNIT COLOUR.	
EF3a	FIBER CEMENT SIDING: PRODUCT: EQUITONE LINEA PROFILE: THICKNESS 10 mm - PANEL SIZE 3050 x 1220 mm FINISH: LINEA COLOUR: LT85 (DARK GREY)	
EF3b	FIBER CEMENT SIDING: PRODUCT: EQUITONE TECTIVA PROFILE: THICKNESS 10 mm - PANEL SIZE 3050 x 1220 mm FINISH: TECTIVA COLOUR: TE85 (GRAPHITE)	
EF4	GLAZED DOORS & WINDOWS: BLACK ANODIZED ALUMINUM FRAMES, CAP LESS MULLIONS, CAPPED TRANSOMS TEMPERED CLEAR INSULATED VISION GLASS / LOW-E GLAZING, LOW IRON GLAZING, BIRD-FRIENDLY GLAZING	
EF5	SPANDREL GLAZING DOORS & WINDOWS: BLACK ANODIZED ALUMINUM FRAMES, TEMPERED CLEAR INSULATED VISION GLASS / LOW-E GLAZING, LOW IRON GLAZING C/W INSULATED BACKPAN, BIRD-FRIENDLY GLAZING. COLOUR: OPACI-COAT RAL 7005 MOUSE GREY	
EF6	CURTAIN WALL ALUMINUM / FILLER PANEL: PRODUCT: 1/8" ANODIZED ALUMINUM PANEL, LAMINATED TO RIGID INSULATION AND GALVANIZED METAL SHEET, INTERIOR FINISHED W/ STUDS AND GYPSUM BOARD COLOUR: BLACK	
EF7	H.M. DOORS & FRAMES: PRODUCT: PREFINISHED INSULATED HOLLOW METAL DOORS AND FRAMES PAINTED COLOUR: TO MATCH ADJACENT FIBER CEMENT PANEL	
EF8a	CANOPIES FASCIA - ALUMINUM COMPOSITE PANEL: PRODUCT: ALPOLIC MATTE PROFILE: 2 1/4" ACM SYSTEM W/ 1/2" DRY JOINTS BETWEEN PANELS COLOUR: BSM SLATE BLACK	
EF8b	CANOPIES SOFFIT - ALUMINUM COMPOSITE PANEL: PRODUCT: LONGBOARD TONGUE & GROOVE PLANKS FOR SOFFIT PROFILE: SMOOTH 6" ACM COLOUR: WOODGRAIN LIGHT NATIONAL WALNUT C/W LINEAR LED LIGHTING ALIGNED WITH PLANK ORIENTATION. REFER TO ELECTRICAL DRAWINGS	
EF9	PREFINISHED METAL CAP FLASHING: PRE-FINISHED 16 GA. METAL FLASHING COLOUR: BLACK	
EF11	LIGHT FIXTURES EXTERIOR WALL MOUNTED LED BOX - REFER TO ELEC. C/W 5/8" EXTERIOR GRADE PLYWOOD BACKING	
EF12	EXTERIOR SIGNAGE: SIGNAGE TO BE PROVIDED BY AND INSTALLED BY TENANT. G.C. TO INSTALL 5/8" PLYWOOD BACKING FOR FUTURE MOUNTING OF SIGNAGE. SIGNAGE CONDUIT ROUGH-OUTS TO BE COORDINATED WITH TENANT.	
EF13	HIGH PARAPET (ROOF SIDE) - CORRUGATED METAL SIDING: PRODUCT: AGWAY WALL CLADDING PROFILE: 6-150 F COLOUR: BLACK / NOIR (QC 28262) FINISH: STANDARD	

fieldgate

 1
 2024-10-18
 ISSUED FOR SPA

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 DATE
 DESCRIPTION

ALLOA COMMERCIAL DEVELOPMENT


MAYFIELD & CREDITVIEW ROAD, BRAMPTON, ON PRE 2024-0102

BUILDING B4 ELEVATIONS

PROJECT NO. 22.111P02 PROJECT DATE 2024-09-12 DRAWN BY RLA CHECKED BY RAD SCALE 1/8" = 1'-0"





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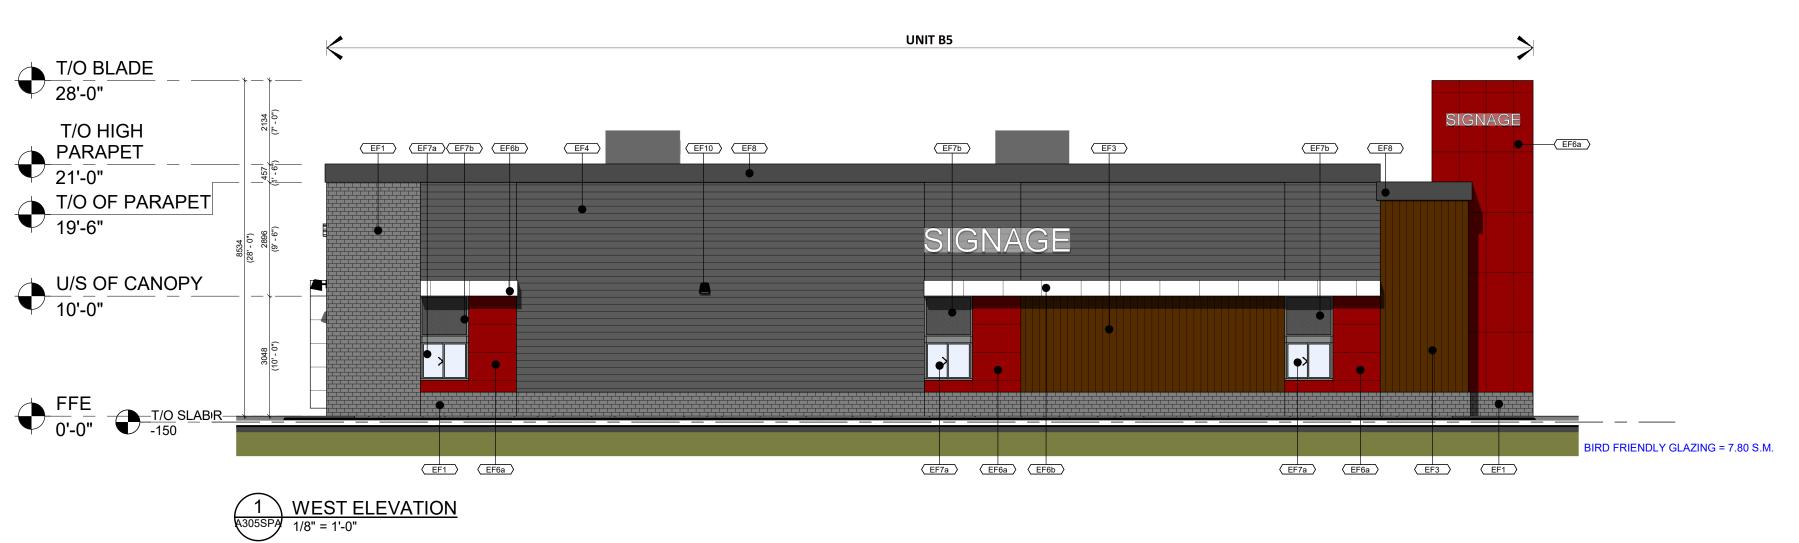


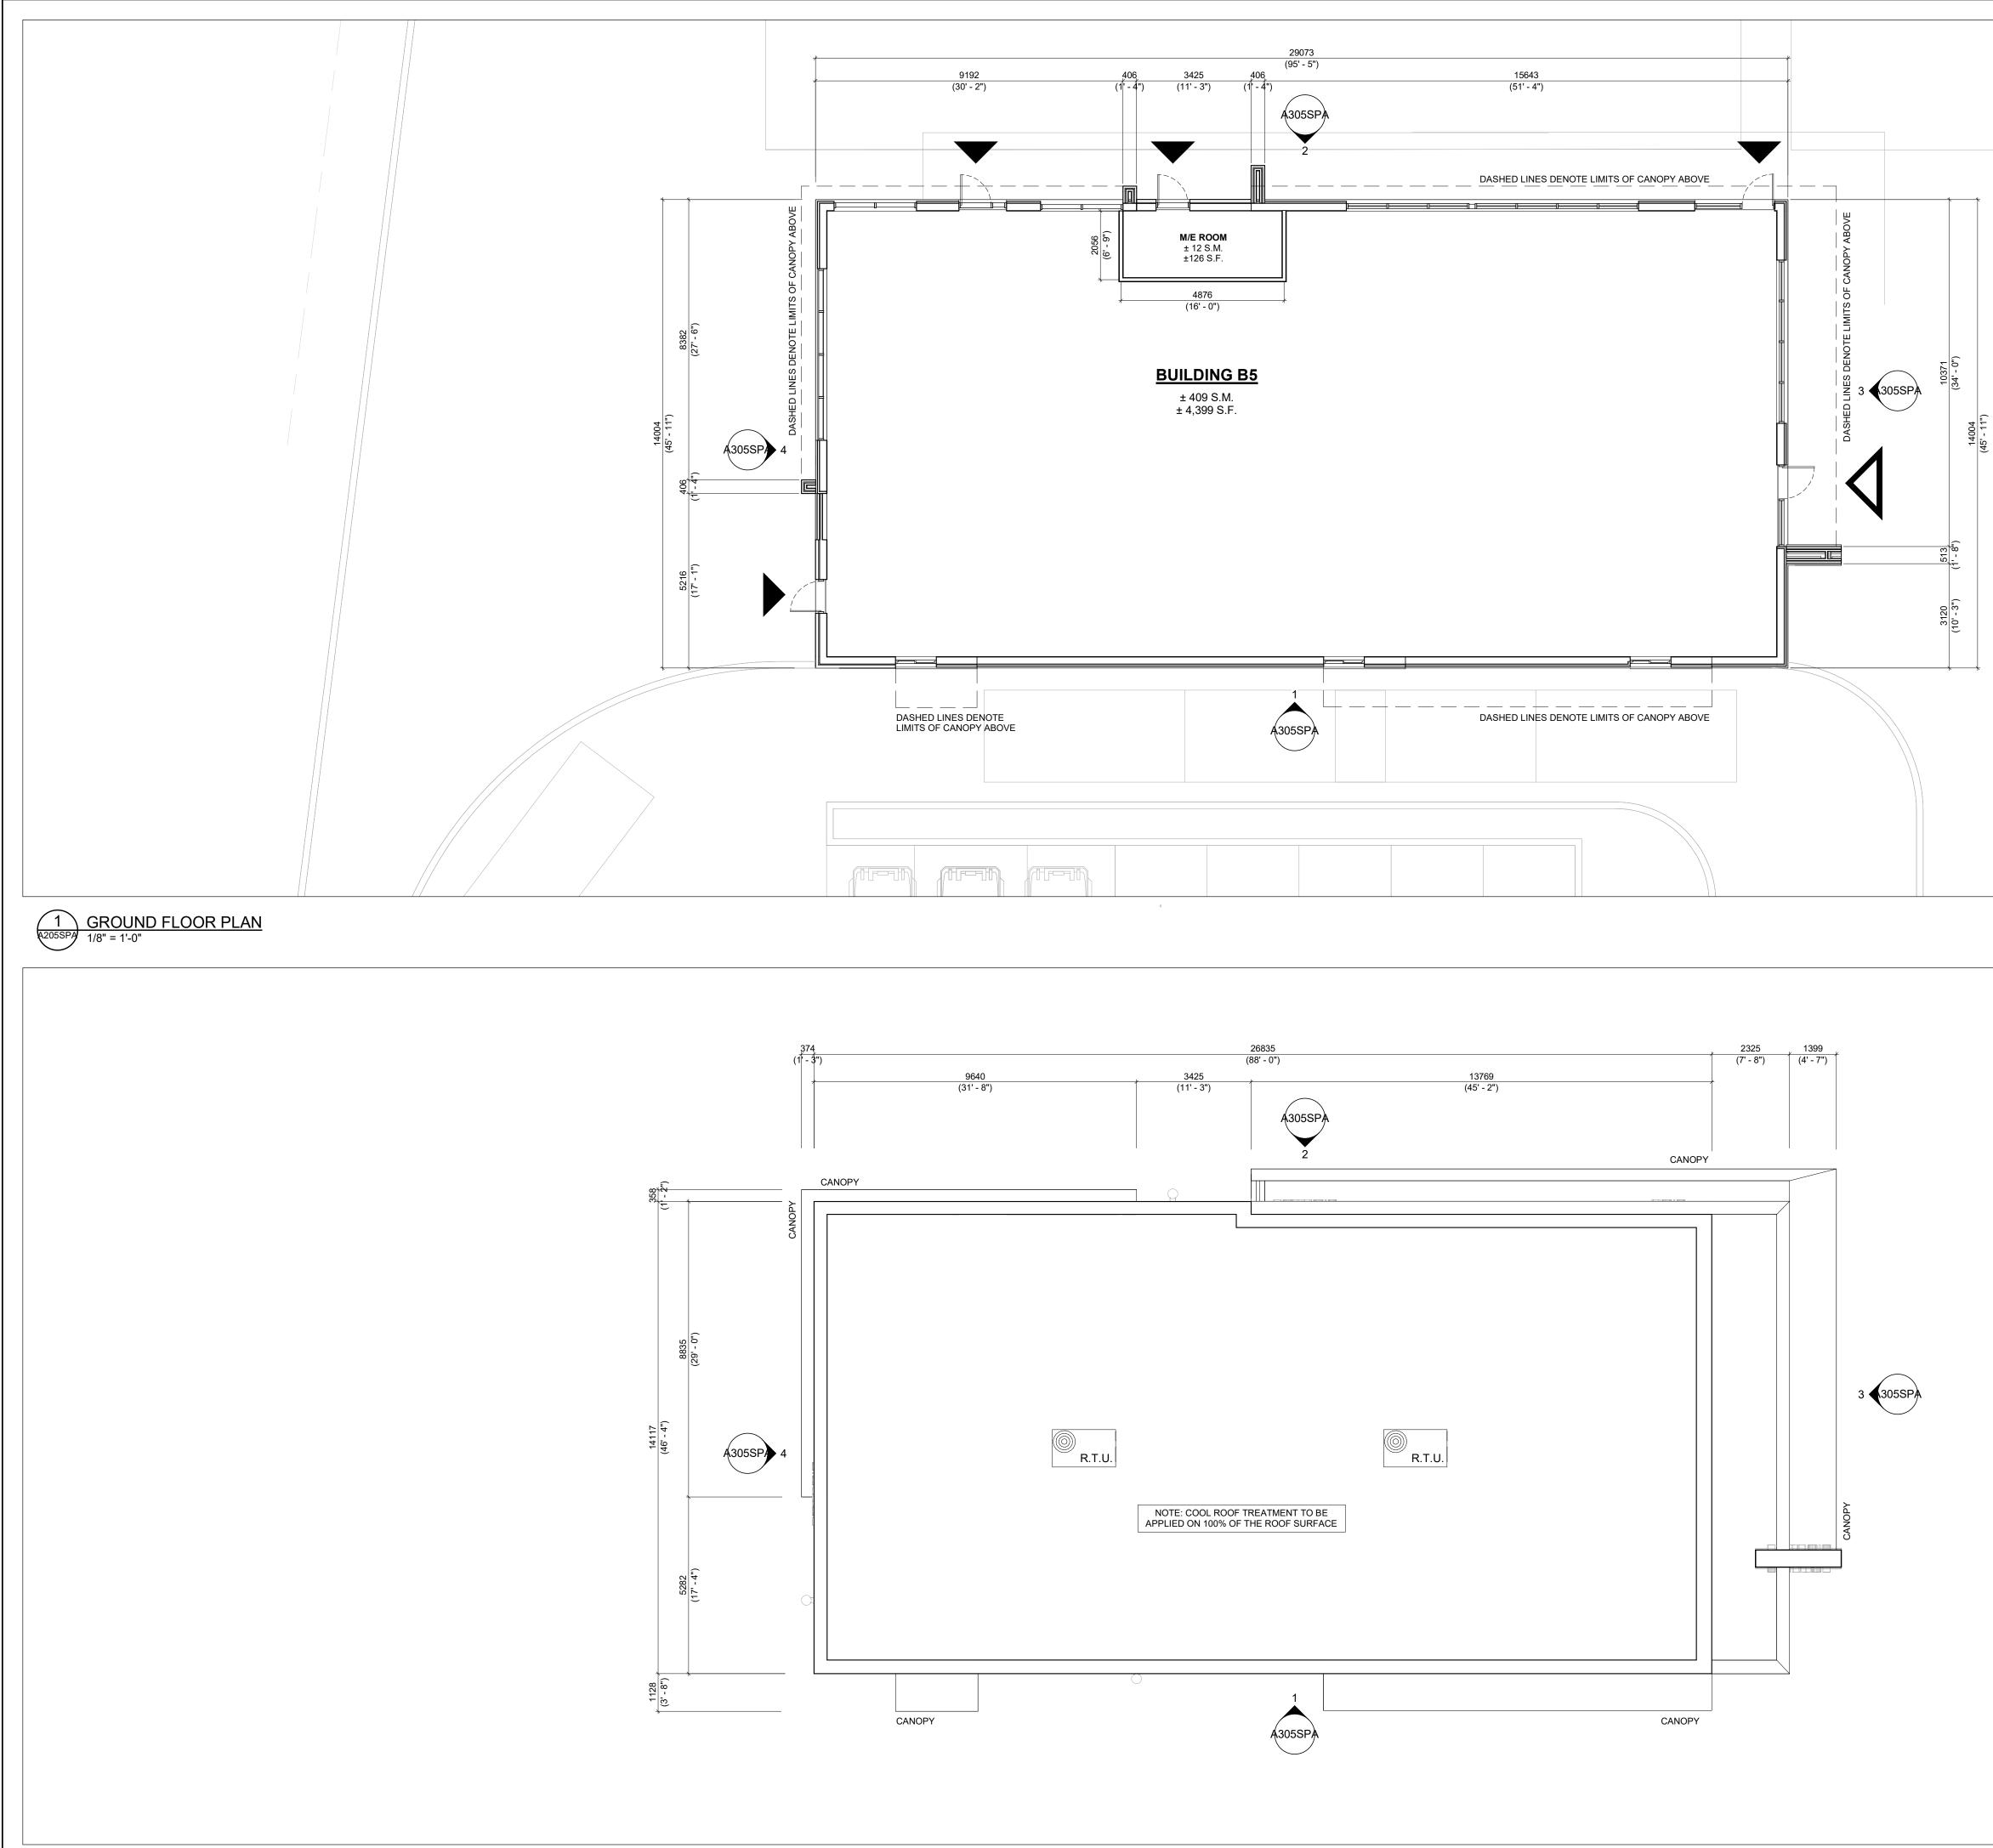
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been prepared or provided by others. The revisions to these contract documents, reflecting the significant changes in the work made during construction, are based on data furnished by the	c. ad T8 22 om t the iformity nation	
Image: Construction of the second drawing is a representation by Turner Fleischer Architects Inc. but is not a representation by Turner Fleischer Architects Inc. but is not a representation of the building is in general, as opposed to precise, construction, enlargement or alteration of the building is in conformity with a design the been prepared or provided by Uters. The revisions to these contract documents, reflecting the significant changes in the work made during construction, provided by the contractor to Turner Fleischer Architects Inc. shall not be held responsible for the accuracy or completeness of the information provided by the contractor. LEEGEND	c. ad T8 22 pm t the formity ntation	
67 Lesmill Ro Toronto, ON, M3B 2 T 416 425 22 turnerfleischer.co The issuance of this record drawing is a representation by Turner Fleischer Architects Inc. that construction, enlargement or alteration of the building is in general, as opposed to precise, cor with the design prepared and provided by Turner Fleischer Architects Inc. but is not a represen- that the construction, enlargement or alteration of the building is in conformity with a design the been prepared or provided by others. The revisions to these contract documents, reflecting the significant changes in the work made during construction, are based on data furnished by the contractor to Turner Fleischer Architects Inc. Turner Fleischer Architects Inc. shall not be held responsible for the accuracy or completeness of the information provided by the contractor. LEGEEND	ad T8 22 om t the formity nation	
Toronto, ON, M3B 2 T 416 425 22 turnerfleischer.co The issuance of this record drawing is a representation by Turner Fleischer Architects Inc. that construction, enlargement or alteration of the building is in general, as opposed to precise, cor with the design prepared and provided by Turner Fleischer Architects Inc. built is not a represent that the construction, enlargement or alteration of the building is in conformity with a design the been prepared or provided by others. The revisions to these contract documents, reflecting the significant changes in the work made during construction, are based on data furnished by the contractor to Turner Fleischer Architects Inc. Turner Fleischer Architects Inc. shall not be held responsible for the accuracy or completeness of the information provided by the contractor. LEEGEND	T8 22 om t the nformity	
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MAIN ENTRANCE	LEGEND	
EXIT / SECONDARY		
ENTRANCE		
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PROJECT		
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MAYFIELD & CREDITVIEW ROAD, BRAMPTON, C PRE 2024-0102	N	
DRAWING		
BUILDING B5 FLOOR PLAN AND ROOF PLAN		
PROJECT NO.		
22.111P02		
PROJECT DATE 2024-02-02 DRAWN BY DRAWN BY DRAWN BY DRAWN BY DRAWN BY		
SCALE LICENCE LICENCE		





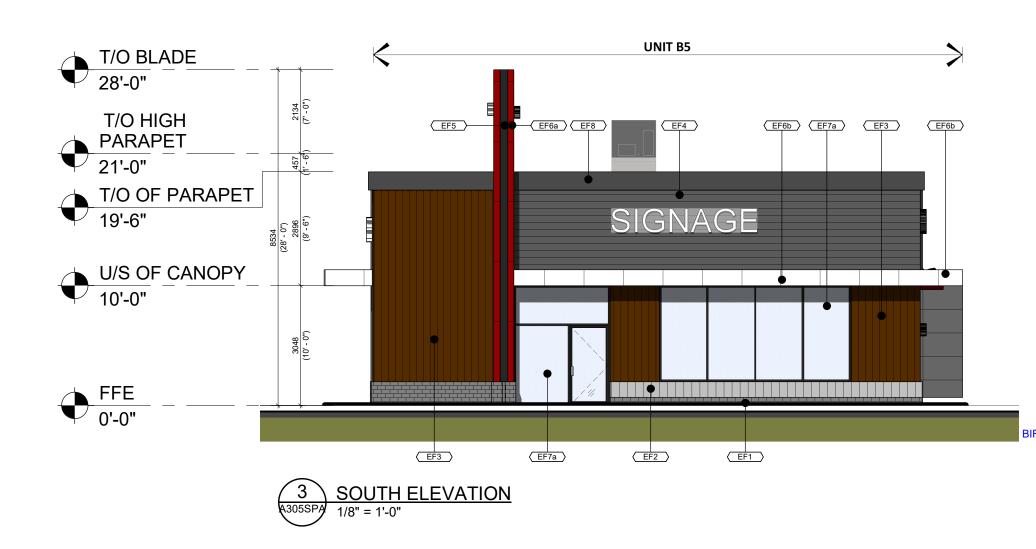

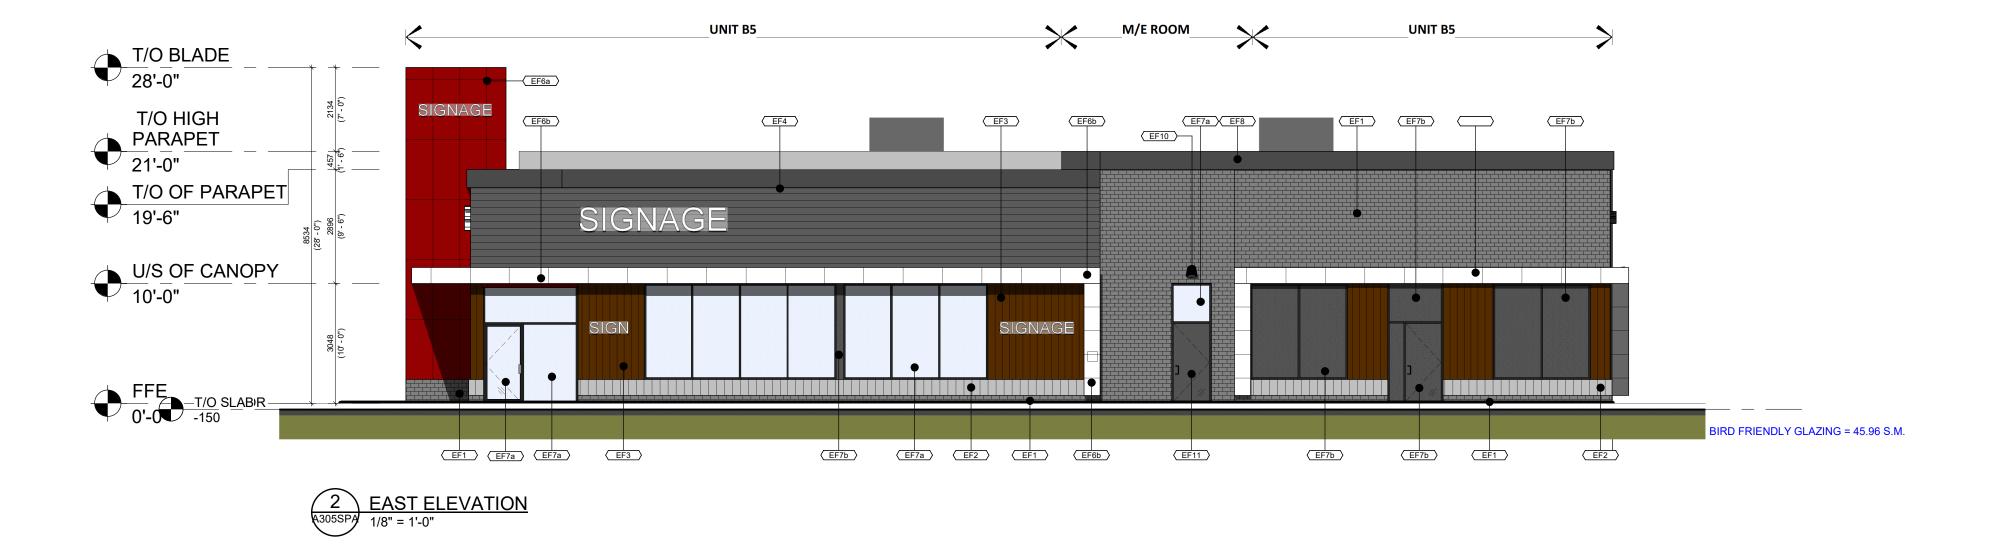

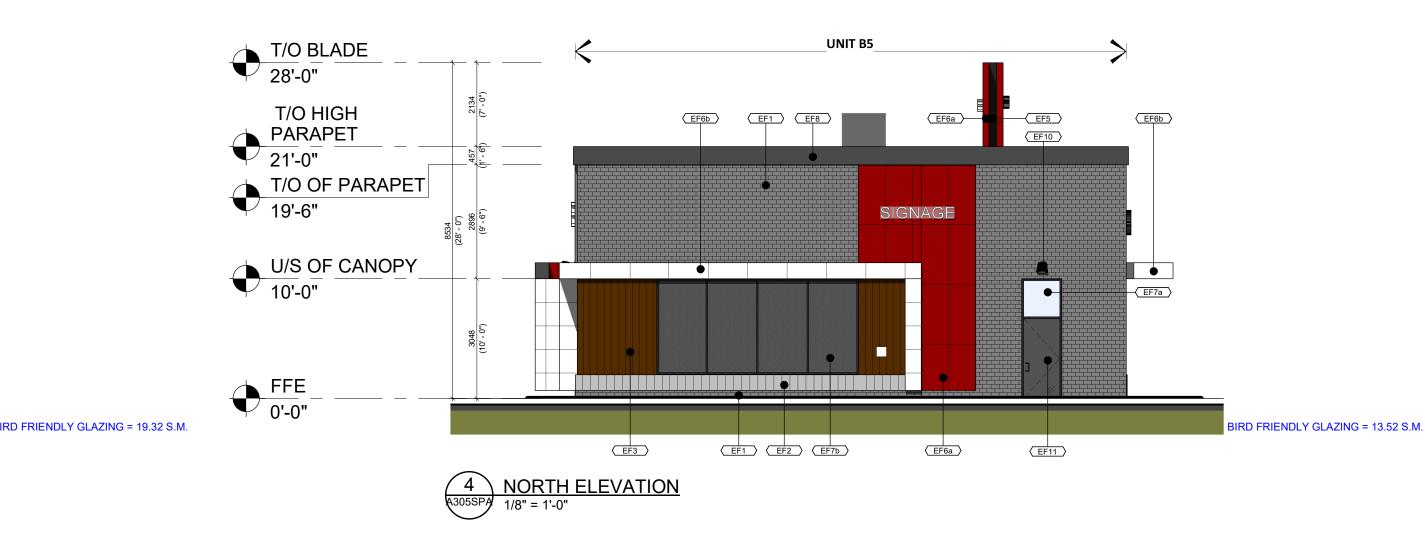MATERIAL	AL DESCRIPTION		
EF1	BRICK MASONRY: PRODUCT: RICHVALE YORK BLOCK INC. SERIES: CAMBRIDGE MANUFACTURED USING CARBOCLAVE PROFILE: 4" X 16" X 4" FINISH: GROUND FACE COLOUR: ONYX MORTAR: SOLOMON 97A SUPER BLACK CONTROL JOINT AND CAULKING COLOUR		
	TO MATCH MASONRY UNIT COLOUR.		
EF2	BRICK MASONRY: PRODUCT: RICHVALE YORK BLOCK INC. SERIES: CAMBRIDGE MANUFACTURED USING CARBOCLAVE PROFILE: 8" X 16" X 8" FINISH: GROUND FACE COLOUR: ARCTIC WHITE MORTAR: SOLOMON 60A WHITE CONTROL JOINT AND CAULKING COLOUR TO MATCH MASONRY UNIT COLOUR.		
EF3	ALUMINUM CLADDING: PRODUCT: LONGBOARD CLADDING PROFILE: 6" V-GROOVE PLANK COLOUR: LIGHT WALNUT		
EF4	METAL SIDING: PRODUCT: PRE-FINISHED STEEL CLADDING VICWEST PROFILE: AD300-SR COLOUR: 56161 - CAMBRIDGE WHITE		
EF5	METAL FLASHING: PRODUCT: PRE-FINISHED METAL FLASHING AT REVEAL COLOUR: TO MATCH ALPOLIC "MZG MICA GREY"		
EF6a	ALUMINUM COMPOSITE PANELS: PRODUCT: ALPOLIC PROFILE: 4mm ACM SYSTEM W/ 16mm DRY JOINT SYSTEM C/W MATCHING TRIMS/FLASHING COLOUR: RON RED		
EF6b	CANOPY - ALUMINUM COMPOSITE PANELS: PRODUCT: ALPOLIC PROFILE: 4mm ACM SYSTEM W/ 16mm DRY JOINT SYSTEM C/W MATCHING TRIMS/FLASHING COLOUR: ALPOLIC - BNT WHITE		
EF7a	GLAZED / ALUMINUM DOOR & WINDOWS: BLACK ANODIZED ALUMINUM FRAMES, TEMPERED CLEAR INSULATED VISION GLASS / LOW-E GLAZING, LOW IRON GLAZING, BIRD-FRIENDLY GLAZING (VISUAL MARKERS 4mm IN DIAMETER, SPACED AT 5cm HORIZONTALLY AND VERTICALLY)		
EF7b	SPANDREL GLAZING / ALUMINUM DOOR & WINDOWS: BLACK ANODIZED ALUMINUM FRAMES, TEMPERED CLEAR INSULATED VISION GLASS / LOW-E GLAZING, LOW IRON GLAZING, BIRD-FRIENDLY GLAZING (VISUAL MARKERS 4mm IN DIAMETER, SPACED AT 5cm HORIZONTALLY AND VERTICALLY) COLOUR: OPACI-COAT RAL 7005 MOUSE GREY		
EF8	PRE-FINISHED METAL FLASHING: PRE FINISHED 16 GA. METAL FLASHING COLOUR: TO MATCH ADJACENT FINISH		
EF9	SIGNAGE: PROPOSED SIGNAGE LOCATION (UNDER SEPERATE PERMIT)		
EF10	LIGHT FIXTURE: EXTERIOR WALL PAK LIGHT (REFER TO ELECTRICAL DRAWINGS). FINISH: BLACK - PROVIDE SMOOTH BAND AROUND FIXTURE		
EF11	H.M. DOOR TRANSOM FRAMES COLOUR: CHARCOAL GRAY-MCD 44		

TURNER FLEISCHER **Turner Fleischer Architects Inc.** 67 Lesmill Road Toronto, ON, M3B 2T8 T 416 425 2222 turnerfleischer.com The issuance of this record drawing is a representation by Turner Fleischer Architects Inc. that the construction, enlargement or alteration of the building is in general, as opposed to precise, conformit with the design prepared and provided by Turner Fleischer Architects Inc., but is not a representation that the construction, enlargement or alteration of the building is in conformity with a design that has been prepared or provided by others. The revisions to these contract documents, reflecting the significant changes in the work made during construction, are based on data furnished by the contractor to Turner Fleischer Architects Inc. Turner Fleischer Architects Inc. shall not be held responsible for the accuracy or completeness of the information provided by the contractor.

fieldgate

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 2024-10-18
 ISSUED FOR SPA

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 DATE
 DESCRIPTION

ALLOA COMMERCIAL DEVELOPMENT

MAYFIELD & CREDITVIEW ROAD, BRAMPTON, ON PRE 2024-0102


RAWING

BUILDING B5 ELEVATIONS


PROJECT NO. 22.111P02 PROJECT DATE 2024-02-02 DRAWN BY ETI CHECKED BY JJJ SCALE 1/8" = 1'-0"



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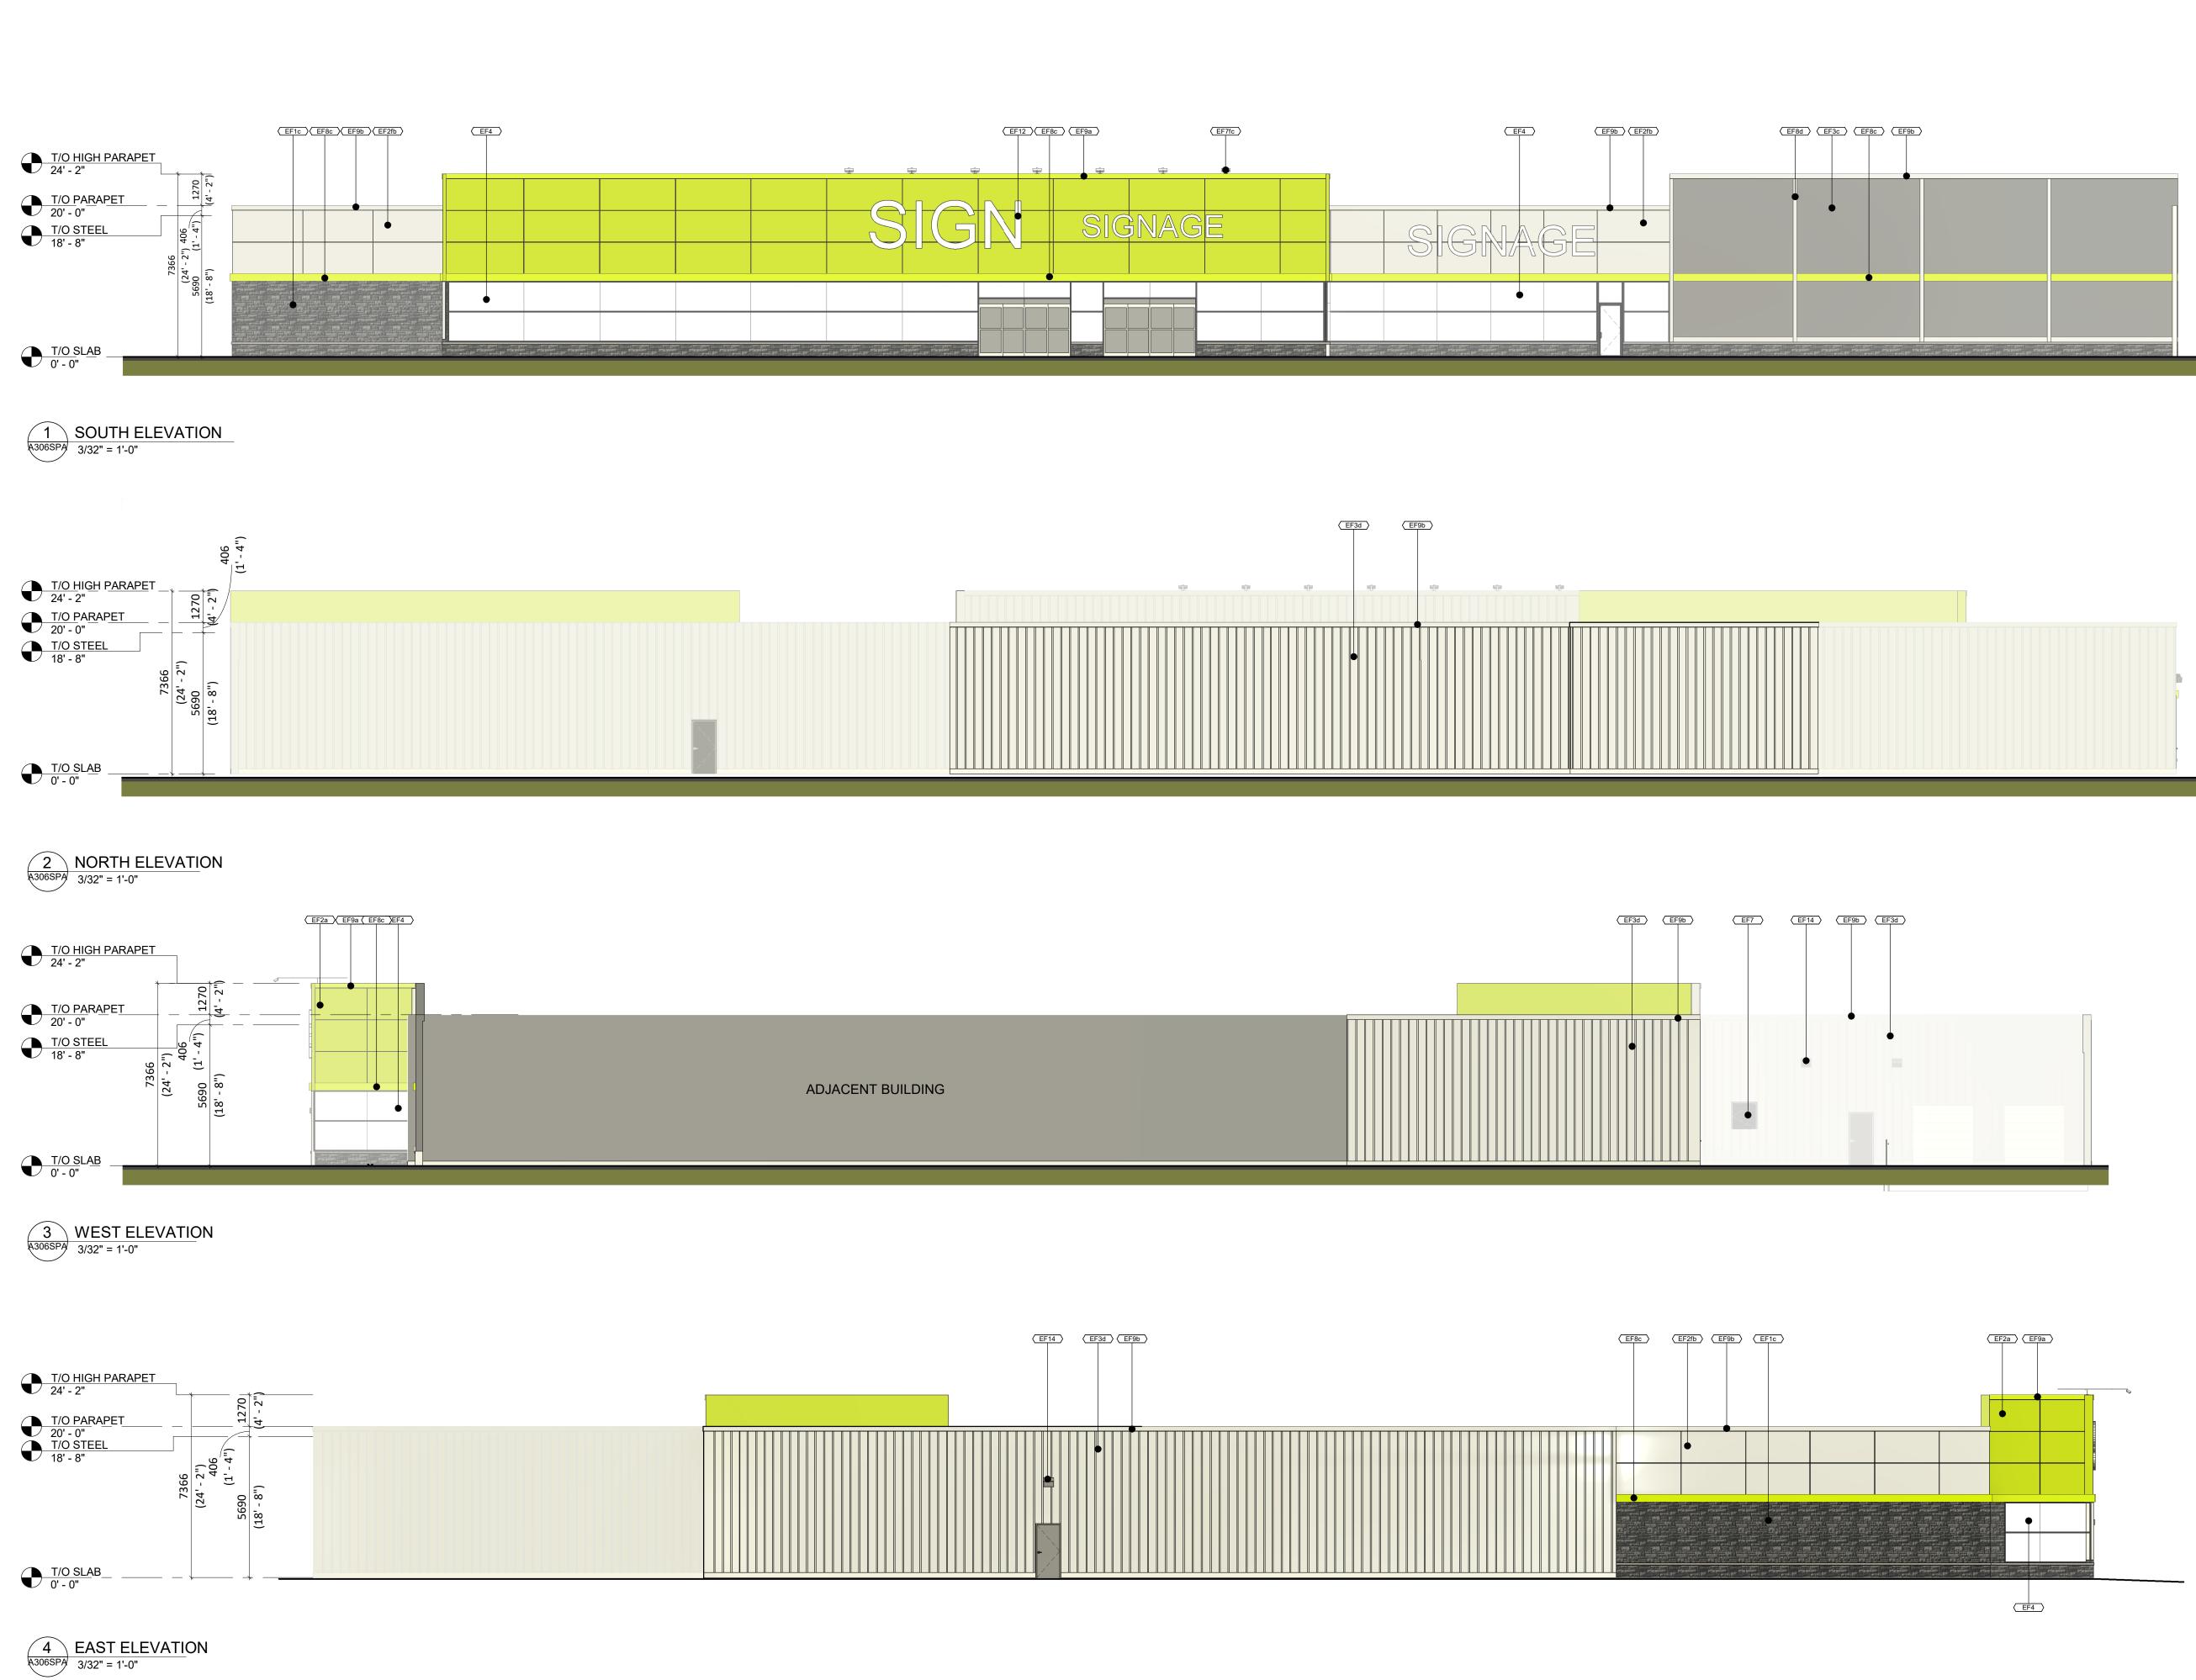


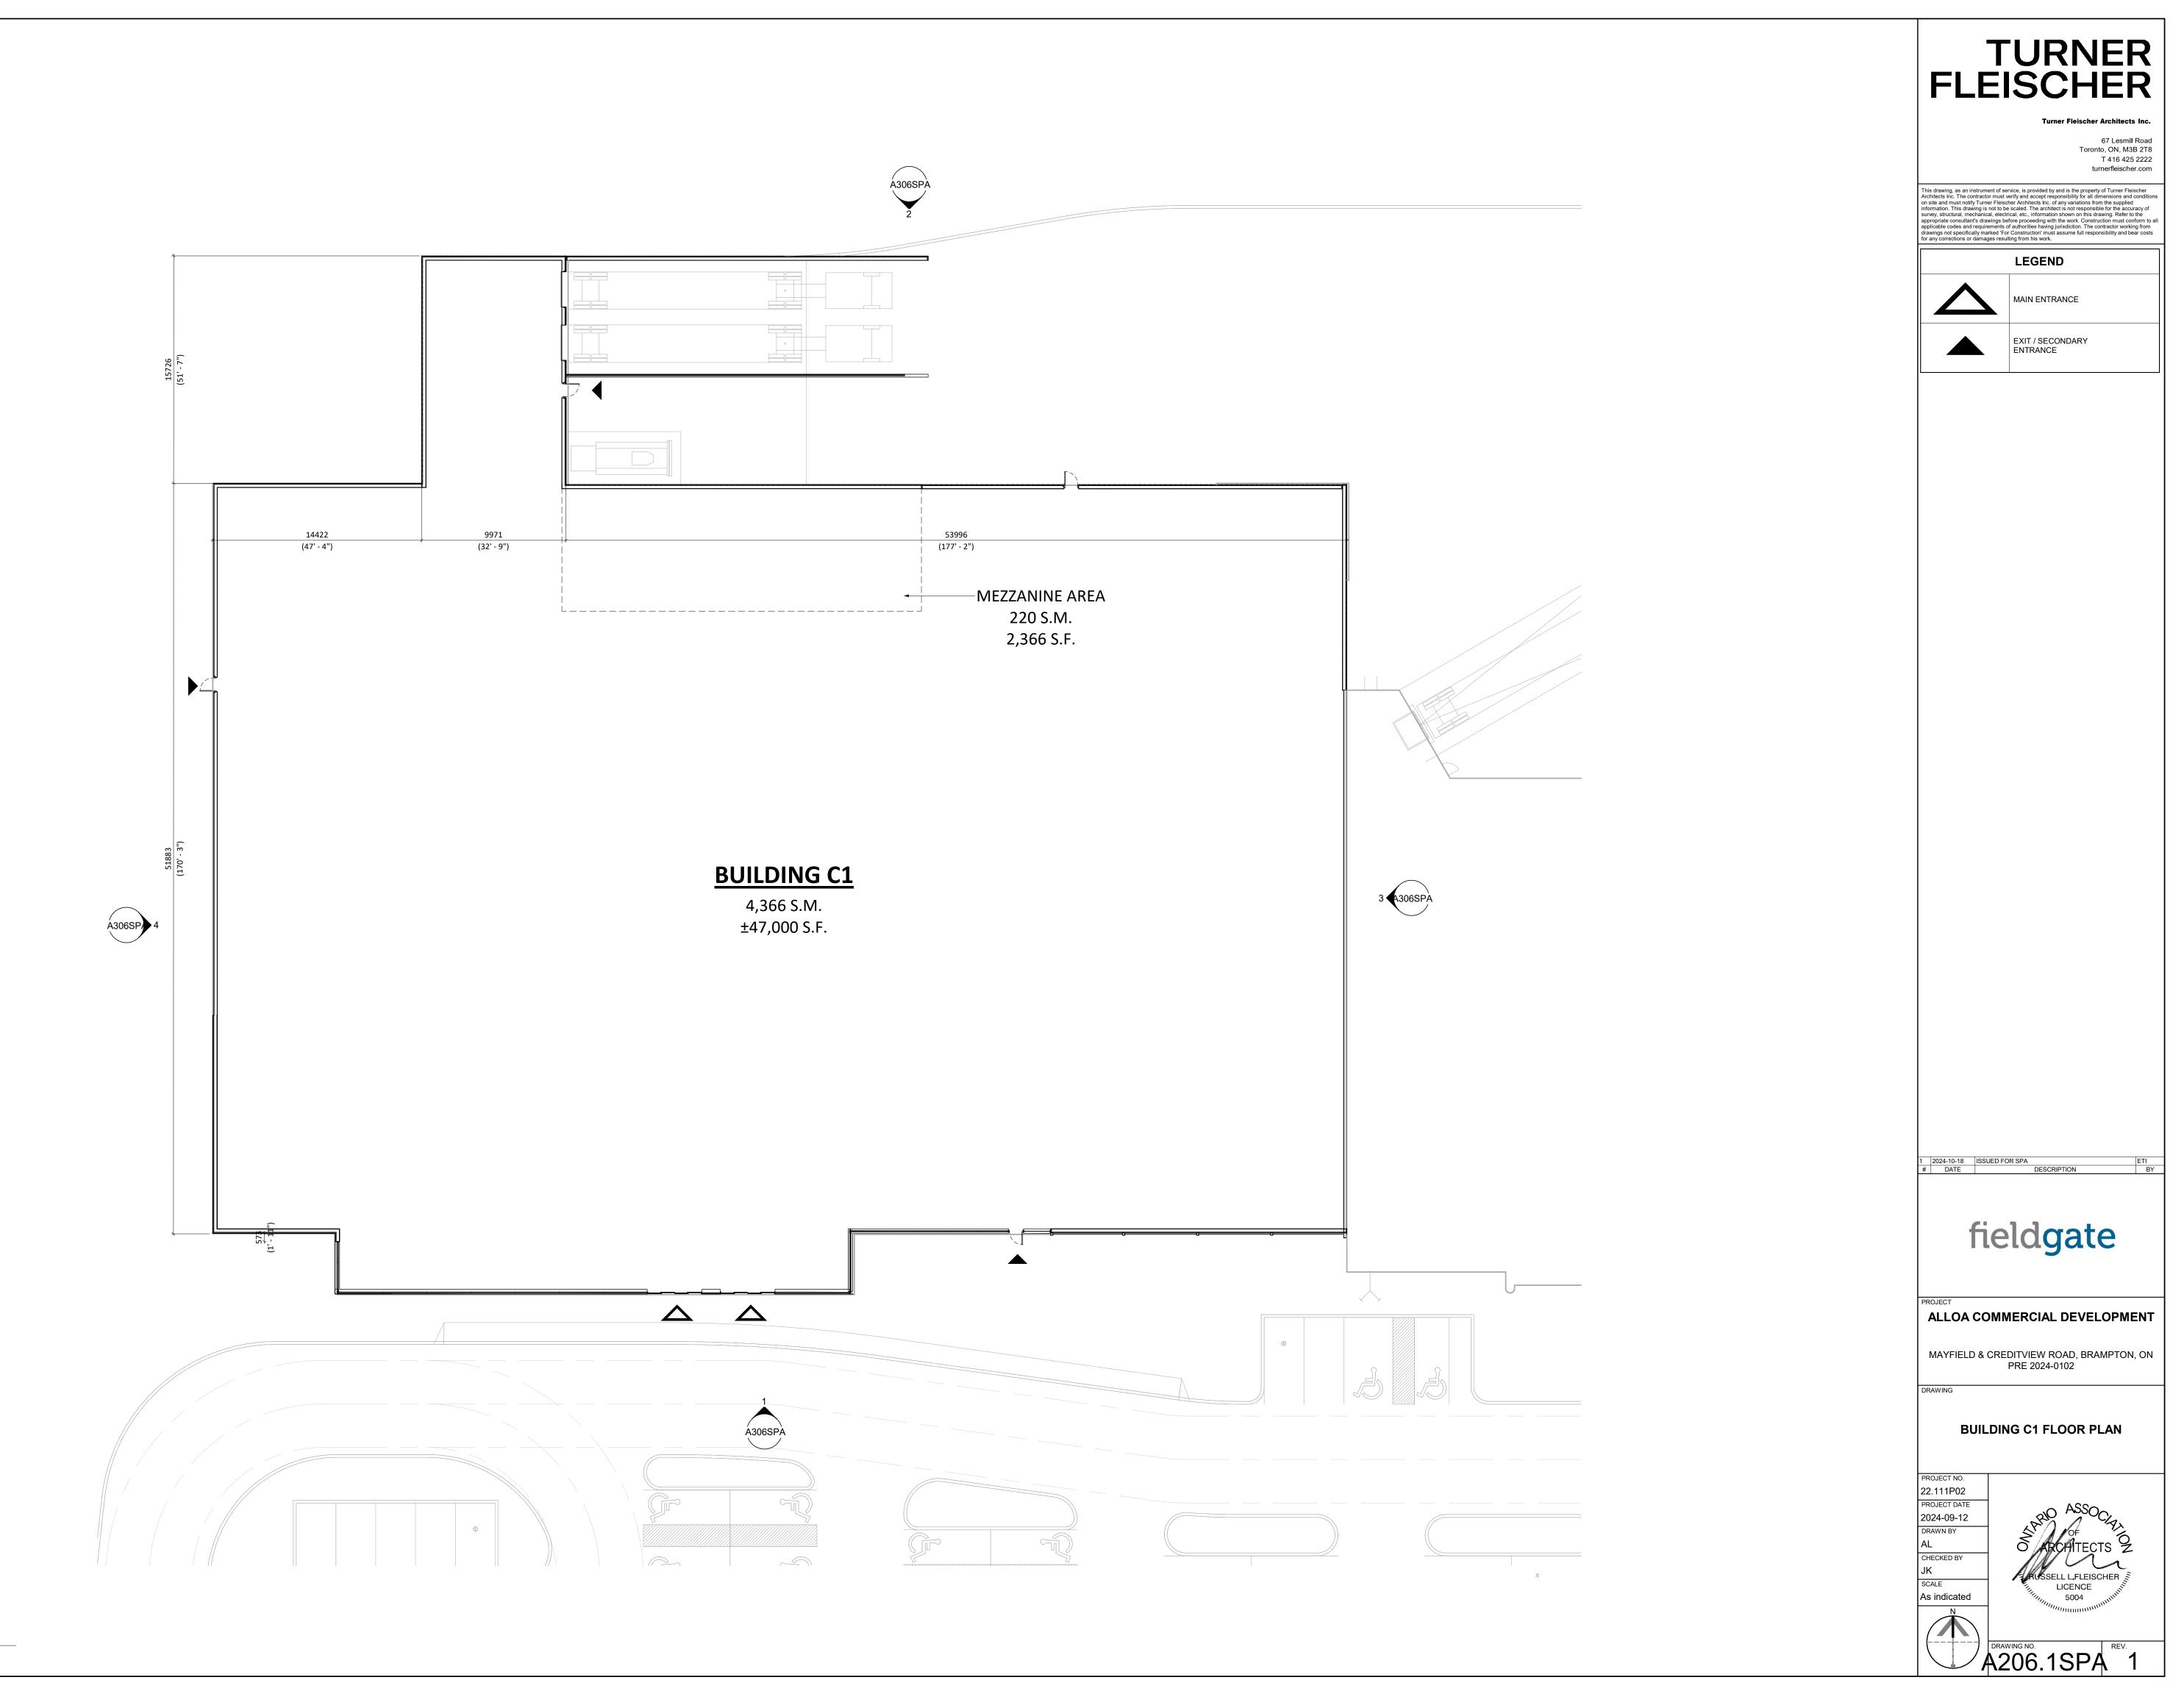1 FLOOR PLAN A206.1SPA 1/16" = 1'-0"

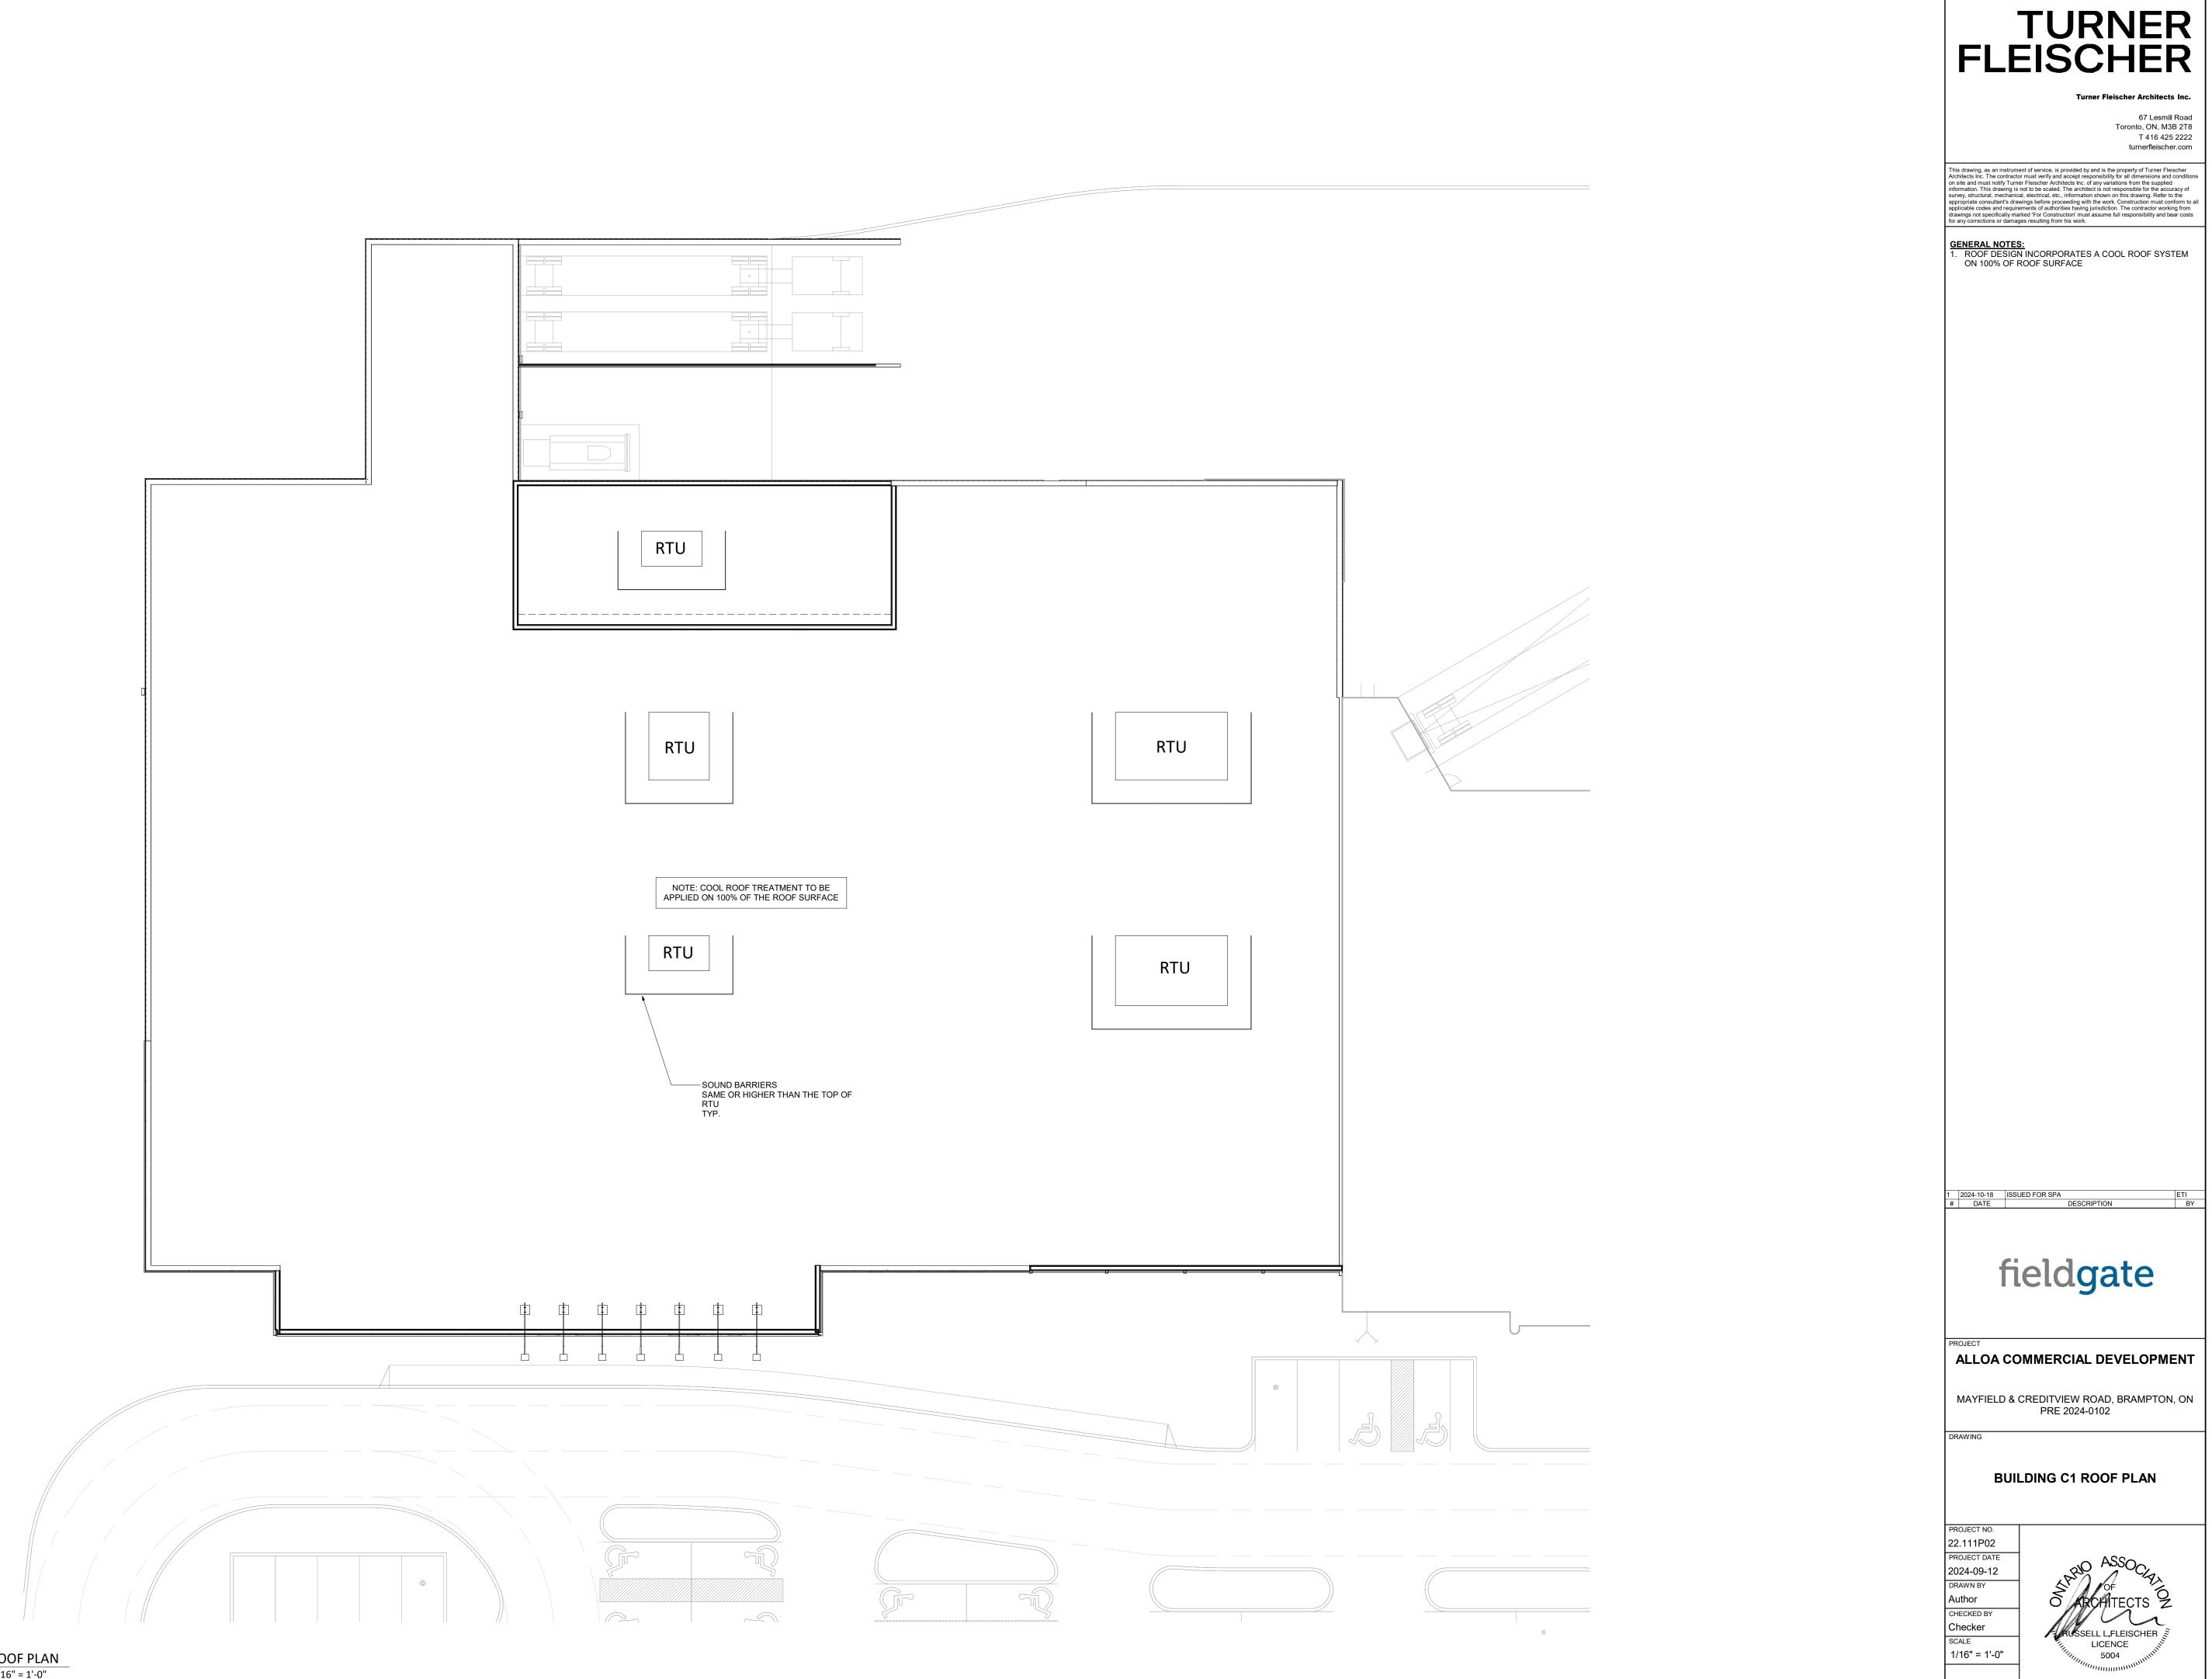

1 ROOF PLAN A206.25PA 1/16" = 1'-0"

A206.2SPA 1



	Exterior Finishes Schedule	TUDNED
MATERIAL EF1c	DESCRIPTION ARCHITECTURAL CONC BLOCK BASE: PERMACON LAFITT COLLECTION LAMINA STONE RANGE NEWPORT GREY	FLEISCHER
EF1d	PRECAST CONCRETE SILL COLOUR: NATURAL CONCRETE FINISH	
EF2a	ALUMINUM COMPOSITE PANEL: VICWEST SYSTEM 3, DRY JOINT SYSTEM, COMPOSITE ALUMINUM PANELS PPG DURANAR, COLOUR UC130570XL GREEN (TO MATCH PANTONE 382 C)	Turner Fleischer Architects Inc. 67 Lesmill Road Toronto, ON, M3B 2T8
EF2fb	ALUMINUM COMPOSITE PANEL: C/W FIRE RETARDANT CORE . VICWEST SYSTEM 3, DRY JOINT SYSTEM, COMPOSITE ALUMINUM PANELS COLOUR BONE WHITE PPG COIL CODE #5MW88026 SPRAY COAT #UC110435	T 416 425 2222 turnerfleischer.com This drawing, as an instrument of service, is provided by and is the property of Turner Fleischer Architects Inc. The contractor must verify and accept responsibility for all dimensions and conditions
EF3c	STEEL CLADDING (HORIZONTAL) PROFILE: CORRUGATED 2 2/3 X 7/8 COLOUR: VICWEST #16082 REGENT GREY	on site and must notify Turner Fleischer Architects inc. of any variations from the supplied information. This drawing is not to be scaled. The architect is not responsible for the accuracy of survey, structural, mechanical, electrical, etc., information shown on this drawing. Refer to the appropriate consultant's drawings before proceeding with the work. Construction must conform to all applicable codes and requirements of authorities having jurisdiction. The contractor working from
EF3d	STEEL CLADDING (VERTICAL) VICWEST SIDING INSTALLED VERTCALLY / PROFILE VICWEST CL6025SR COLOUR: VICWEST CAMBRIDGE WHITE #16161	drawings not specifically marked 'For Construction' must assume full responsibility and bear costs for any corrections or damages resulting from his work.
EF4	GLAZED DOORS & WINDOWS: SEALED DOUBLE GLAZED VISION GLAZING (BIRD FRIENDLY) C/W THERMALLY BROKEN CLEAR ANODIZED ALUMINUM FRAMES, HORIZONTAL CAP & VERTICAL SILICONE JOINTS TYPE C GLASS (CLEAR FLOAT GLASS) ABOVE GREEN FEATURE BAND TYPE T GLASS (CLEAR TEMPERED GLASS) BELOW GREEN FEATURE BAND	
EF7	H.M. DOORS & FRAMES: PRODUCT: PREFINISHED INSULATED HOLLOW METAL DOORS AND FRAMES PAINTED COLOUR: TO MATCH ADJACENT FIBER CEMENT PANEL	
EF8c	FEATURE BAND : 20ga PREFINISHED METAL PANEL COLOUR: UC130570XL GREEN (TO MATCH PANTONE 382 C)	
EF8d	FEATURE BAND 20ga PREFINISHED METAL PANEL COLOUR: CAMBRIDGE WHITE #16161	
EF9a	26ga PREFINISHED METAL CAP FLASHING C/W DRIP EDGE COLOUR: UC130570XL GREEN (TO MATCH PANTONE 382 C)	
EF9b	26ga PREFINISHED METAL CAP FLASHING C/W DRIP EDGE COLOUR CAMBRIDGE WHITE #16161	
EF12	EXTERIOR SIGNAGE: SIGNAGE TO BE PROVIDED BY AND INSTALLED BY TENANT. G.C. TO INSTALL 5/8" PLYWOOD BACKING FOR FUTURE MOUNTING OF SIGNAGE. SIGNAGE CONDUIT ROUGH-OUTS TO BE COORDINATED WITH TENANT.	
EF14	LIGHT FIXTURE WALL MOUNTED KEEN FLOODPACK SERIES SIZE L. 0 DEGREES MOUNTING - REFER TO ELEC. COLOUR: VICWEST #16082 REGENT GREY	



fieldgate

 2024-10-18
 ISSUED FOR SPA

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 DATE
 DESCRIPTION

ALLOA COMMERCIAL DEVELOPMENT

MAYFIELD & CREDITVIEW ROAD, BRAMPTON, ON PRE 2024-0102

BUILDING C1 ELEVATIONS


PROJECT NO. 22.111P02 PROJECT DATE 2024-09-12 DRAWN BY CHECKED BY SCALE 3/32" = 1'-0"

DRAWING



REV. 1


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	Exterior Finishes Schedule		
MATERIAL	L DESCRIPTION		
EF1s	MASONRY BLOCK: PRODUCT: RICHVALE YORK PROFILE: 3 1/2"W X 7 1/2"H X 16"L FINISH: SMOOTH FINSH COLOUR: STANDARD CONCRETE BLOCK; LIGHT GREY MORTAR: SOLOMON COLOURS INC - 60X WHITE/STANDARD GREY CONTROL JOINT AND CAULKING COLOUR TO MATCH MASONRY UNIT COLOUR.		
EF2s	EIFS (EXTERIOR INSULATED FINISH SYSTEM): PRODUCT: DRYVIT NO. SDMA-04-1030(S) (NO ALTERNATIVES WILL BE ACCEPTED) COLOUR: "SHOPPERS 2002 RED" FINISH: SANDBLAST MAINTENANCE: DEMANDIT DSC 400 SDM 'RED'		
EF3s	EIFS (EXTERIOR INSULATED FINISH SYSTEM): PRODUCT: DRYVIT NO. NA2-13-10-26-25 (NO ALTERNATIVES WILL BE ACCEPTED) COLOUR: "SHOPPERS WHITE" FINISH: SANDBLAST MAINTENANCE: DEMANDIT DSC 400 ' SHOPPERS WHITE'		
EF3sa	CORNICE AT EIFS: PRODUTCT: DRYVIT NO. NA2-13-10-26-26 (NO ALTERNATIVES WILL BE ACCEPTED) COLOUR: "CAMBRIDGE WHITE" FINISH: SANDBLAST MAINTENANCE: DEMANDIT DSC 400 'CAMBRIDGE WHITE'		
EF3sb	METAL SIDING: PRODUCT: AGWAY 6-150NF, 24 GAUGE COLOUR: "CAMBRIDGE WHITE" FINISH: PAINT		
EF5s	H.M. DOORS AND FRAMES PREFINISHED HOLLOW METAL DOORS AND FRAMES PAINT CHARCOAL		
EF6sa	GLAZED DOORS & WIDOWS: STOREFRONT GLAZING FIXED IN THERMALLY BROKEN CLEAR ANODIZED ALUMINUM FRAMING W/ SEALED CLEAR SECURITY DOUBLE GLAZING UNITS. STOREFRONT GLAZING FRAMES TO BE ALUMICOR FLUSH GLAZE BF 3400. STOREFRONT GLAZING TO BE ROCK GLASS WINDOW SECURITY SYSTEM. BIRD-FRIENDLY GLAZING (PROVIDE SAMPLE FOR APPROVAL).		
EF6sb	SPANDREL GLAZING DOORS & WINDOWS: GLAZING CLEAR ANODIZED ALUMINUM FRAMES CLEAR GLASS UNIT WITH OPACI COATING ON INBOARD SURFACE OF OUTERLITE (TEMPERED GLASS TO BE USED AT DOORS AND SIDELIGHTS), BIRD-FRIENDLY GLAZING COLOUR: OPACI-COAT RAL 7005 MOUSE GREY		
EF7s	EXPOSED CONCRETE FOUNDATION: TO BE MADE CLEAN AND FREE OF ANY FORMWORK MARKINGS. PARGE AND INFILL ANY HONEYCOMBING W/ CONCRETE SLURRY MIX. PROVIDE NATURAL SACK-RUBBED FINISH TO MATCH PANTONE #430 C 'GREY'.		
EF8s	EXTERIOR SIGNAGE: SIGNAGE TO BE PROVIDED BY AND INSTALLED BY TENANT. G.C. TO INSTALL 5/8" PLYWOOD BACKING FOR FUTURE MOUNTING OF SIGNAGE. SIGNAGE CONDUIT ROUGH-OUTS TO BE COORDINATED WITH TENANT.		
EF9s	LIGHT FIXTURES: EXTERIOR WALL MOUNTED LED BOX - REFER TO ELEC. C/W 5/8" EXTERIOR GRADE PLYWOOD BACKING		

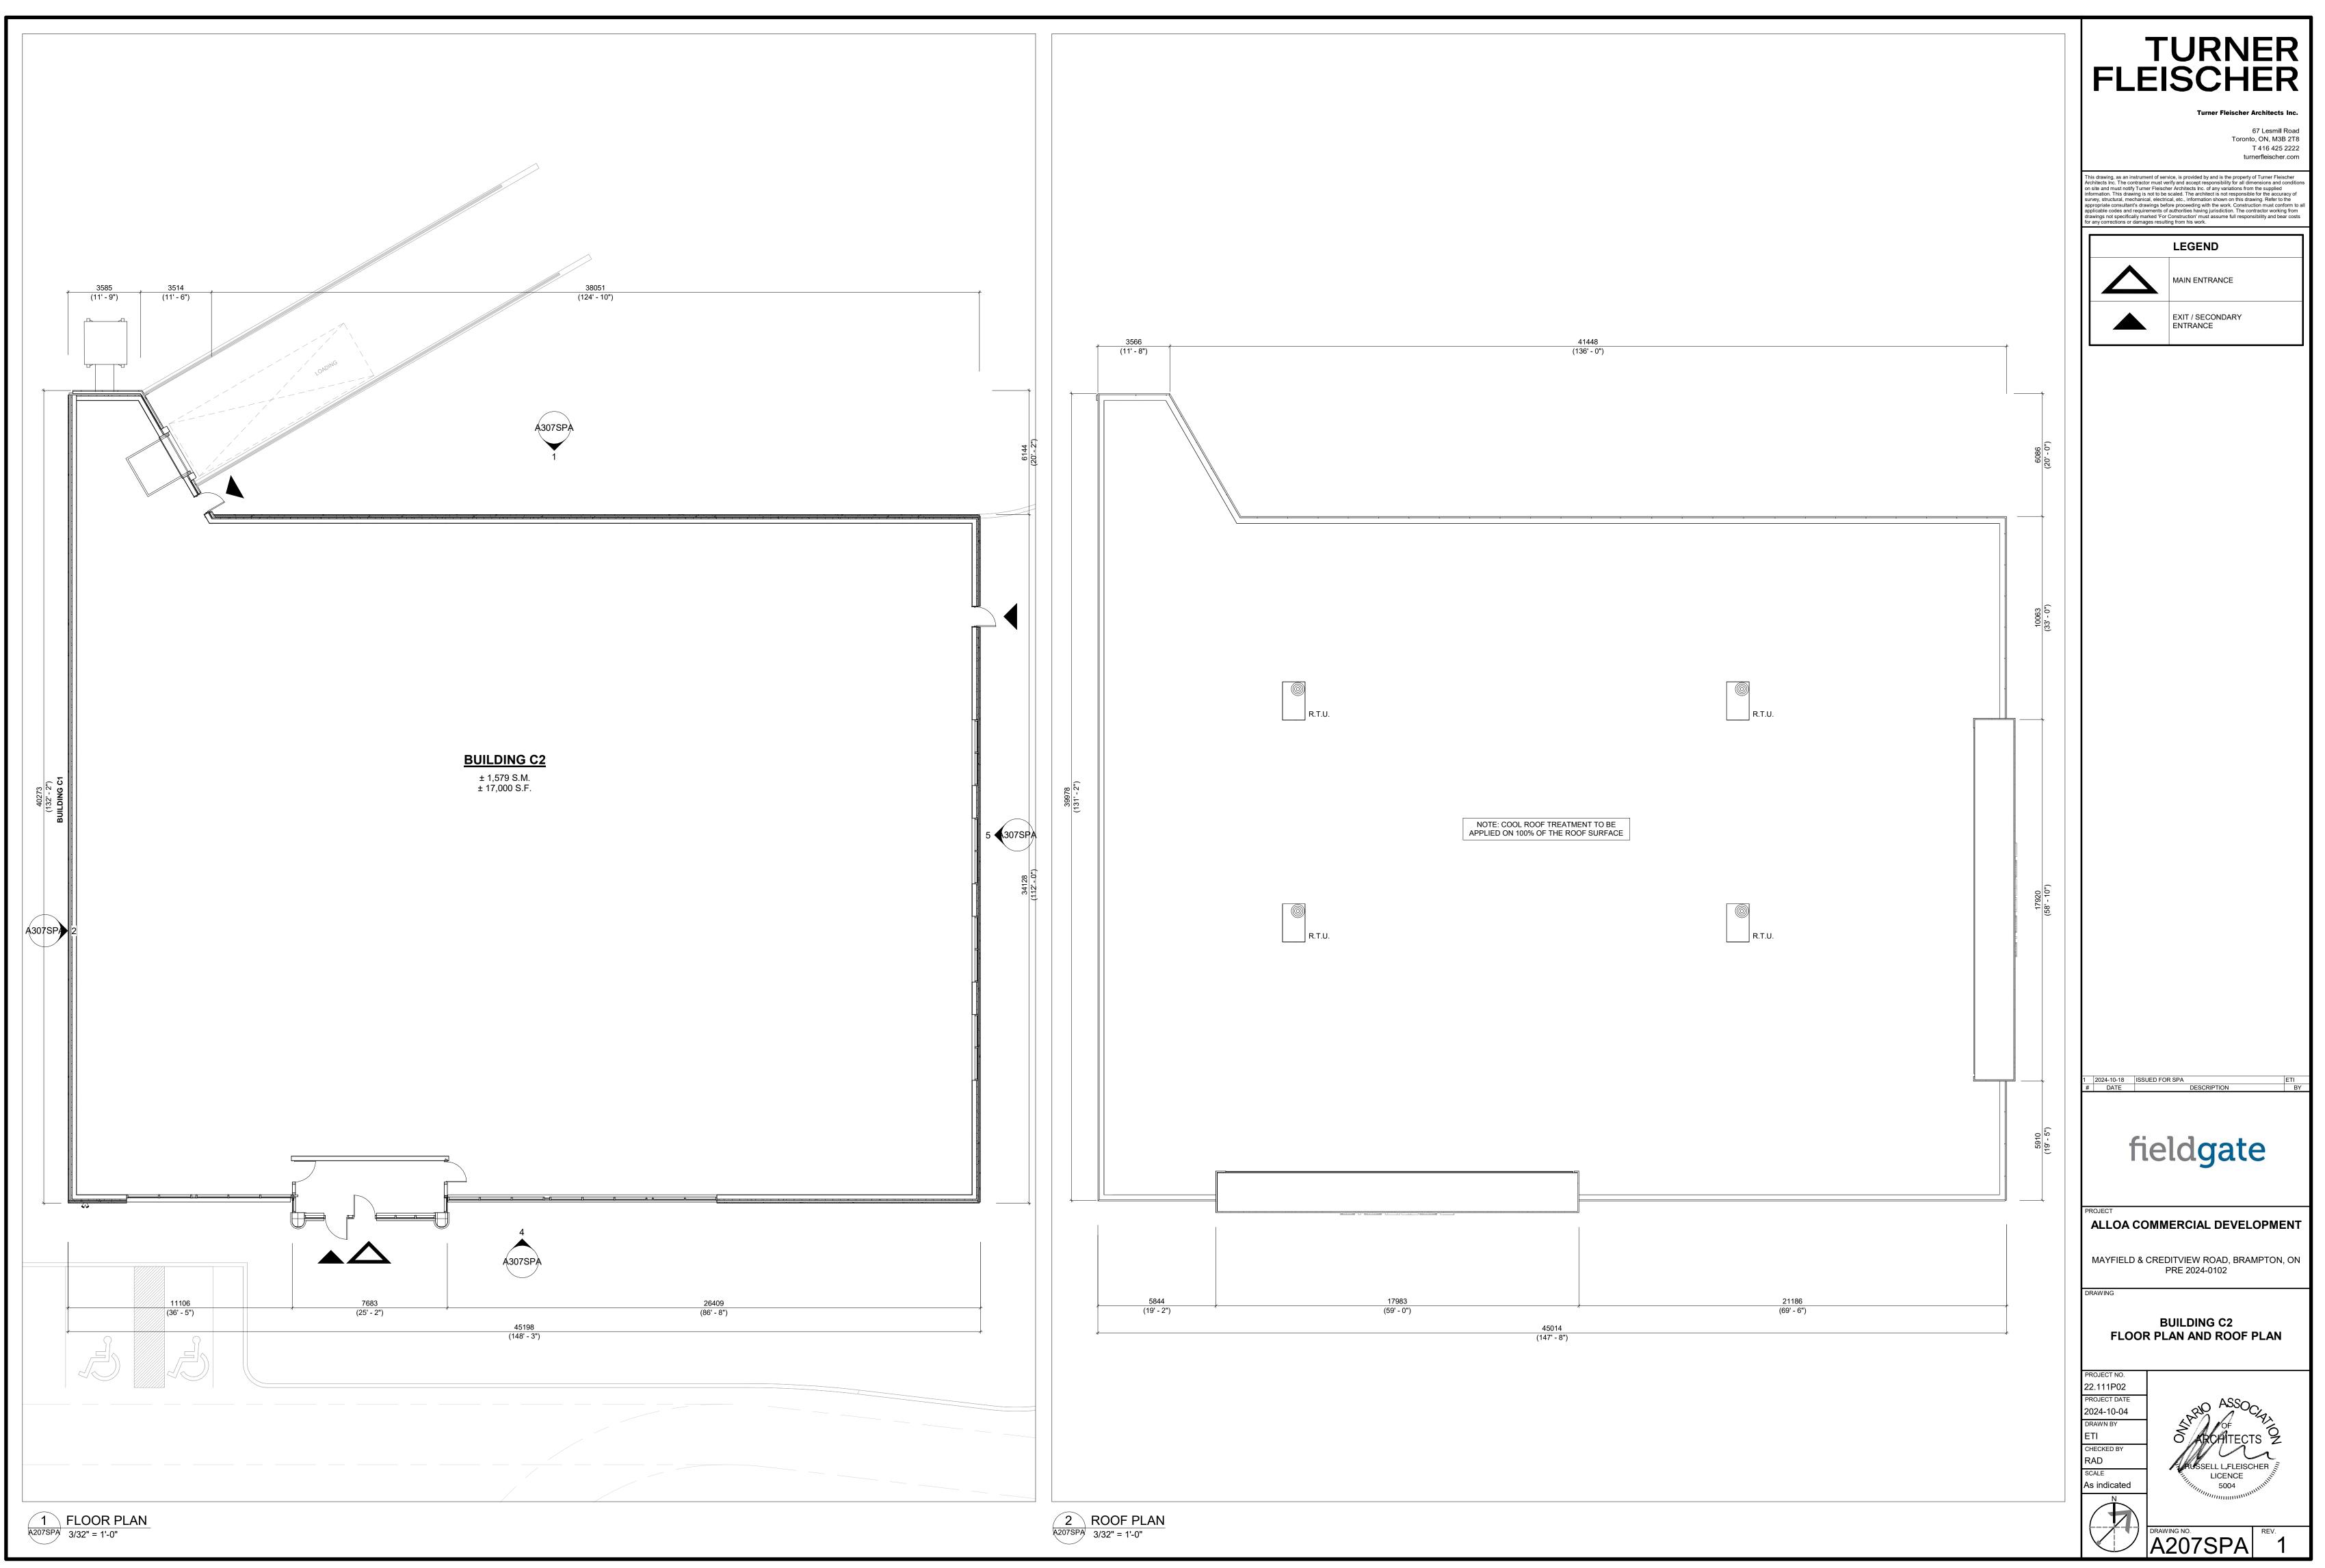

TURNER FLEISCHER

Turner Fleischer Architects Inc.


ALLOA COMMERCIAL DEVELOPMENT

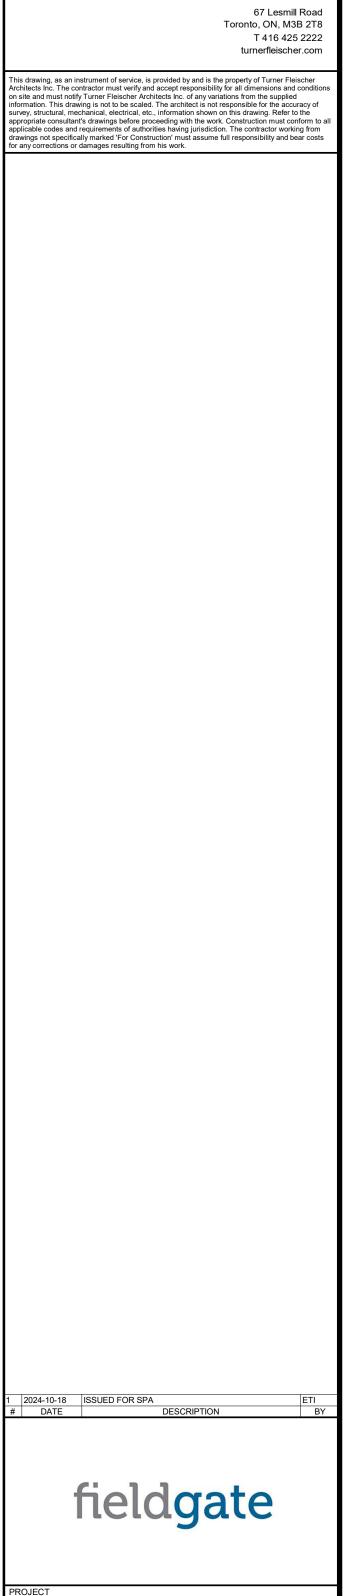
MAYFIELD & CREDITVIEW ROAD, BRAMPTON, ON PRE 2024-0102

BUILDING C2 ELEVATIONS

PROJECT NO. 22.111P02 PROJECT DATE 2024-10-04 DRAWN BY ETI CHECKED BY RAD SCALE 1/8" = 1'-0"

RAWING

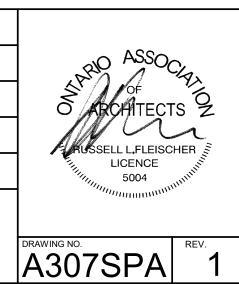

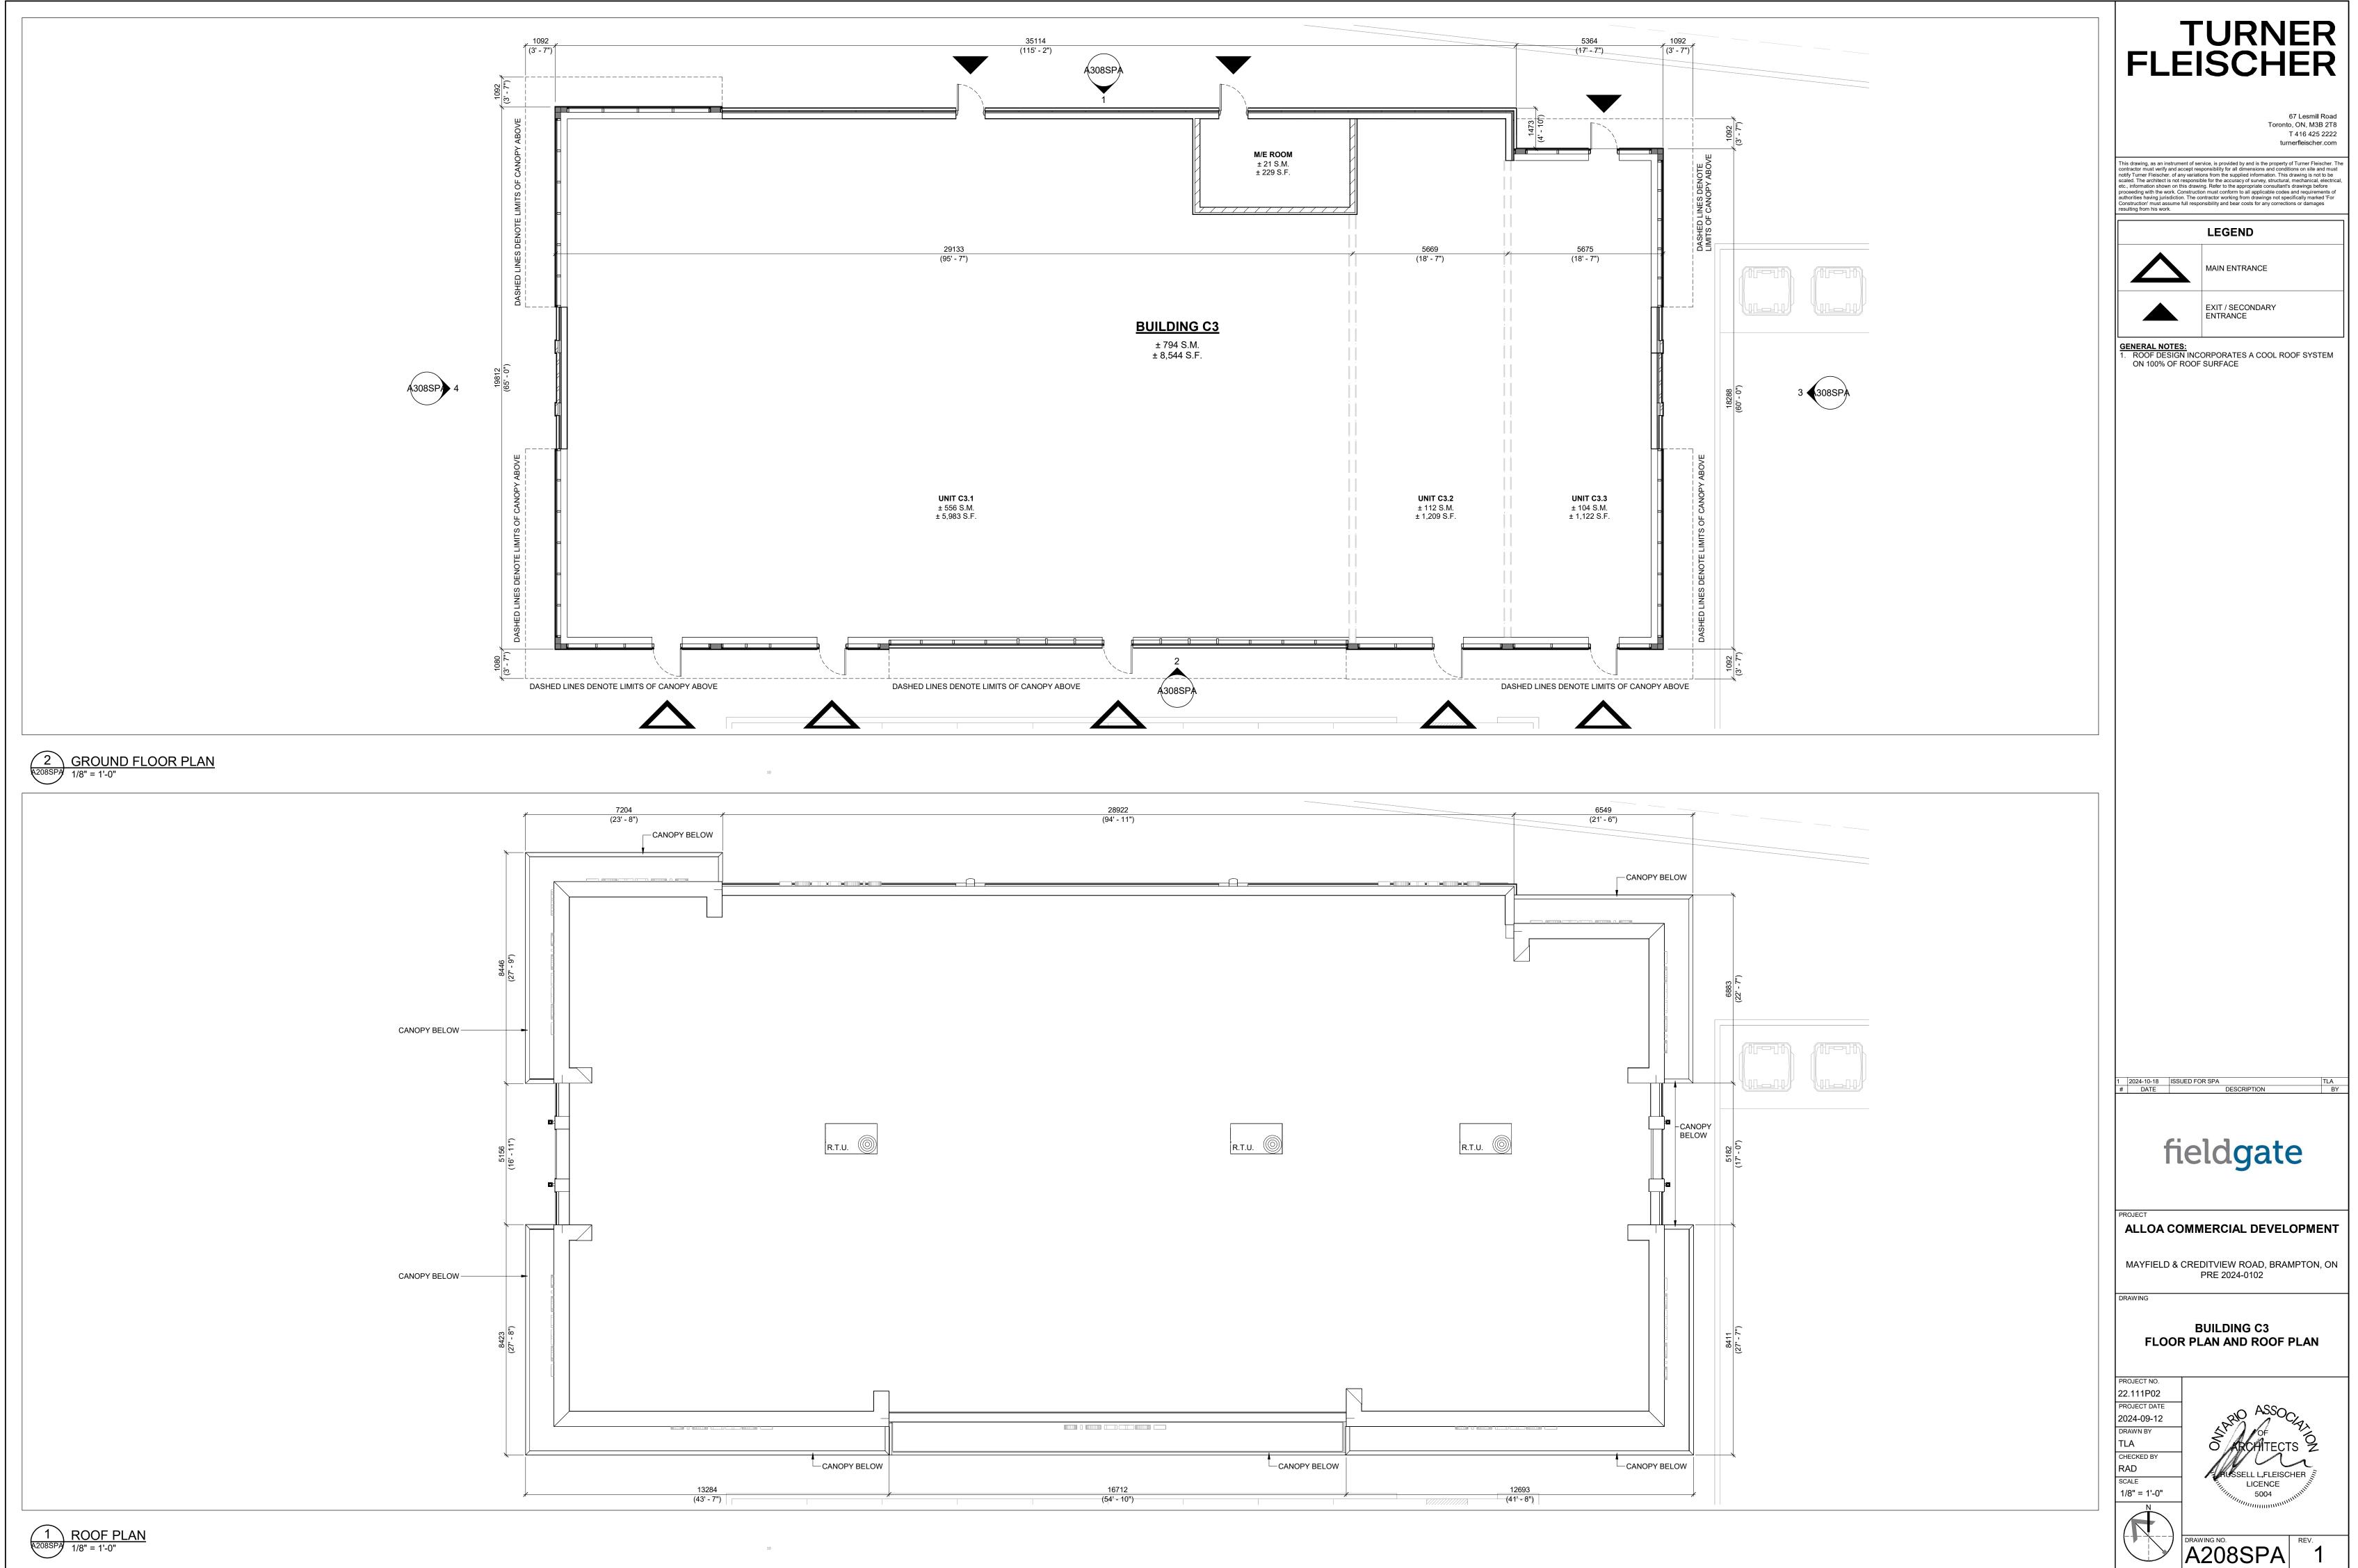

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	CA
16712	,12693
(54' - 10")	(41' - 8")



	Exterior Finishes Schedule	TURNER
MATERIAL	DESCRIPTION	
EF1a	ARCHITECTURAL CONCRETE BLOCK: PRODUCT: SHOULDICE ARCHITECTURAL CONCRETE BLOCK PROFILE: DIMENSIONAL STONE 3 1/2"W x 7 1/2"H x 23 1/4"L FINISH: TAPESTRY COLOUR: COLBY MORTAR: SOLOMON 97A SUPER BLACK CONTROL JOINT AND CAULKING COLOUR TO MATCH MASONRY UNIT COLOUR.	FLEISCHER 67 Lesmil Road
EF1b	CONCRETE PRECAST SILLS: PRODUCT: SHOULDICE CONCRETE SILL PROFILE: 424 SLOPED SILL WITH DRIP EDGE - 5 1/2"W X 3/2"H COLOUR: COLBY (COLOUR TO MATCH BLOCK BELOW) FINISH: TAPESTRY	Toronto, ON, M3B 2T8 T 416 425 2222 turnerfleischer.com
EF2a	BRICK: PRODUCT: SHOULDICE - BRICK PROFILE: URBAN - 3 1/2"W x 2 1/4"H x 15 5/8" L COLOUR: SMOOTH POLAR MORTAR: SOLOMON COLOURS INC - 60A WHITE CAULKING COLOURS TO MATCH MASONRY UNIT COLOUR.	This drawing, as an instrument of service, is provided by and is the property of Turner Fleischer. The contractor must verify and accept responsibility for all dimensions and conditions on site and must notify Turner Fleischer. of any variations from the supplied information. This drawing is not to be scaled. The architect is not responsible for the accuracy of survey, structural, mechanical, electrical, etc., information shown on this drawing. Refer to the appropriate consultant's drawings before proceeding with the work. Construction must conform to all applicable codes and requirements of authorities having jurisdiction. The contractor working from drawings not specifically marked 'For Construction' must assume full responsibility and bear costs for any corrections or damages resulting from his work.
EF2b	BRICK: PRODUCT: SHOULDICE - BRICK PROFILE: URBAN - 3 1/2"W x 2 1/4"H x 15 5/8" L COLOUR: SMOOTH GALAXY MORTAR: SOLOMON COLOURS INC - 94X IRON BLACK CAULKING COLOURS TO MATCH MASONRY UNIT COLOUR.	
EF3a	FIBER CEMENT SIDING: PRODUCT: EQUITONE LINEA PROFILE: THICKNESS 10 mm - PANEL SIZE 3050 x 1220 mm FINISH: LINEA COLOUR: LT85 (DARK GREY)	
EF3b	FIBER CEMENT SIDING: PRODUCT: EQUITONE TECTIVA PROFILE: THICKNESS 10 mm - PANEL SIZE 3050 x 1220 mm FINISH: TECTIVA COLOUR: TE85 (GRAPHITE)	
EF4	GLAZED DOORS & WINDOWS: BLACK ANODIZED ALUMINUM FRAMES, CAP LESS MULLIONS, CAPPED TRANSOMS TEMPERED CLEAR INSULATED VISION GLASS / LOW-E GLAZING, LOW IRON GLAZING, BIRD-FRIENDLY GLAZING	
EF5	SPANDREL GLAZING DOORS & WINDOWS: BLACK ANODIZED ALUMINUM FRAMES, TEMPERED CLEAR INSULATED VISION GLASS / LOW-E GLAZING, LOW IRON GLAZING C/W INSULATED BACKPAN, BIRD-FRIENDLY GLAZING. COLOUR: OPACI-COAT RAL 7005 MOUSE GREY	
EF6	CURTAIN WALL ALUMINUM / FILLER PANEL: PRODUCT: 1/8" ANODIZED ALUMINUM PANEL, LAMINATED TO RIGID INSULATION AND GALVANIZED METAL SHEET, INTERIOR FINISHED W/ STUDS AND GYPSUM BOARD COLOUR: BLACK	
EF7	H.M. DOORS & FRAMES: PRODUCT: PREFINISHED INSULATED HOLLOW METAL DOORS AND FRAMES PAINTED COLOUR: TO MATCH ADJACENT FIBER CEMENT PANEL	
EF8a	CANOPIES FASCIA - ALUMINUM COMPOSITE PANEL: PRODUCT: ALPOLIC MATTE PROFILE: 2 1/4" ACM SYSTEM W/ 1/2" DRY JOINTS BETWEEN PANELS COLOUR: BSM SLATE BLACK	
EF8b	CANOPIES SOFFIT - ALUMINUM COMPOSITE PANEL: PRODUCT: LONGBOARD TONGUE & GROOVE PLANKS FOR SOFFIT PROFILE: SMOOTH 6" ACM COLOUR: WOODGRAIN LIGHT NATIONAL WALNUT C/W LINEAR LED LIGHTING ALIGNED WITH PLANK ORIENTATION. REFER TO ELECTRICAL DRAWINGS	
EF9	PREFINISHED METAL CAP FLASHING: PRE-FINISHED 16 GA. METAL FLASHING COLOUR: BLACK	
EF11	LIGHT FIXTURES EXTERIOR WALL MOUNTED LED BOX - REFER TO ELEC. C/W 5/8" EXTERIOR GRADE PLYWOOD BACKING	
EF12	EXTERIOR SIGNAGE: SIGNAGE TO BE PROVIDED BY AND INSTALLED BY TENANT. G.C. TO INSTALL 5/8" PLYWOOD BACKING FOR FUTURE MOUNTING OF SIGNAGE. SIGNAGE CONDUIT ROUGH-OUTS TO BE COORDINATED WITH TENANT.	
EF13	HIGH PARAPET (ROOF SIDE) - CORRUGATED METAL SIDING: PRODUCT: AGWAY WALL CLADDING PROFILE: 6-150 F COLOUR: BLACK / NOIR (QC 28262) FINISH: STANDARD	

fieldgate

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 2024-10-18
 ISSUED FOR SPA

 #
 DATE
 DESCRIPTION

ALLOA COMMERCIAL DEVELOPMENT

MAYFIELD & CREDITVIEW ROAD, BRAMPTON, ON PRE 2024-0102


BUILDING C3 ELEVATIONS


PROJECT NO. 22.111P02 PROJECT DATE 2024-09-12 DRAWN BY RLA CHECKED BY RAD SCALE 1/8" = 1'-0"

DRAWING



A308SPA 1

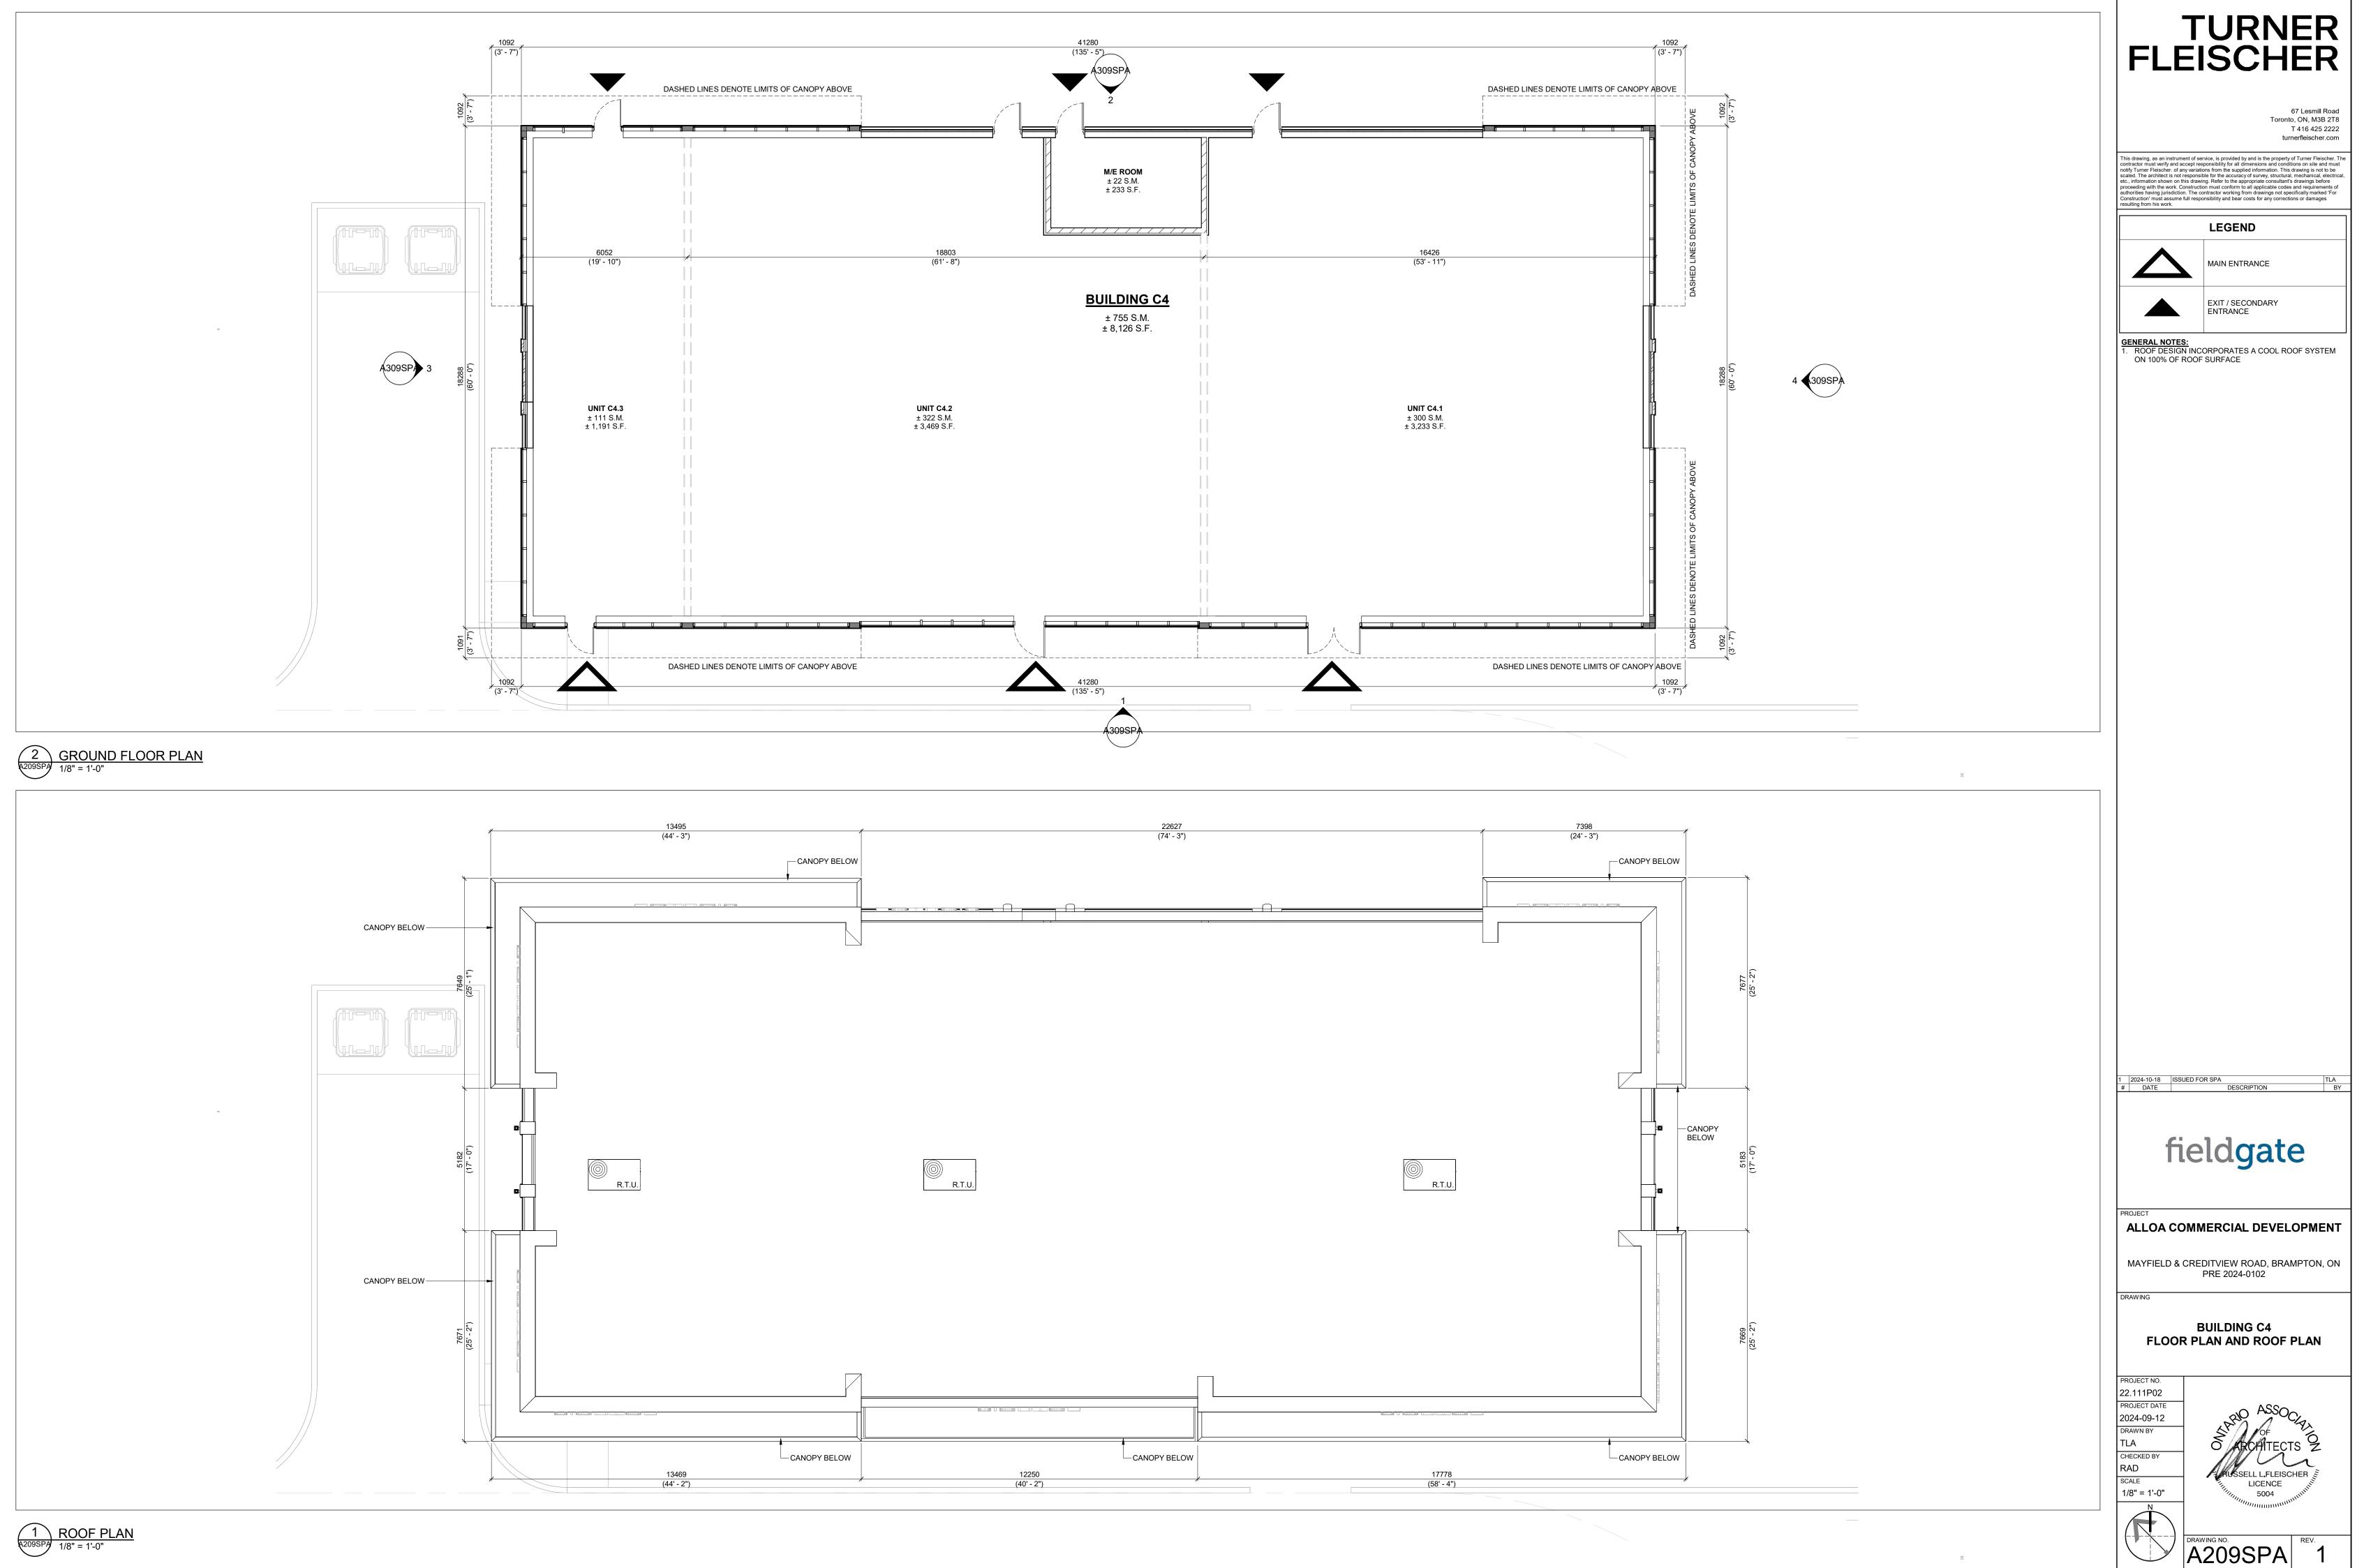

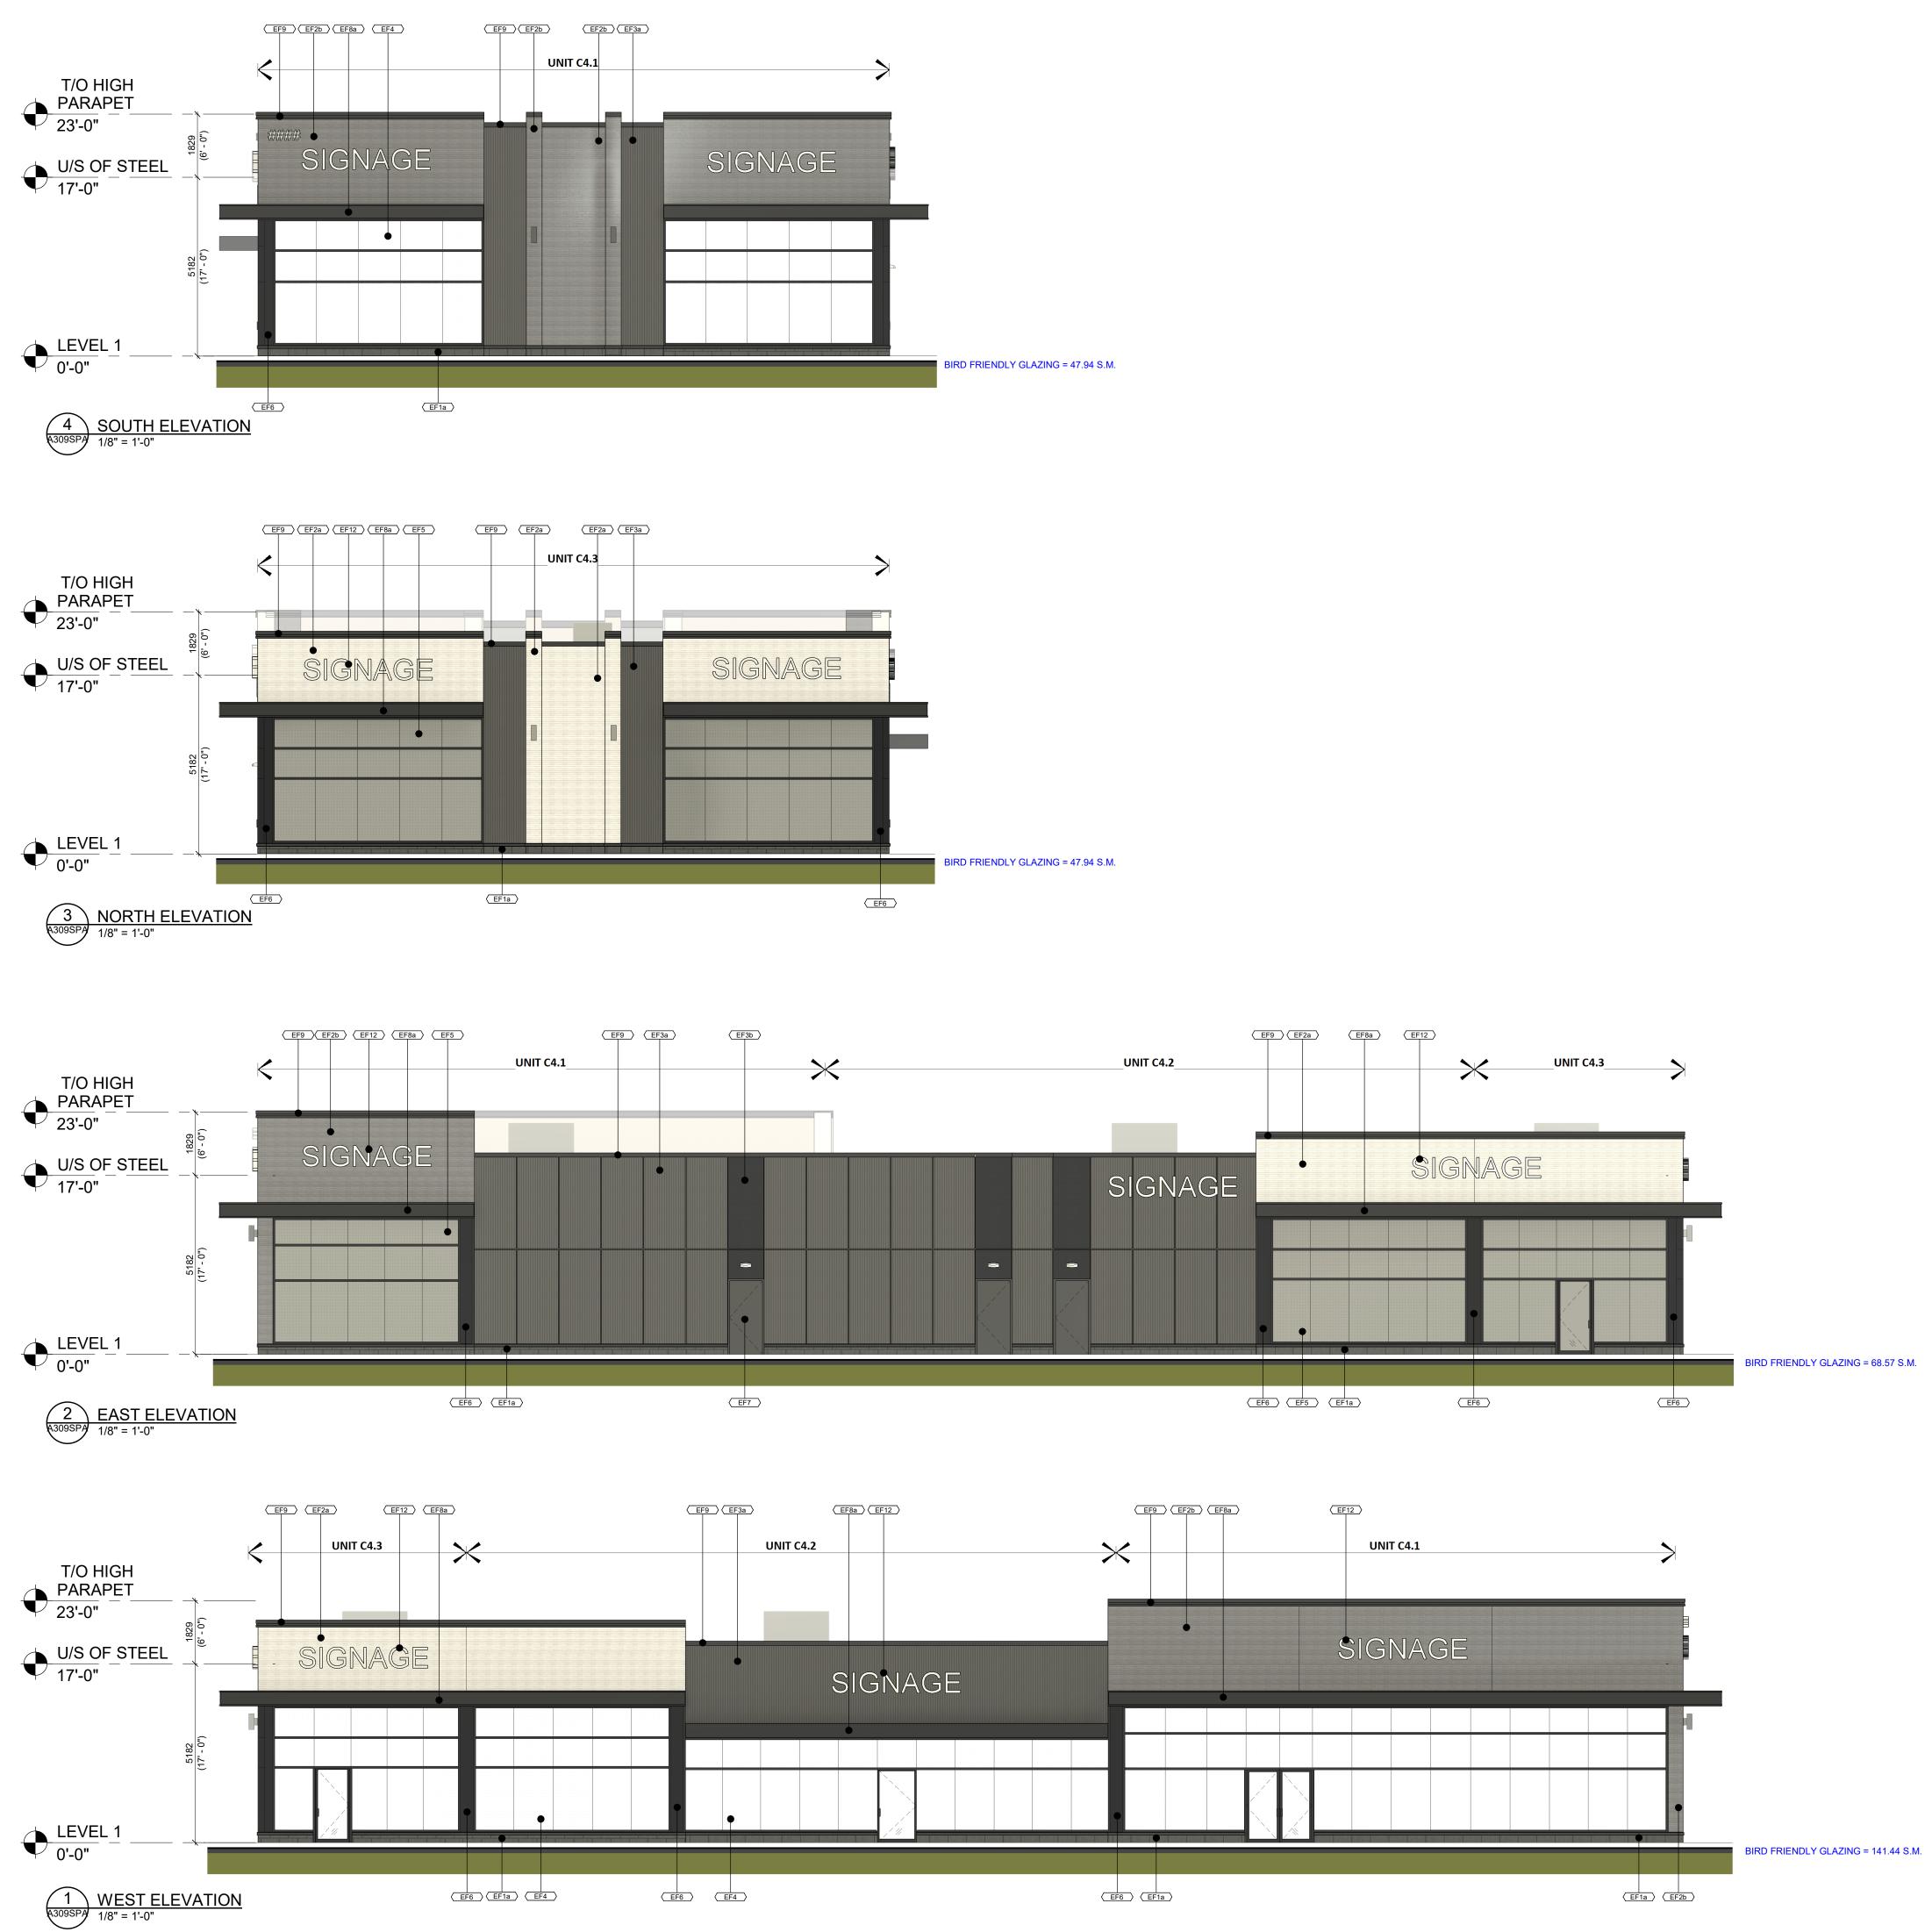

	Exterior Finishes Schedule	TURNER
MATERIAL	DESCRIPTION	
EF1a	ARCHITECTURAL CONCRETE BLOCK: PRODUCT: SHOULDICE ARCHITECTURAL CONCRETE BLOCK PROFILE: DIMENSIONAL STONE 3 1/2"W x 7 1/2"H x 23 1/4"L FINISH: TAPESTRY COLOUR: COLBY MORTAR: SOLOMON 97A SUPER BLACK CONTROL JOINT AND CAULKING COLOUR TO MATCH MASONRY UNIT COLOUR.	FLEISCHER 67 Lesmil Road
EF1b	CONCRETE PRECAST SILLS: PRODUCT: SHOULDICE CONCRETE SILL PROFILE: 424 SLOPED SILL WITH DRIP EDGE - 5 1/2"W X 3/2"H COLOUR: COLBY (COLOUR TO MATCH BLOCK BELOW) FINISH: TAPESTRY	Toronto, ON, M3B 2T8 T 416 425 2222 turnerfleischer.com
EF2a	BRICK: PRODUCT: SHOULDICE - BRICK PROFILE: URBAN - 3 1/2"W x 2 1/4"H x 15 5/8" L COLOUR: SMOOTH POLAR MORTAR: SOLOMON COLOURS INC - 60A WHITE CAULKING COLOURS TO MATCH MASONRY UNIT COLOUR.	This drawing, as an instrument of service, is provided by and is the property of Turner Fleischer. The contractor must verify and accept responsibility for all dimensions and conditions on site and must notify Turner Fleischer. of any variations from the supplied information. This drawing is not to be scaled. The architect is not responsible for the accuracy of survey, structural, mechanical, electrical etc., information shown on this drawing. Refer to the appropriate consultant's drawings before proceeding with the work. Construction must conform to all applicable codes and requirements of authorities having jurisdiction. The contractor working from drawings not specifically marked 'For Construction' must assume full responsibility and bear costs for any corrections or damages resulting from his work.
EF2b	BRICK: PRODUCT: SHOULDICE - BRICK PROFILE: URBAN - 3 1/2"W x 2 1/4"H x 15 5/8" L COLOUR: SMOOTH GALAXY MORTAR: SOLOMON COLOURS INC - 94X IRON BLACK CAULKING COLOURS TO MATCH MASONRY UNIT COLOUR.	
EF3a	FIBER CEMENT SIDING: PRODUCT: EQUITONE LINEA PROFILE: THICKNESS 10 mm - PANEL SIZE 3050 x 1220 mm FINISH: LINEA COLOUR: LT85 (DARK GREY)	
EF3b	FIBER CEMENT SIDING: PRODUCT: EQUITONE TECTIVA PROFILE: THICKNESS 10 mm - PANEL SIZE 3050 x 1220 mm FINISH: TECTIVA COLOUR: TE85 (GRAPHITE)	
EF4	GLAZED DOORS & WINDOWS: BLACK ANODIZED ALUMINUM FRAMES, CAP LESS MULLIONS, CAPPED TRANSOMS TEMPERED CLEAR INSULATED VISION GLASS / LOW-E GLAZING, LOW IRON GLAZING, BIRD-FRIENDLY GLAZING	
EF5	SPANDREL GLAZING DOORS & WINDOWS: BLACK ANODIZED ALUMINUM FRAMES, TEMPERED CLEAR INSULATED VISION GLASS / LOW-E GLAZING, LOW IRON GLAZING C/W INSULATED BACKPAN, BIRD-FRIENDLY GLAZING. COLOUR: OPACI-COAT RAL 7005 MOUSE GREY	
EF6	CURTAIN WALL ALUMINUM / FILLER PANEL: PRODUCT: 1/8" ANODIZED ALUMINUM PANEL, LAMINATED TO RIGID INSULATION AND GALVANIZED METAL SHEET, INTERIOR FINISHED W/ STUDS AND GYPSUM BOARD COLOUR: BLACK	
EF7	H.M. DOORS & FRAMES: PRODUCT: PREFINISHED INSULATED HOLLOW METAL DOORS AND FRAMES PAINTED COLOUR: TO MATCH ADJACENT FIBER CEMENT PANEL	
EF8a	CANOPIES FASCIA - ALUMINUM COMPOSITE PANEL: PRODUCT: ALPOLIC MATTE PROFILE: 2 1/4" ACM SYSTEM W/ 1/2" DRY JOINTS BETWEEN PANELS COLOUR: BSM SLATE BLACK	
EF8b	CANOPIES SOFFIT - ALUMINUM COMPOSITE PANEL: PRODUCT: LONGBOARD TONGUE & GROOVE PLANKS FOR SOFFIT PROFILE: SMOOTH 6" ACM COLOUR: WOODGRAIN LIGHT NATIONAL WALNUT C/W LINEAR LED LIGHTING ALIGNED WITH PLANK ORIENTATION. REFER TO ELECTRICAL DRAWINGS	
EF9	PREFINISHED METAL CAP FLASHING: PRE-FINISHED 16 GA. METAL FLASHING COLOUR: BLACK	
EF11	LIGHT FIXTURES EXTERIOR WALL MOUNTED LED BOX - REFER TO ELEC. C/W 5/8" EXTERIOR GRADE PLYWOOD BACKING	
EF12	EXTERIOR SIGNAGE: SIGNAGE TO BE PROVIDED BY AND INSTALLED BY TENANT. G.C. TO INSTALL 5/8" PLYWOOD BACKING FOR FUTURE MOUNTING OF SIGNAGE. SIGNAGE CONDUIT ROUGH-OUTS TO BE COORDINATED WITH TENANT.	
EF13	HIGH PARAPET (ROOF SIDE) - CORRUGATED METAL SIDING: PRODUCT: AGWAY WALL CLADDING PROFILE: 6-150 F COLOUR: BLACK / NOIR (QC 28262) FINISH: STANDARD	

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ALLOA COMMERCIAL DEVELOPMENT

MAYFIELD & CREDITVIEW ROAD, BRAMPTON, ON PRE 2024-0102

DRAWING

BUILDING C4 ELEVATIONS

PROJECT NO. 22.111P02 PROJECT DATE 2024-09-12 DRAWN BY RLA CHECKED BY RAD SCALE 1/8" = 1'-0"



A309SPA 1



ELEVATION PERSPECTIVE - BUILDING B2 (SOUTH)



EXTERIOR PERSPECTIVE - BUILDING B2 AND B3 (SOUTH)



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EXTERIOR PERSPECTIVE - BUILDING B3 (NORTH)
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SITE ENTRANCE EXTERIOR PERSPECTIVE - BUILDING B1 (SOUTH-WEST)



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PROJECT ALLOA COMMERCIAL DEVELOPMENT

MAYFIELD & CREDITVIEW ROAD, BRAMPTON, ON PRE 2024-0102

BUILDING PERSPECTIVES

PROJECT NO. 22.111P02 PROJECT DATE 2024-09-12 DRAWN BY TLA CHECKED BY RAD SCALE

RAWING



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