


# TOWN OF CALEDON **PLANNING** RECEIVED

November 27, 2024





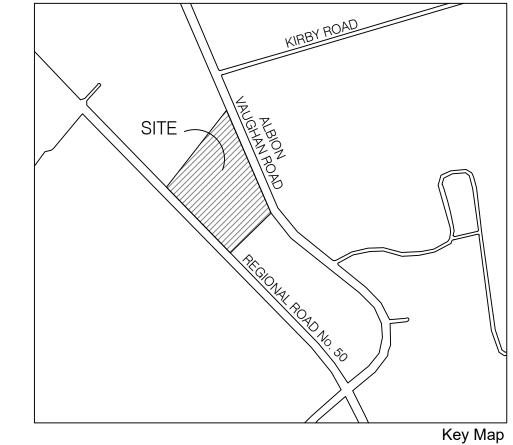

170 The Donway W Suite 206. Toronto, Ontario, Canada. M3C 2G3 tel. 416.492.9966 | email. info@msla.ca



416-806-7000 FCORTESE@FCARCHITECTS.CA



SPA No.: **SPA 2021-0004** 

Proposed Residential Development

# 12148 ALBION-VAUGHAN RD


ISSUED FOR SUBMISSION


# **Drawing List**

L0-00	Cover Page	LD-01	Landscape Details
		LD-02	Landscape Details
L1-01	Landscape Master Plan	LD-03	Landscape Details
L1-02	North Enlargement Plan	LD-04	Landscape Details
L1-03	South Enlargement Plan	LD-05	Landscape Details
		LD-06	Landscape Details
L2-01	Layout Plan		
		LS-01	Landscape Sections
L3-01	Green Roof Plan		
L4-01	Pedestrian Circulation Plan		

10 Iss 09 Iss 08 Re 07 Re 06 Iss 05 Iss 04 Re 03 Iss 01 Iss No. Re North:  Project: Propo Devel 12148 Caledo Scale: Drawn By Drawing T		
08 Re 07 Re 06 Iss 05 Iss 04 Re 03 Iss 01 Iss No. Re North:  Project: Propo Devel 12148 Caledo Scale: Drawn By	lss	10
07 Re 06 Iss 05 Iss 04 Re 03 Iss 02 Iss 01 Iss No. Re North:  Project:  Propo Devel 12148 Caledo Scale: Drawn By	lss	09
06 Iss 05 Iss 04 Re 03 Iss 02 Iss 01 Iss No. Re North:  Project: Propo Devel 12148 Caledo Scale: Drawn By	Re	08
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04 Re 03 Iss 02 Iss 01 Iss No. Re North:  Project: Propo Devel 12148 Caledo Scale: Drawn By	lss	06
03 Iss 02 Iss 01 Iss No. Re North:  Project: Propo Devel 12148 Caledo Scale: Drawn By	lss	05
02 Iss 01 Iss No. Re North:  Project: Propo Devel 12148 Caledo Scale: Drawn By	Re	04
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ssued fo	r Coordi	nation		12/08/22
Revised	per Site	Plan		11/18/22
ssued fo	or Submi	ssion		12/22/20
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Revision				Date
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Channel Re-Alignment Prop. Ornamental Metal Fence Typ.

Prop. Chainlink Fence Typ. — x — x — Ex. Chainlink Fence Prop. Wood Privacy Fence

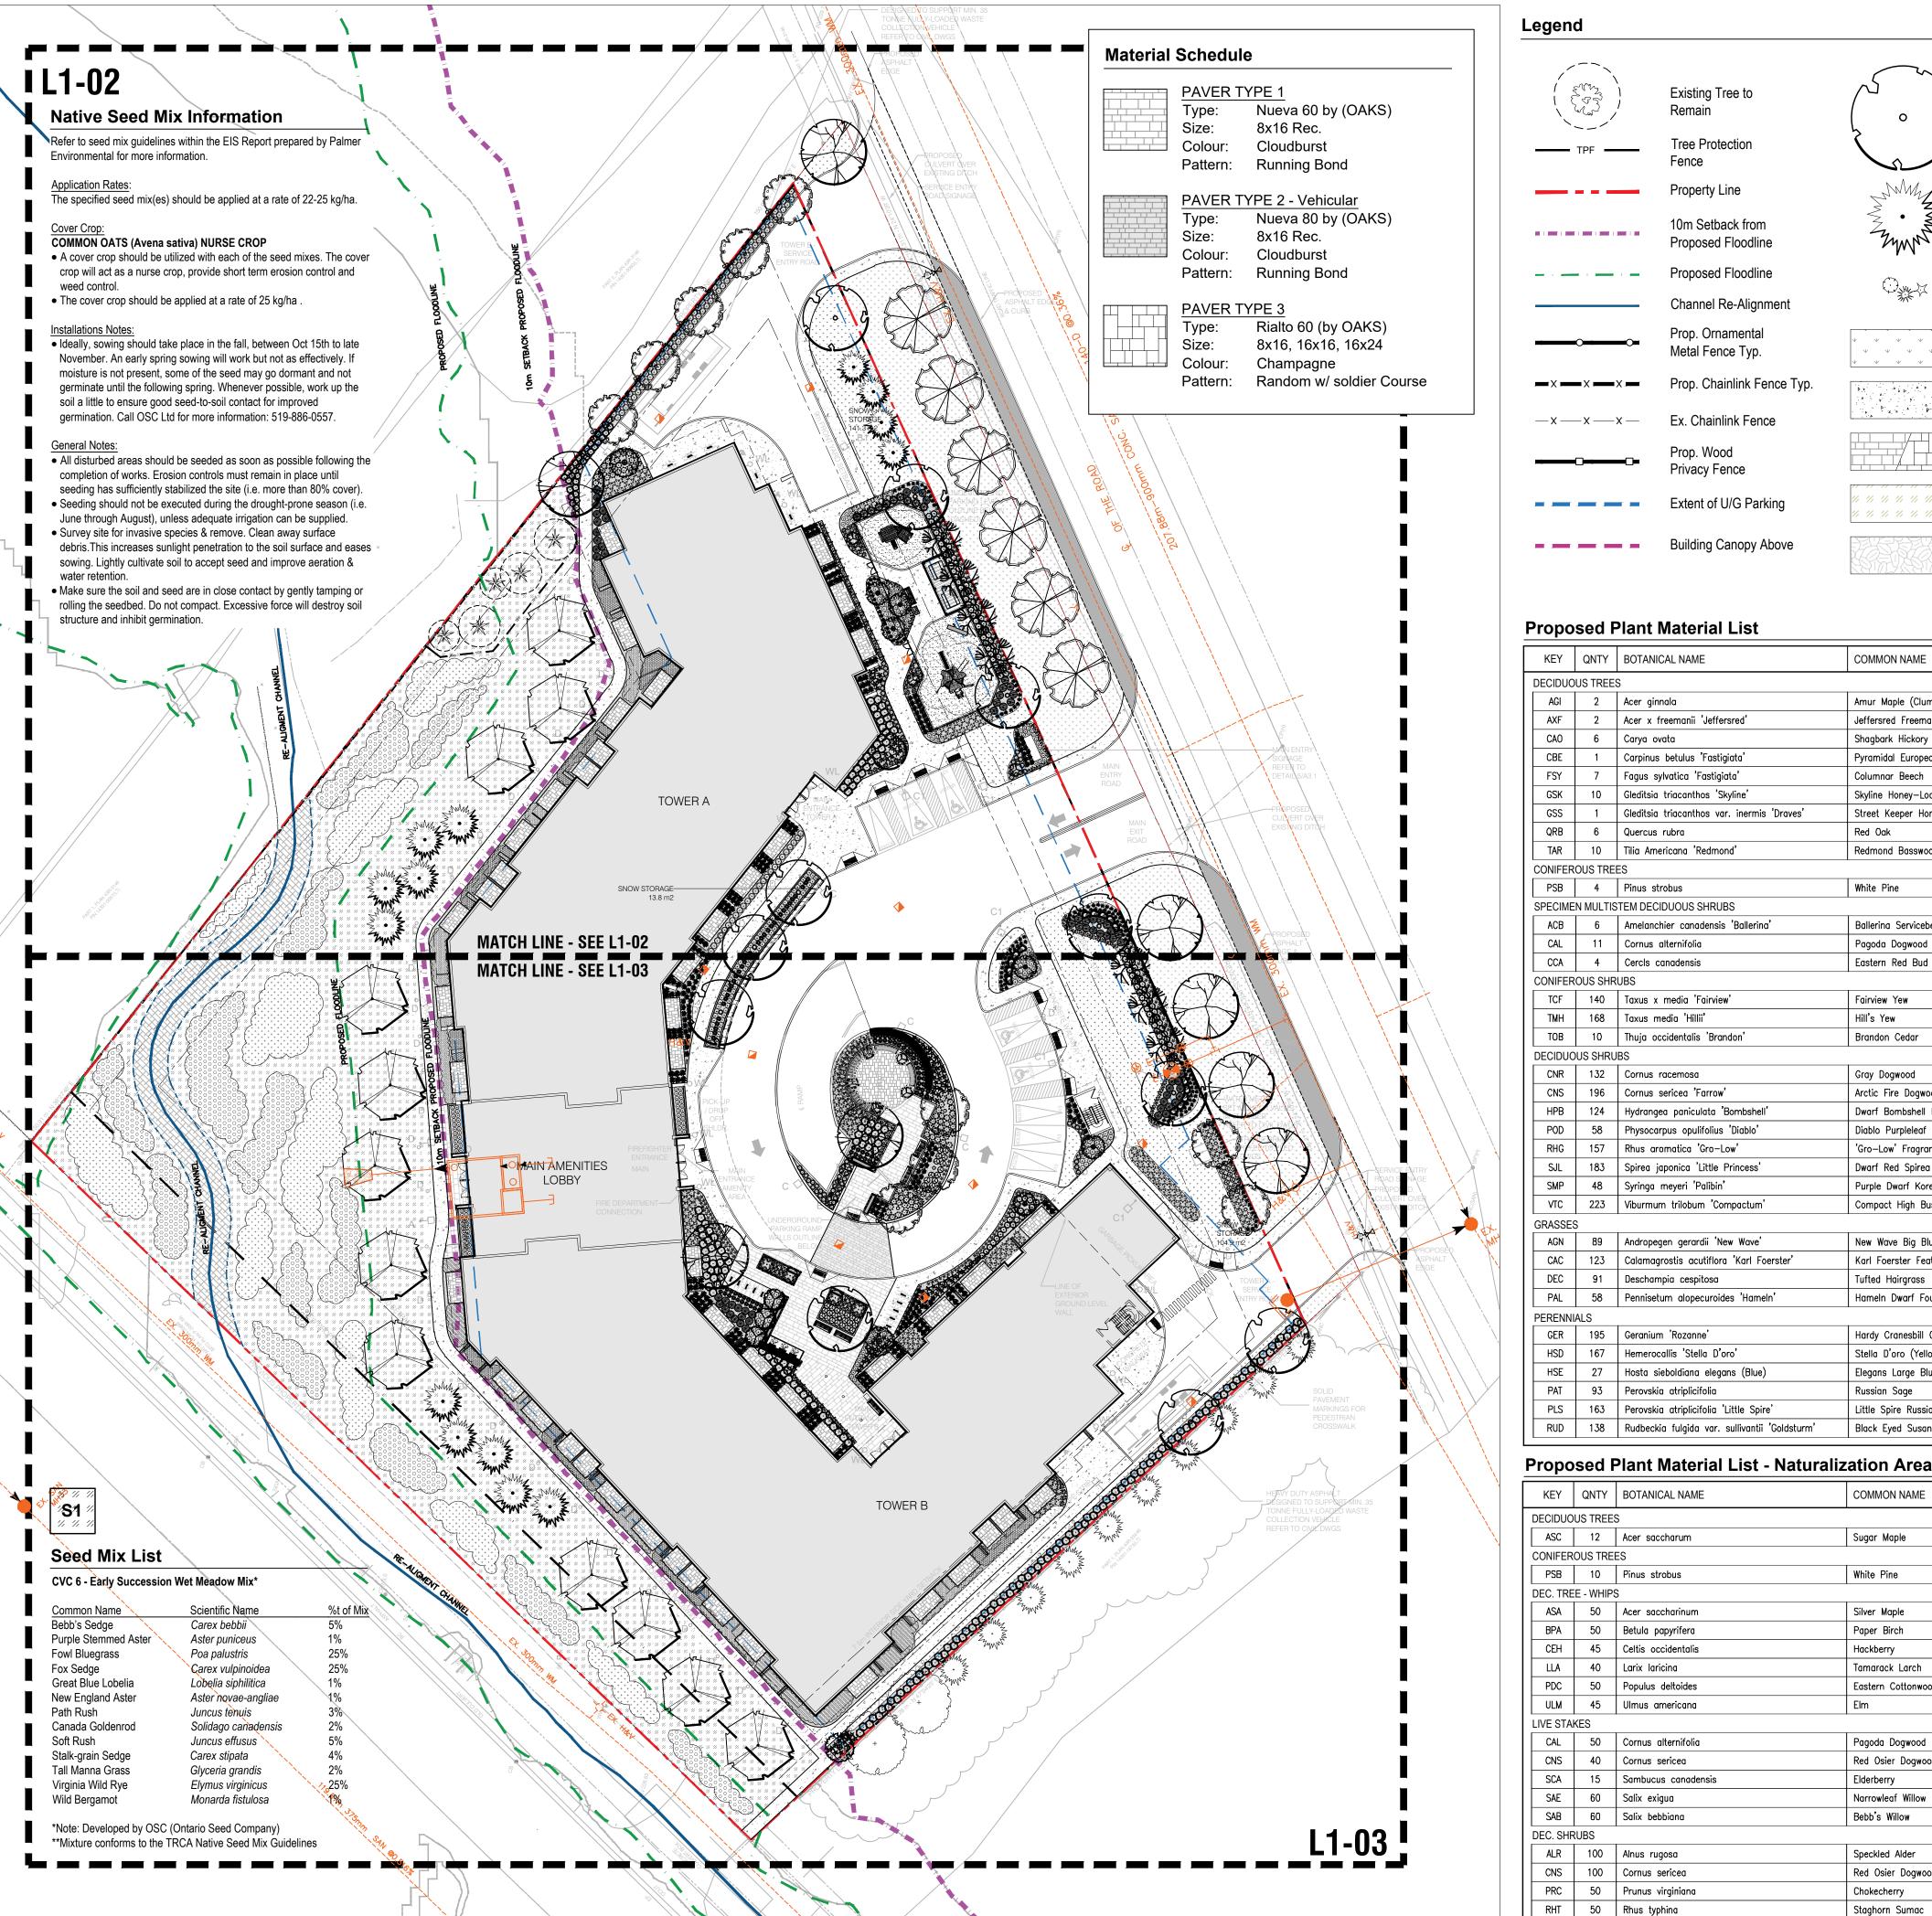Extent of U/G Parking

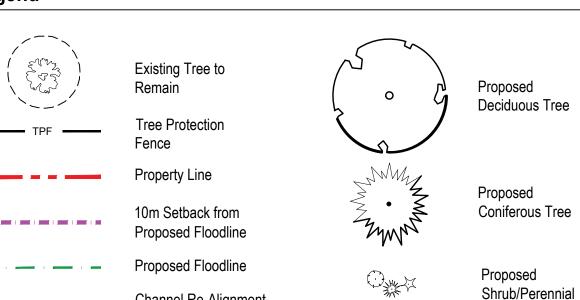1 Carpinus betulus 'Fastigiata'

Fagus sylvatica 'Fastigiata'

Gleditsia triacanthos 'Skyline'

Gleditsia triacanthos var. inermis 'Draves'

Amelanchier canadensis 'Ballerina'


11 Cornus alternifolia

157 Rhus aromatica 'Gro-Low'

123 Calamagrostis acutiflora 'Karl Foerster'

Perovskia atriplicifolia

**Building Canopy Above** 

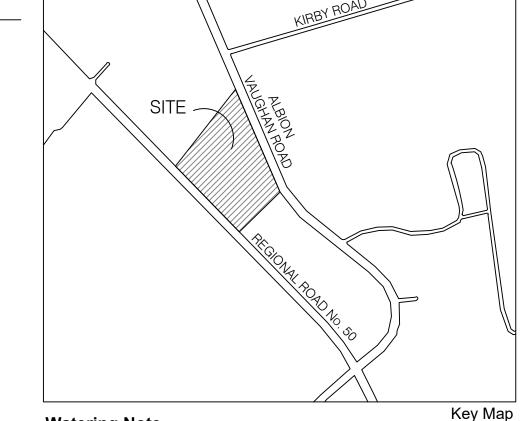

**Watering Note** 

HT/CAL SPREAD ROOT DROUGHT NATIVE REMARKS

Prop. Sodded

Prop. Concrete

Area Typ.

Paving Typ.

Prop. Unit

Naturalization

Seed Mix

Proposed

COMMON NAME

Amur Maple (Clump)

Shagbark Hickory

Columnar Beech

Red Oak

White Pine

Skyline Honey-Locust

Redmond Basswood

Ballerina Serviceberry

Pagoda Dogwood

Eastern Red Bud

Fairview Yew

Brandon Cedar

Gray Dogwood

Arctic Fire Dogwood

Dwarf Red Spirea

Dwarf Bombshell Hydrangea

Diablo Purpleleaf Ninebark

'Gro-Low' Fragrant Sumac

Purple Dwarf Korean Lilac

New Wave Big Bluestem

Tufted Hairgrass

Russian Sage

Black Eyed Susan

COMMON NAME

Sugar Maple

White Pine

Silver Maple

Paper Birch

Hackberry

Tamarack Larch

Pagoda Dogwood

Elderberry

Red Osier Dogwood

Narrowleaf Willow

Bebb's Willow

Speckled Alder

Chokecherry

Staghorn Sumac

Red Osier Dogwood

Eastern Cottonwood

Compact High Bush—Cranberry

Karl Foerster Feather Reed Grass

Hameln Dwarf Fountain Grass

Hardy Cranesbill Geranium

Little Spire Russian Sage

Stella D'oro (Yellow) Daylilies

Elegans Large Blue Leaf Hosta

Hill's Yew

Jeffersred Freeman Maple

Pyramidal European Hornbeam

Street Keeper Honey-Locust (Clump)

Planting Area

60 mm

70 mm

70 mm

70 mm

70 mm

70 mm

60 mm

70 mm

70 mm

200 cm

200 cm

150 cm

180 cm

60 cm

60 cm

80 cm

60 cm

60 cm

60 cm

70 cm

60 mm

120 cm

120 cm

120 cm

120 cm

120 cm

100 cm

100 cm

100 cm

100 cm

100 cm

• The contractor shall be fully responsible to ensure that adequate water is provided to all plants from the point of installation until the date of acceptance. The contractor shall adjust the automatic irrigation system, if available, and shall apply additional water, using hoses as required (refer to the site plan and mechanical plans for watering connections and hose bibs). • During the initial establishment period, and particularly immediately after installation do not rely on the irrigation system to water the plants. Plants will uptake water only within the root

B.&B. High No Tree Form Multi Stem

B.&B. | High | Cultivar | Tree Form Multi Stem

B.&B. | High | Hybrid | Full Form

B.&B. High Yes Full Form

B.&B. High Yes Full Form

B.&B. | High | Yes | Full Form

B.&B. High Yes Full Form

B.&B. Med. Yes Full Form

B.&B. High Yes Full Form

B.&B. High Yes Full Form

B.&B. High Yes Multi Stem

B.&B. High Yes Multi Stem

B.&B. High Yes Full Form

C.G. | High | Yes | Full Form

C.G. High Yes Full Form

C.G. High No Full Form

5 Gal. High Yes Full Form

2 Gal. | High | Yes | Full Form

2 Gal. | High | No | Full Form

2 Gal. | High | Yes | Full Form

2 Gal. High No Full Form

2 Gal. | High | Cultivar | Full Form

B.&B. | High | Yes | Full Form

B.&B. | High | Yes | Full Form

4 Gal. | High | Yes | Full Form

4 Gal. High Yes Full Form

Live Stake | High | Yes | Full Form

Live Stake High Yes Full Form

Live Stake | High | Yes | Full Form

Live Stake High Yes Full Form

2 Gal. High Yes Full Form

2 Gal. | High | Yes | Full Form

High Yes Full Form

High Yes Multi Stem

High Yes Full Form

High Yes Full Form

High Yes Full Form

High Yes Full Form

Yes Full Form

High Yes Large Leaf

High

High

HT/CAL SPREAD ROOT DROUGHT NATIVE REMARKS

High Yes Full Form

High Yes Full Form

No Full Form

Yes Full Form

No Full Form

Yes | Full Form

No | Full Form

No Full Form

No Full Form

180 cm pink/pur B.&B. High Yes Tree Form

5 gal. High

C.G. | High |

5 Gal. High

2 Gal.

High

High

65 cm | C.G. | Med. | No | Full Form

watering the root ball with the irrigation system. • Hand water root balls of all plants and the soil immediately around the root ball to assure that the root balls have adequate moisture. Test the moisture content in each root ball to determine the water content. maintain root ball moisture and soil beyond the root ball moisture between 10 and 20% as measured using a general digital moisture meter. do not over water the soil around the plants. Use "tree gator bags" to assist in watering trees.

ball and a short distance outside the ball. It is possible to over water the soil while under

**MARTON SMITH LANDSCAPE ARCHITECTS** 

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Municipality:

Architect:



#### SPA No.: **SPA 2021-0004**

Notes:



SNOW STORAGE: ADDITIONAL SNOW THAT CANNOT BE RETAINED ON SITE IS TO BE TRUCKED OFF-SITE

PLANT REFERENCE LIST NOTE: ALL QUANTITIES IN THE LIST OF PLANT MATERIALS ARE TO BE CHECKED BY THE LANDSCAPE CONTRACTOR. ANY DISCREPANCIES ARE TO BE REPORTED TO THE LANDSCAPE ARCHITECT. THE QUANTITIES INDICATED ON THE DRAWINGS SUPERCEDE THE TOTAL QUANTITIES

10 Issued for Final OPA/ZBA Sub 11/18/24 Issued for 3rd Submission 06/13/24 Revised per Town Comments 04/11/24

07 Revised per Site Plan 06 Issued for Re-Submission 05 Issued for Coordination

Revised per Site Plan

12/22/20 03 Issued for Submission 12/15/20 02 Issued for Review

Issued for Review No. Revision Date





03/15/24

01/20/23

12/08/22

11/18/22

Project:


**Proposed Residential** Development 12148 Albion Road

Caledon, Ontario **1:400** Date: **Nov. 2020 D.R.** Checked By: **L.M.** Drawn By:


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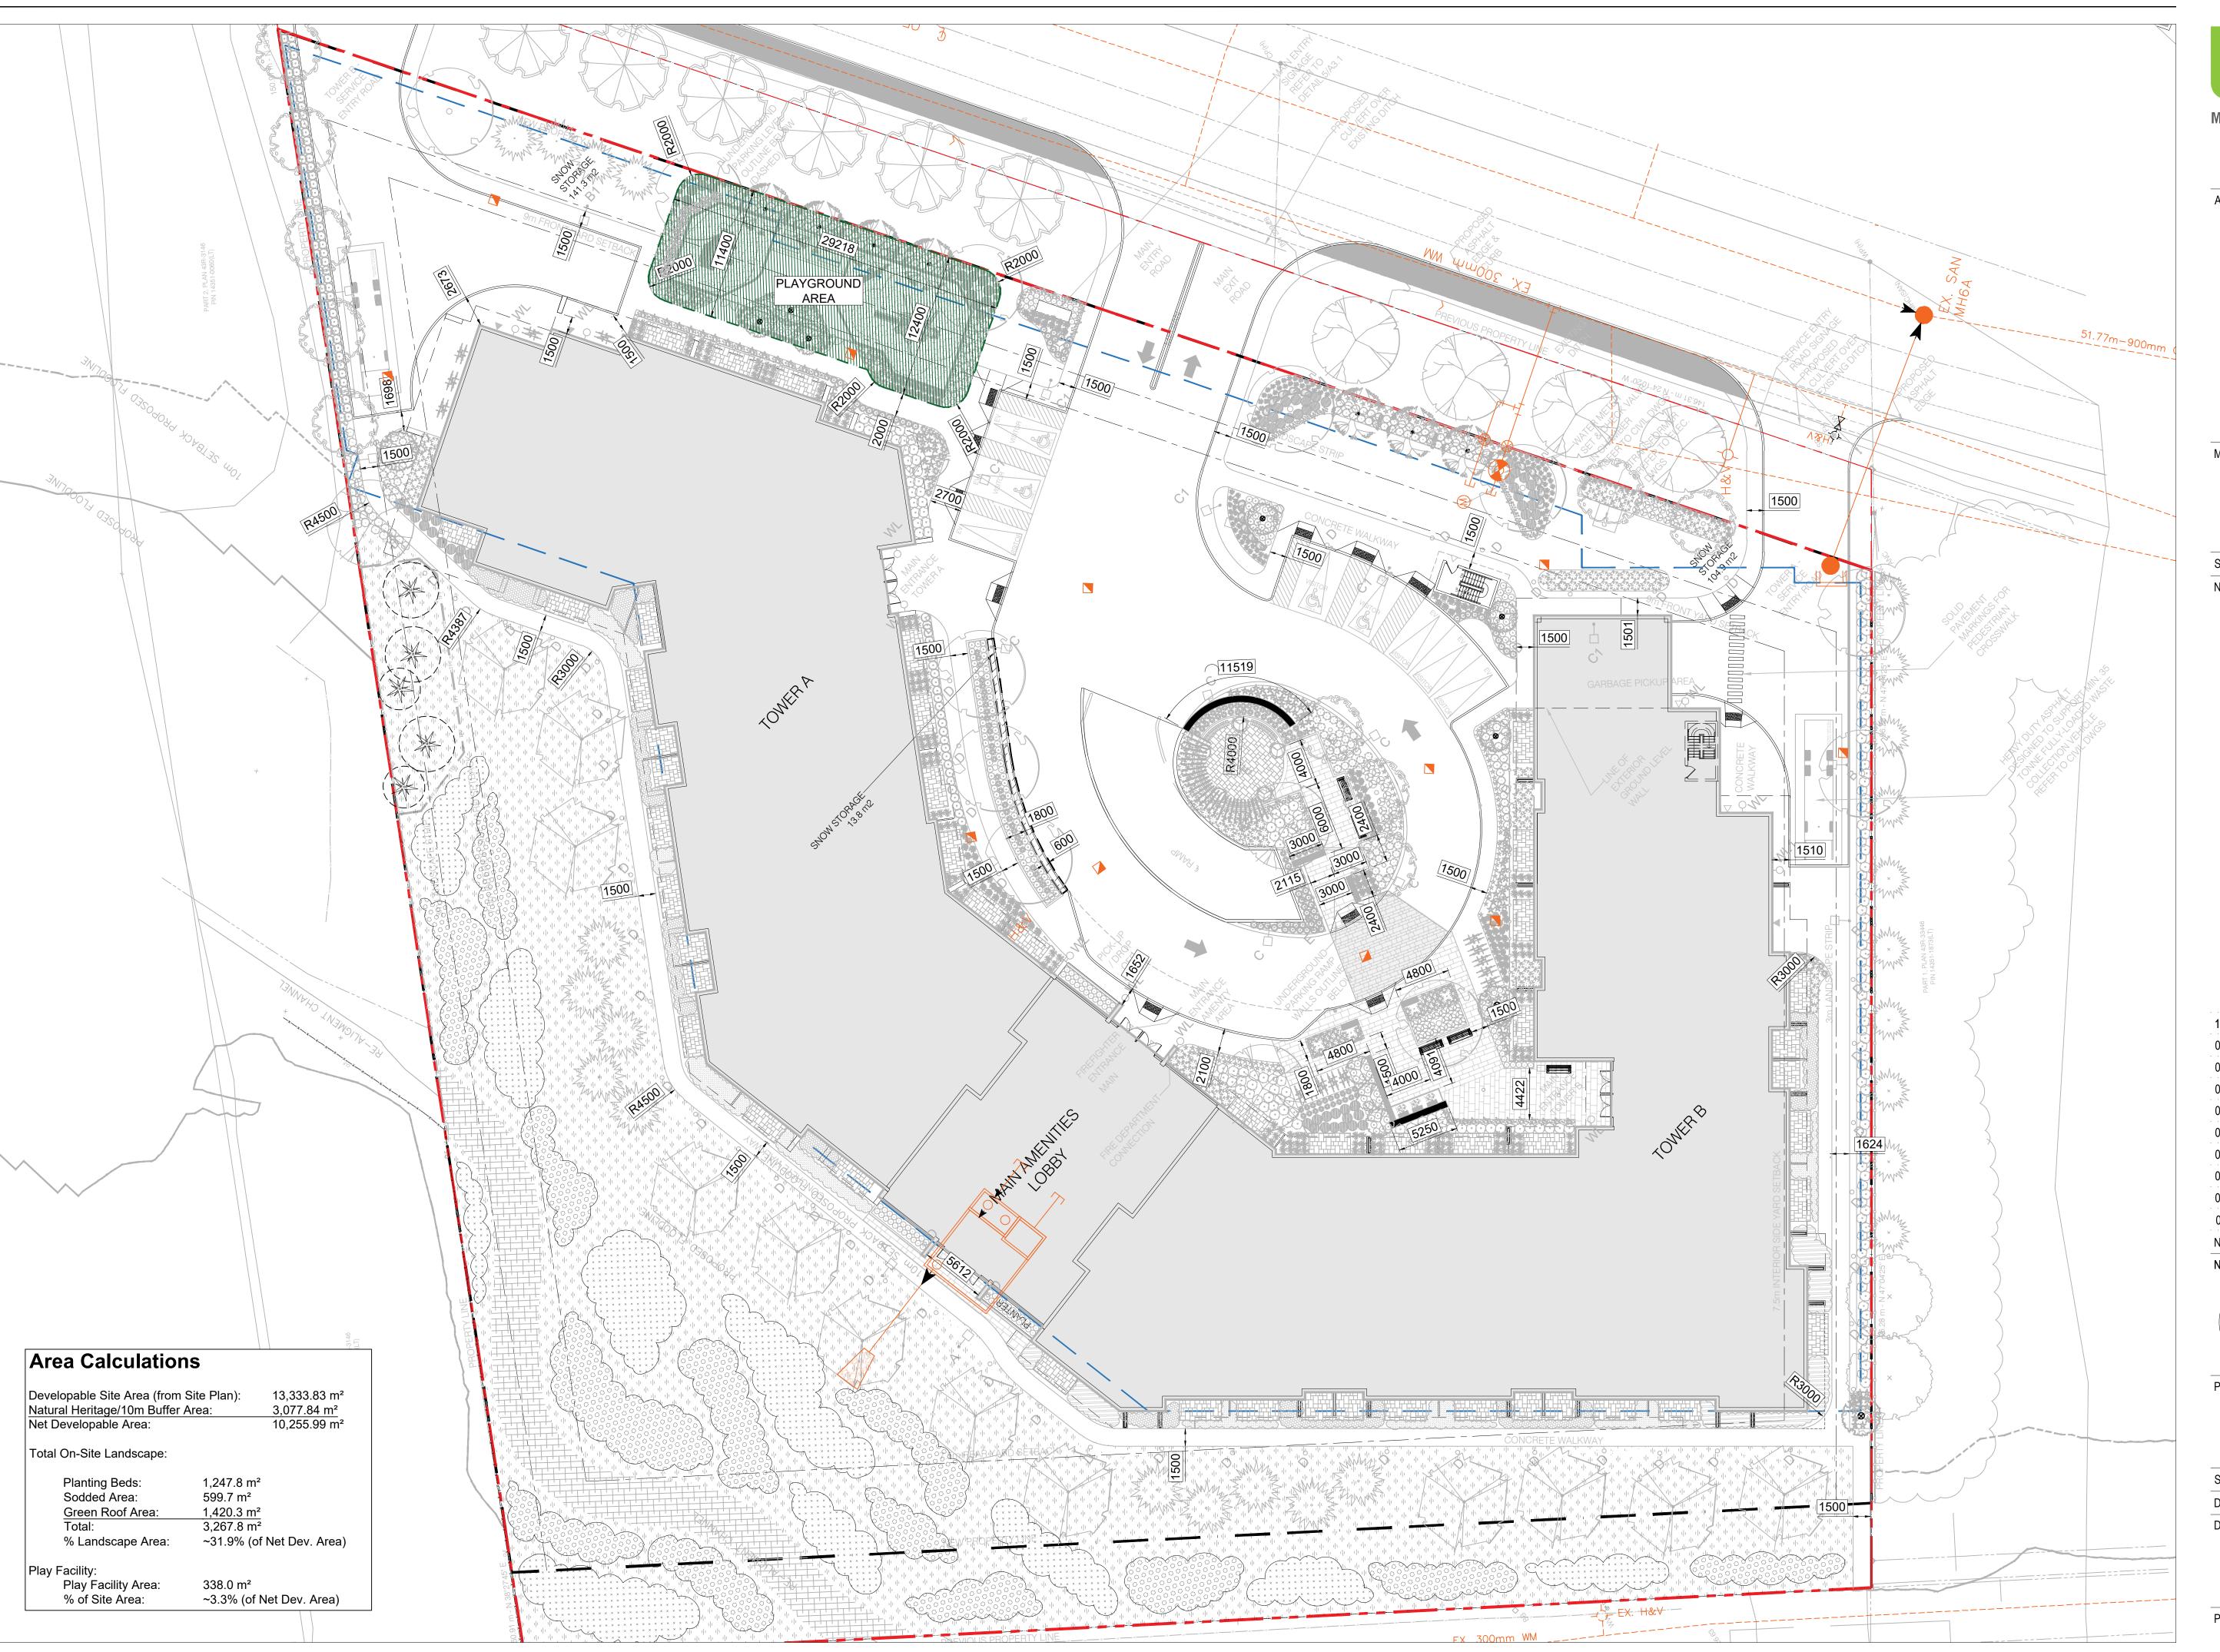
### Landscape **Master Plan**

Project No. L1-01



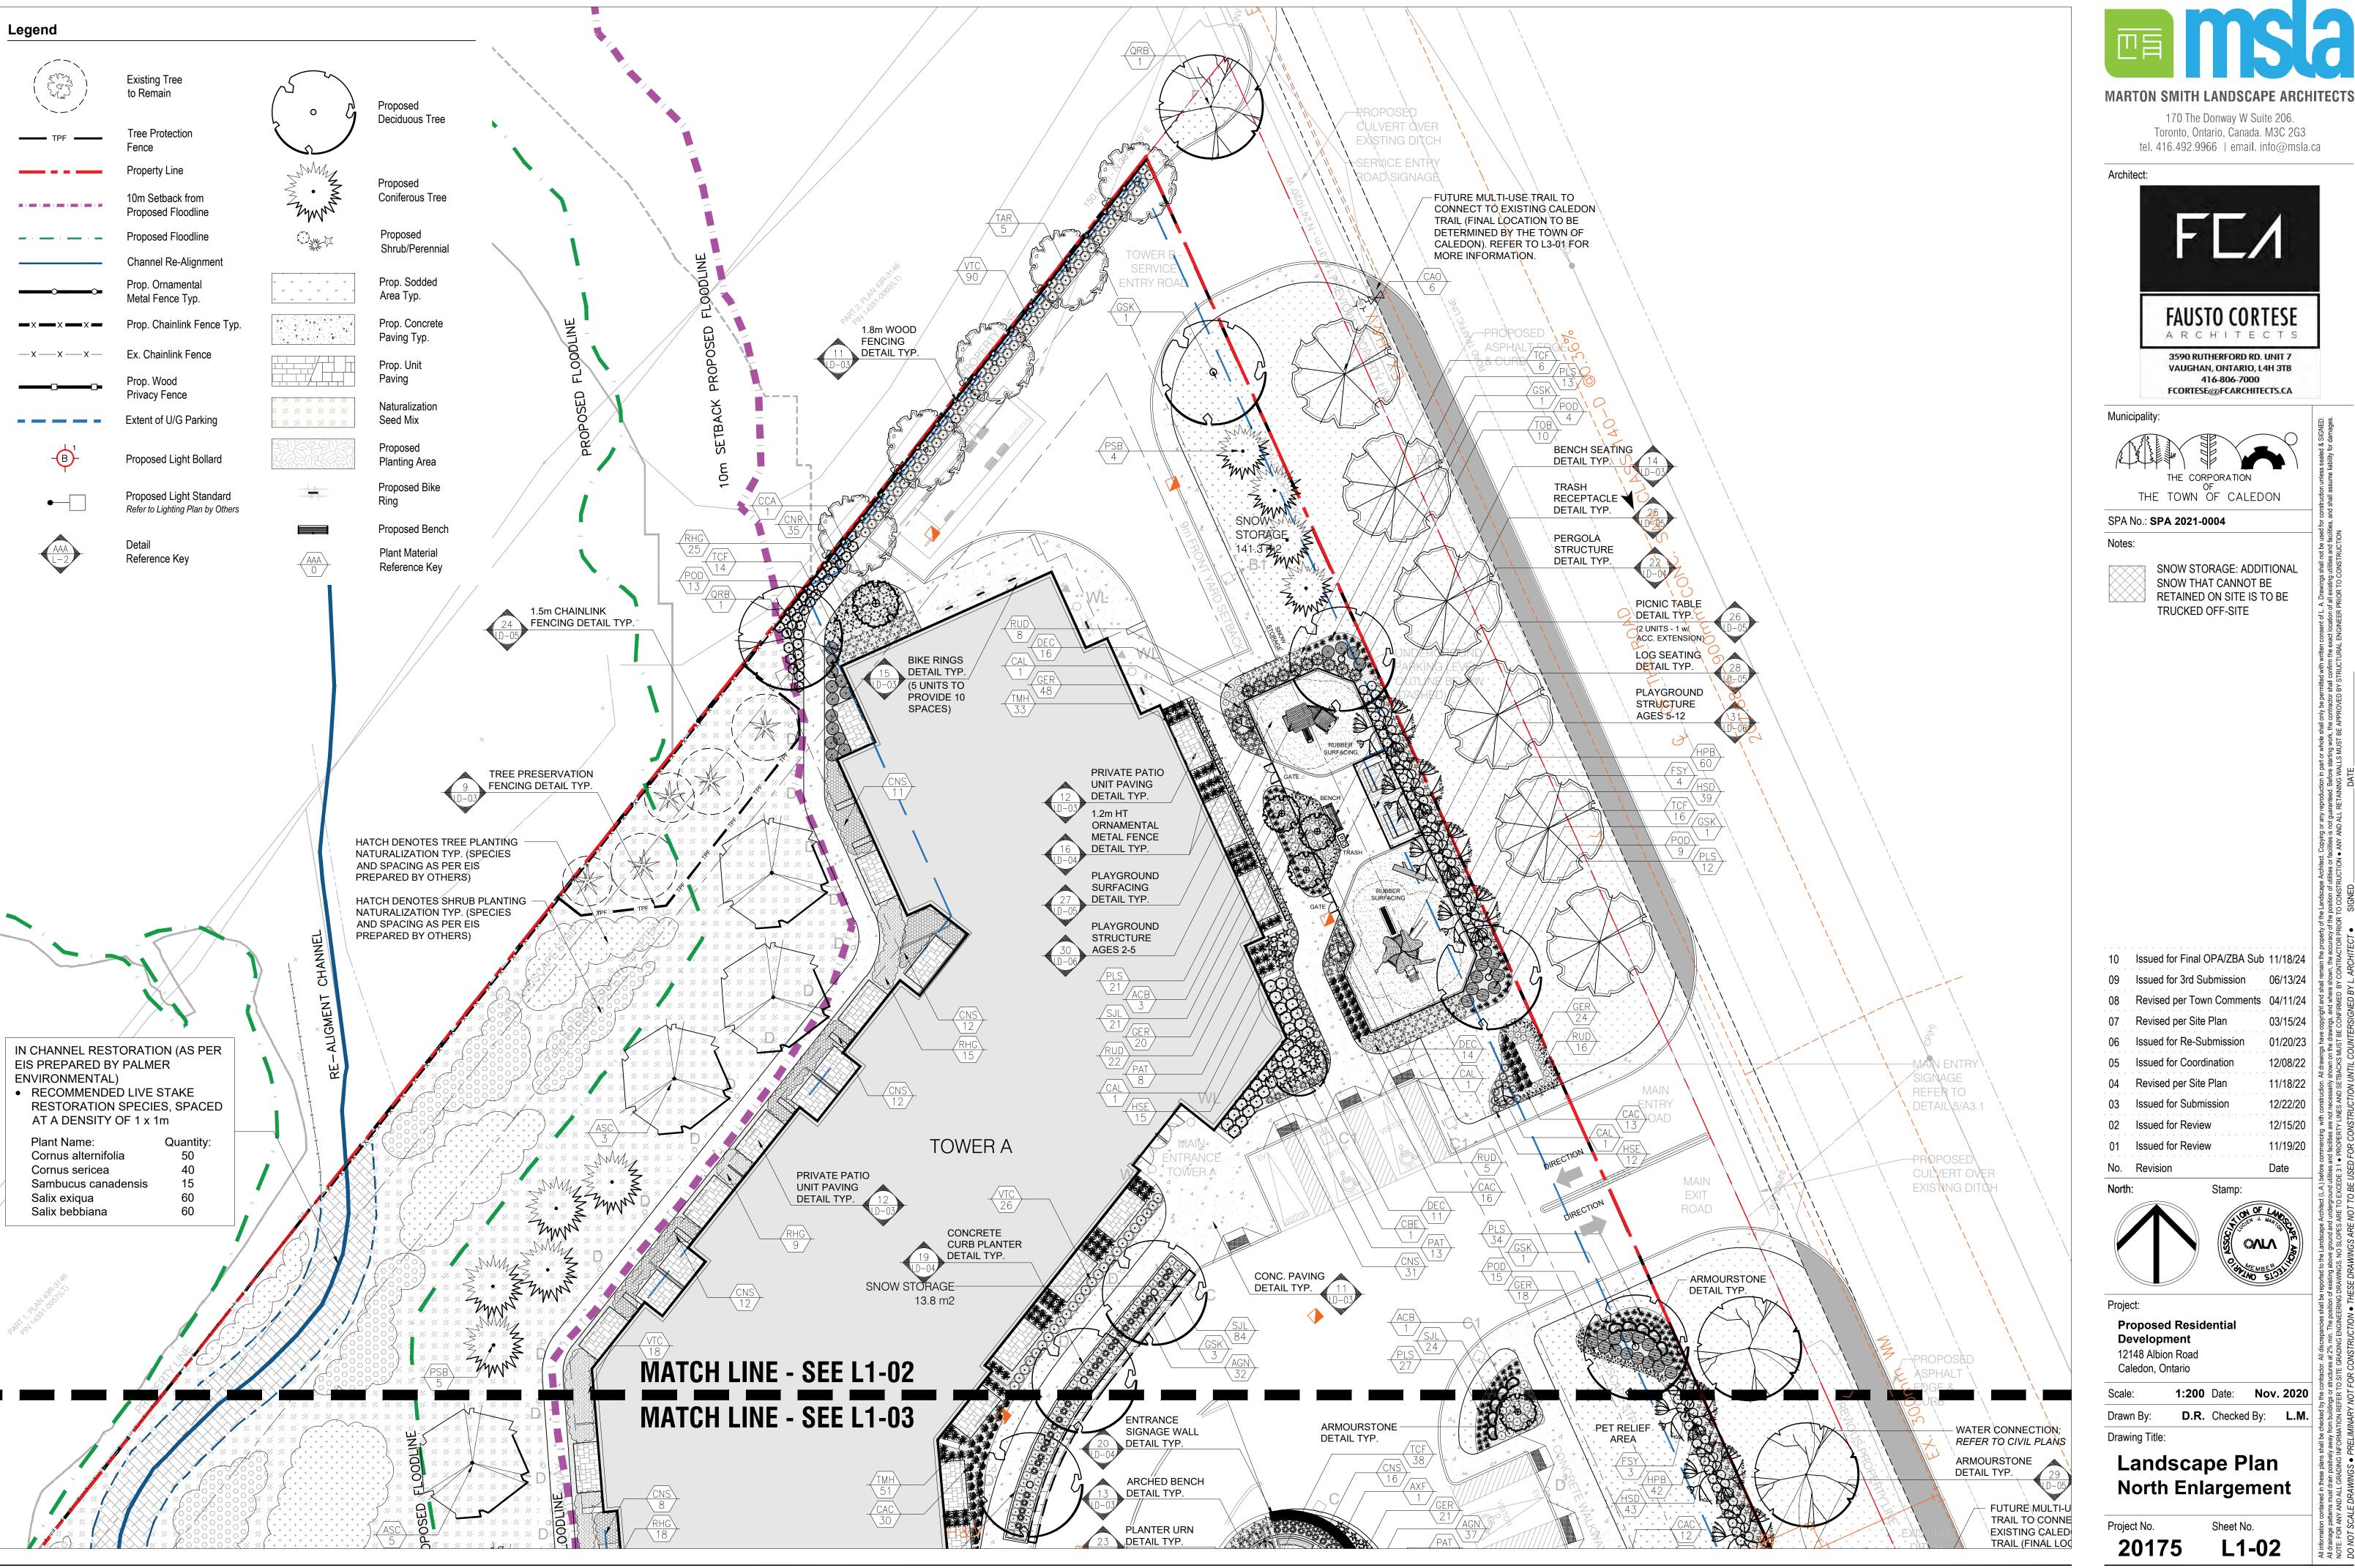



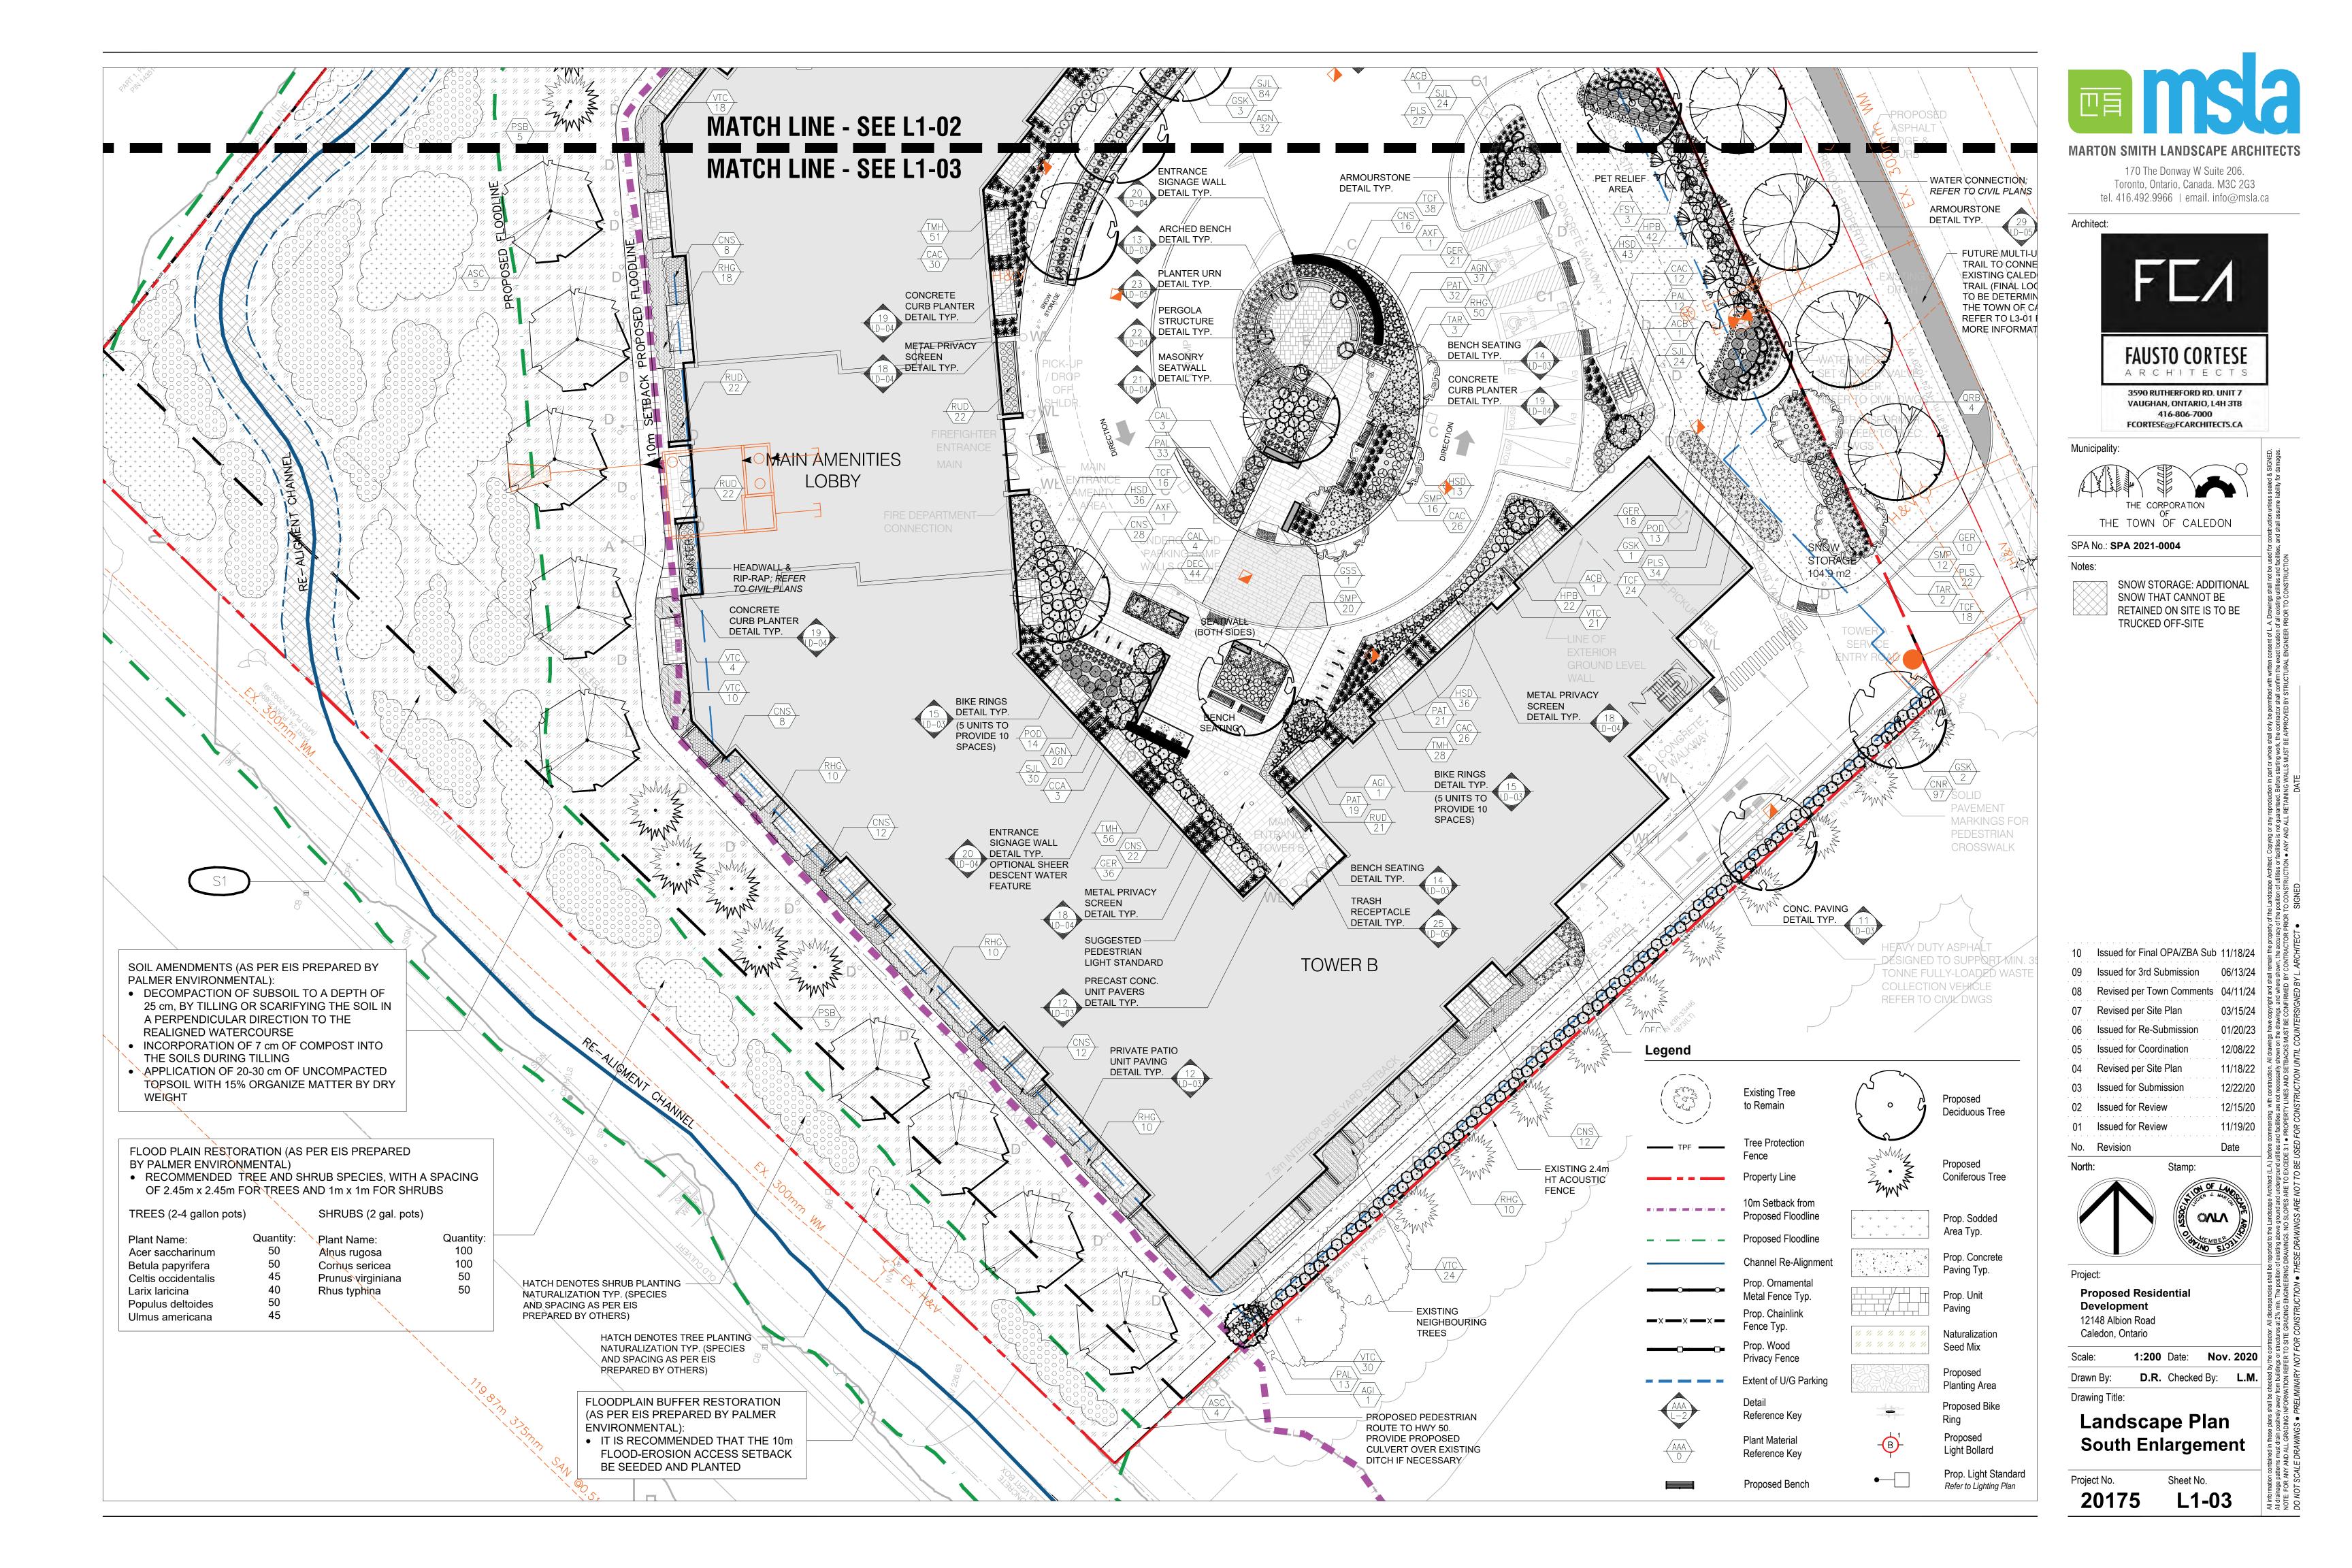



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Architect:



FAUSTO CORTESE ARCHITECTS

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Municipality:




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04 Revised per Site Plan 03 Issued for Submission 02 Issued for Review

01 Issued for Review



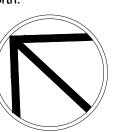


Proposed Residential Development 12148 Albion Road Caledon, Ontario

**1:400** Date: **Nov. 2020 D.R.** Checked By: **L.M.** 

Drawing Title:

Layout Plan

Project No. L2-01

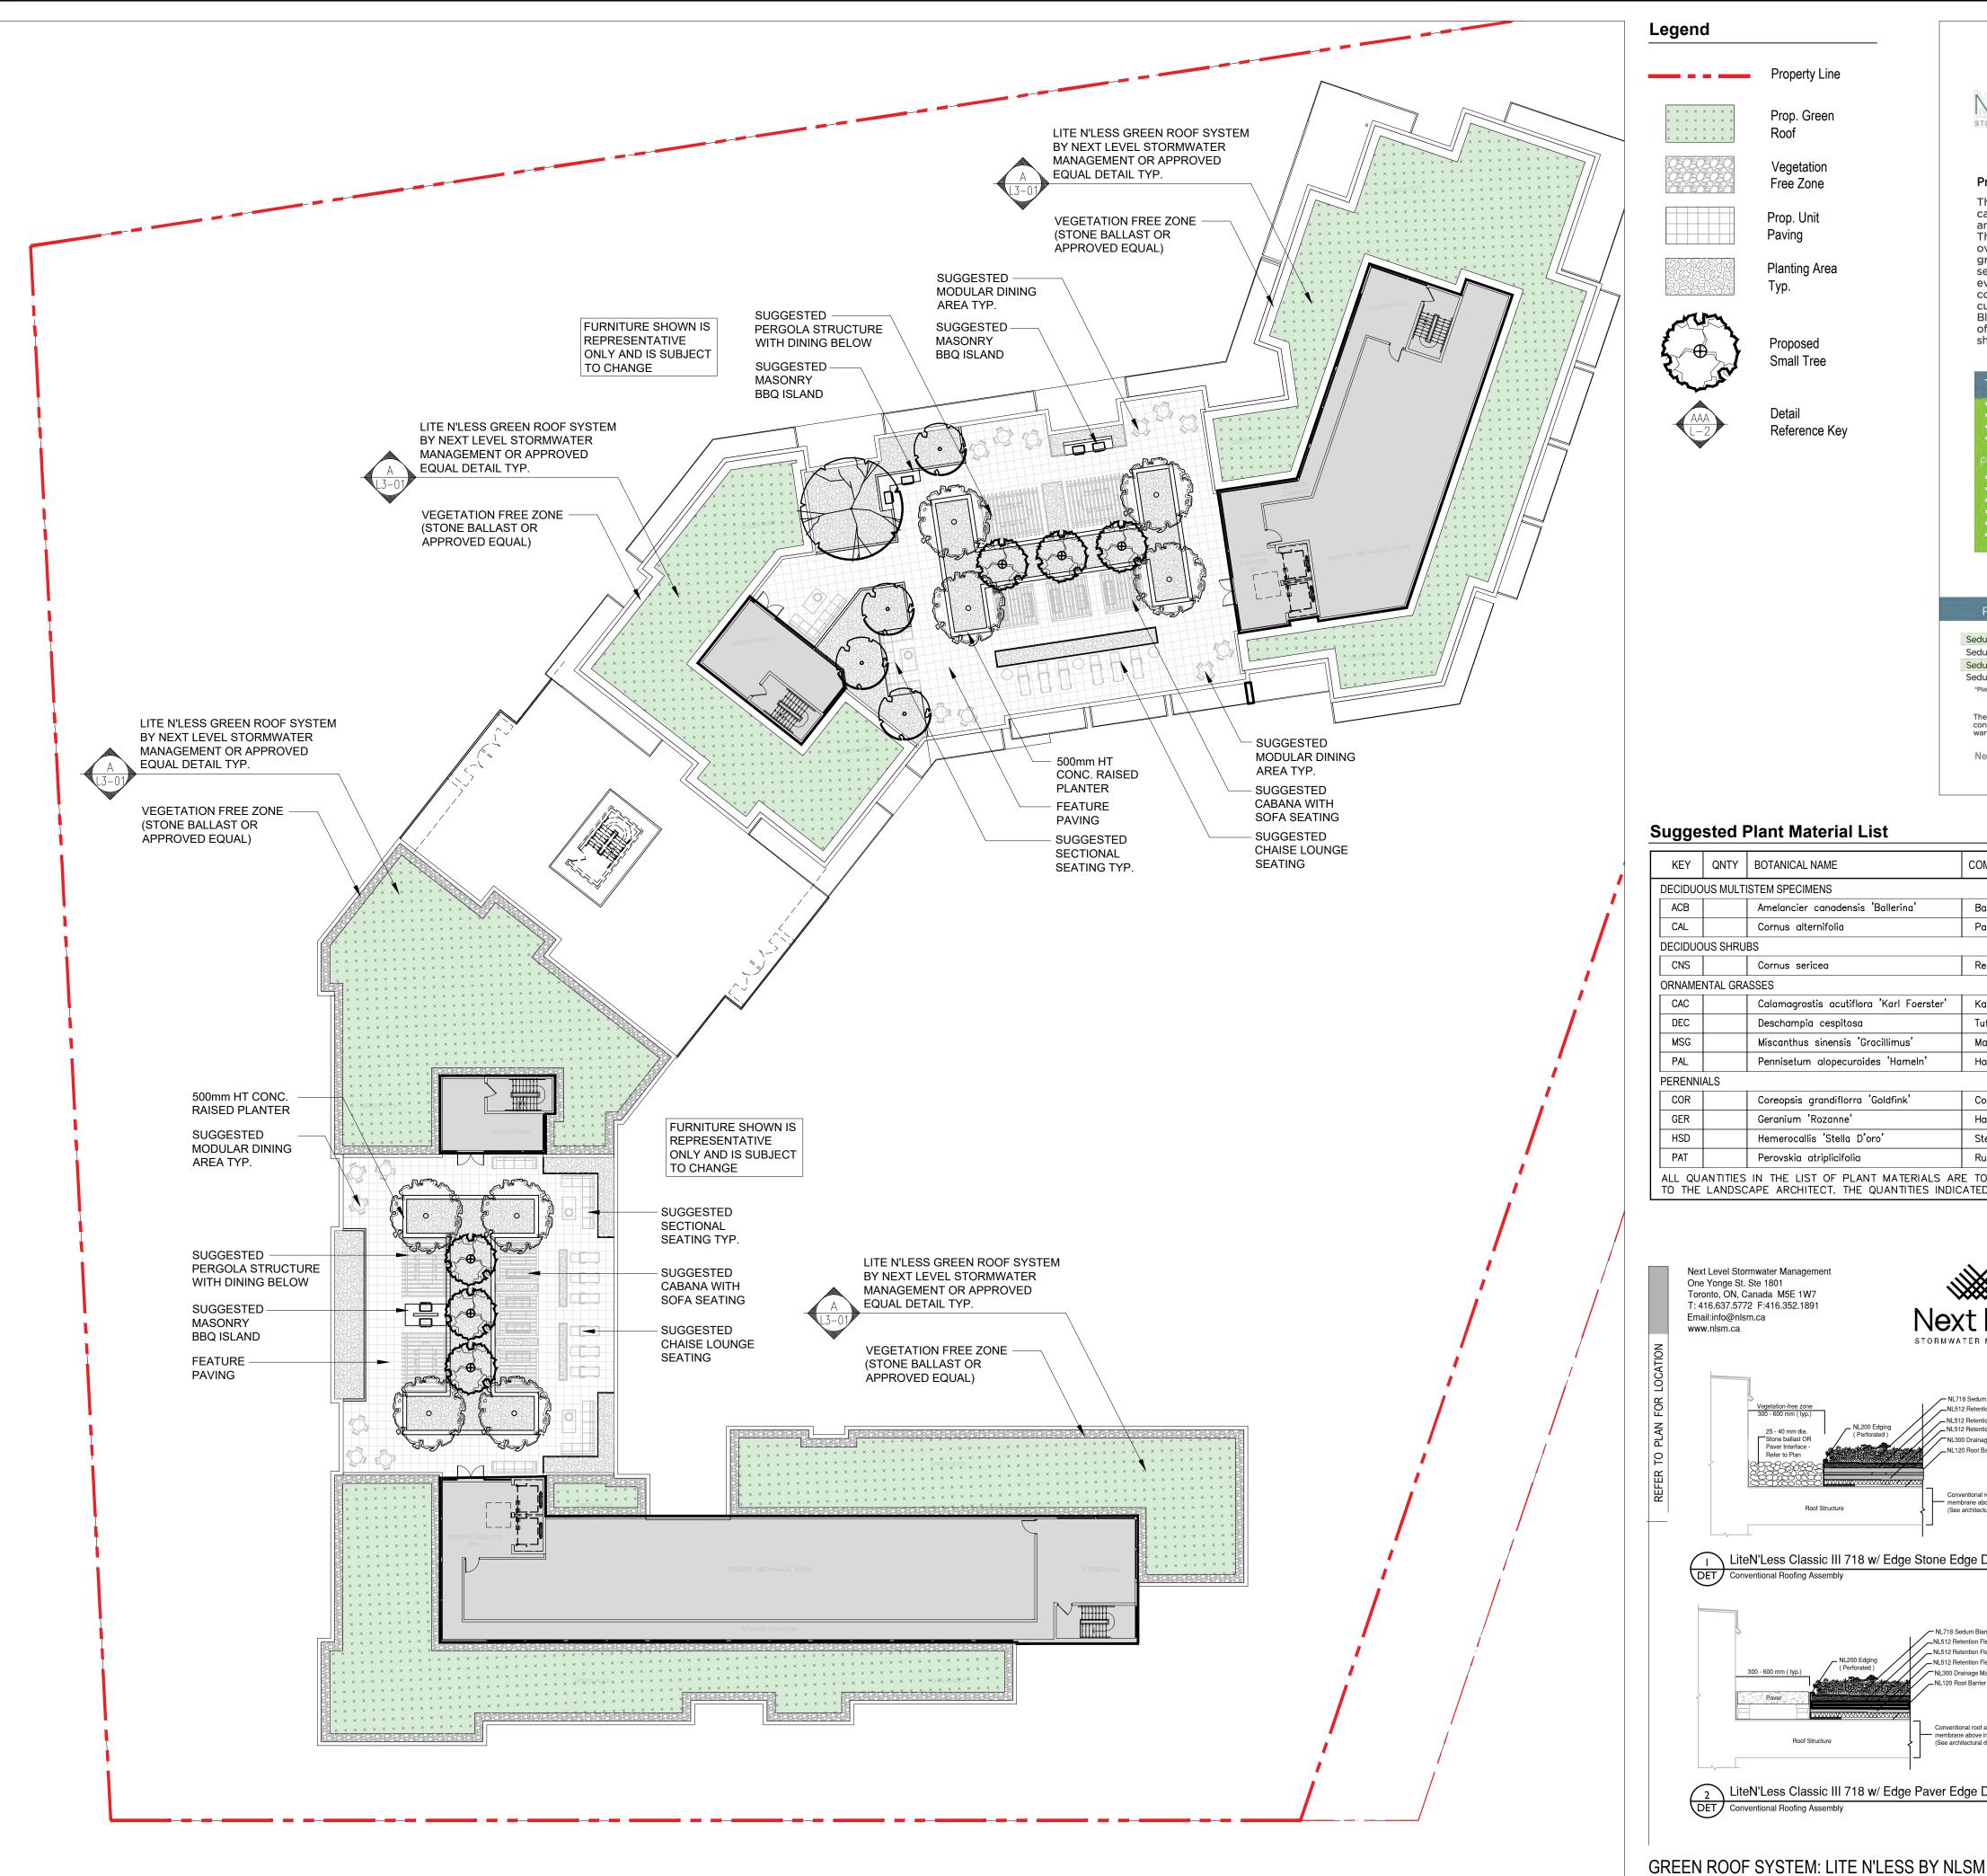



#### **Product Description**

The NL718 Sedum Blanket consists of a carrier made up of a filter fabric on one side and a polymer loop network on the other. The carrier is offset by 100mm, to create an overlap on both sides of the roll. Engineered growing medium and specially selected seeds and cuttings are then distributed evenly over the three-dimensional polymer coil loop network, to establish the precultivated vegetation mat. NL718 Sedum Blankets are guaranteed to have a minimum of 80% vegetation coverage at the time of shipping.



- Recommended Application
- Abut tightly all end and side seams. Start next row with a half roll so the end joints stagger between rows. Cut and fit to the edge of the non-vegetated border zone along the roof edge and around penetrations.
- Saturate sedum mats thoroughly. Sedum is a low traffic plant. Avoid damage by excessive walking and storing items on vegetation.

#### Plant list – Standard Mix

Sedum acre	Sedum kamtschaticum	Sedum spurium 'Coccineum'
Sedum album	Sedum pulchellum	Sedum stenopetalum
Sedum spurium 'Summer Glory'	Sedum reflexum (rupestre)	Sedum stoloniferum
Sedum floriferum	Sedum ellacombianum	Sedum sexangulare

The information contained herein is believed by Next Level Stormwater Management to be accurate and is offered solely for the customer's consideration, investigation and verification. Determination of suitability for use is the responsibility of the user. Next Level's limitations, limited warranty, disclaimer and standard terms & conditions apply.

Next Level Stormwater Management™ | 416 637 5772 | info@nlsm.ca | nlsm.ca

#### **Suggested Plant Material List**

SCALE: N.T.S. DATE:

Free Zone

Prop. Unit

Planting Area

Proposed


Small Tree

Reference Key

Paving

KEY	QNTY	BOTANICAL NAME	COMMON NAME	HT/CAL	SPREAD	ROOT	REMARKS
DECIDUO	DECIDUOUS MULTISTEM SPECIMENS						
ACB		Amelancier canadensis 'Ballerina'	Ballerina Serviceberry	200 cm		В.&В.	Multi Stem
CAL		Cornus alternifolia	Pagoda Dogwood	150 cm		B.&B.	Full Form
DECIDUO	DECIDUOUS SHRUBS						
CNS		Cornus sericea	Red Osier Dogwood	70 cm		C.G.	Full Form
ORNAME	NTAL GRA	ASSES					
CAC		Calamagrostis acutiflora 'Karl Foerster'	Karl Foerster Feather Reed Grass			5 Gal.	Full Form
DEC		Deschampia cespitosa	Tufted Hairgrass			2 Gal.	Full Form
MSG		Miscanthus sinensis 'Gracillimus'	Maidengrass Ornamental Grass			5 Gal.	Full Form
PAL		Pennisetum alopecuroides 'Hameln'	Hamlin Dwarf Fountain Grass			2 Gal.	Full Form
PERENNIALS							
COR		Coreopsis grandiflorra 'Goldfink'	Coreopsis Dwarf Yellow			1 Gal.	Full Form
GER		Geranium 'Rozanne'	Hardy Cranesbill Geranium			1 Gal.	Full Form
HSD		Hemerocallis 'Stella D'oro'	Stella D'oro (Yellow) Daylilies			1 Gal.	Full Form
PAT		Perovskia atriplicifolia	Russian Sage			2 Gal.	Full Form

ALL QUANTITIES IN THE LIST OF PLANT MATERIALS ARE TO BE CHECKED BY THE LANDSCAPE CONTRACTOR. ANY DISCREPANCIES ARE TO BE REPORTED TO THE LANDSCAPE ARCHITECT. THE QUANTITIES INDICATED ON THE DRAWINGS SUPERCEDE THE TOTAL QUANTITIES

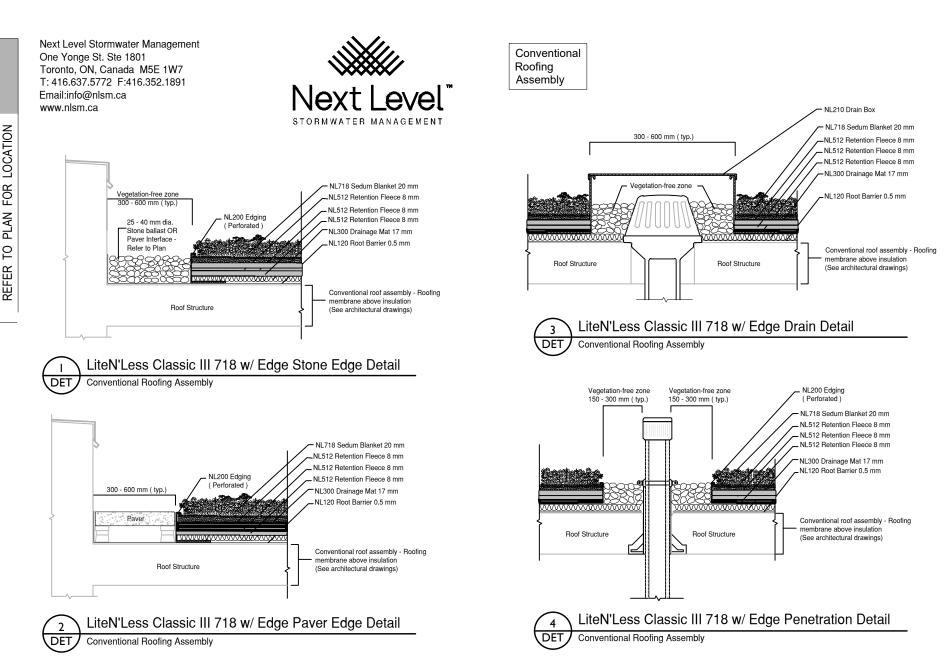



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Architect:



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Municipality:

Notes:



SPA No.: **SPA 2021-0004** 

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Project: Proposed Residential Development


North:

12148 Albion Road Caledon, Ontario

**1:300** Date: **Nov. 2020 D.R.** Checked By: **L.M.** Drawn By: Drawing Title:

**Green Roof & Amenity Plan** 

Project No.

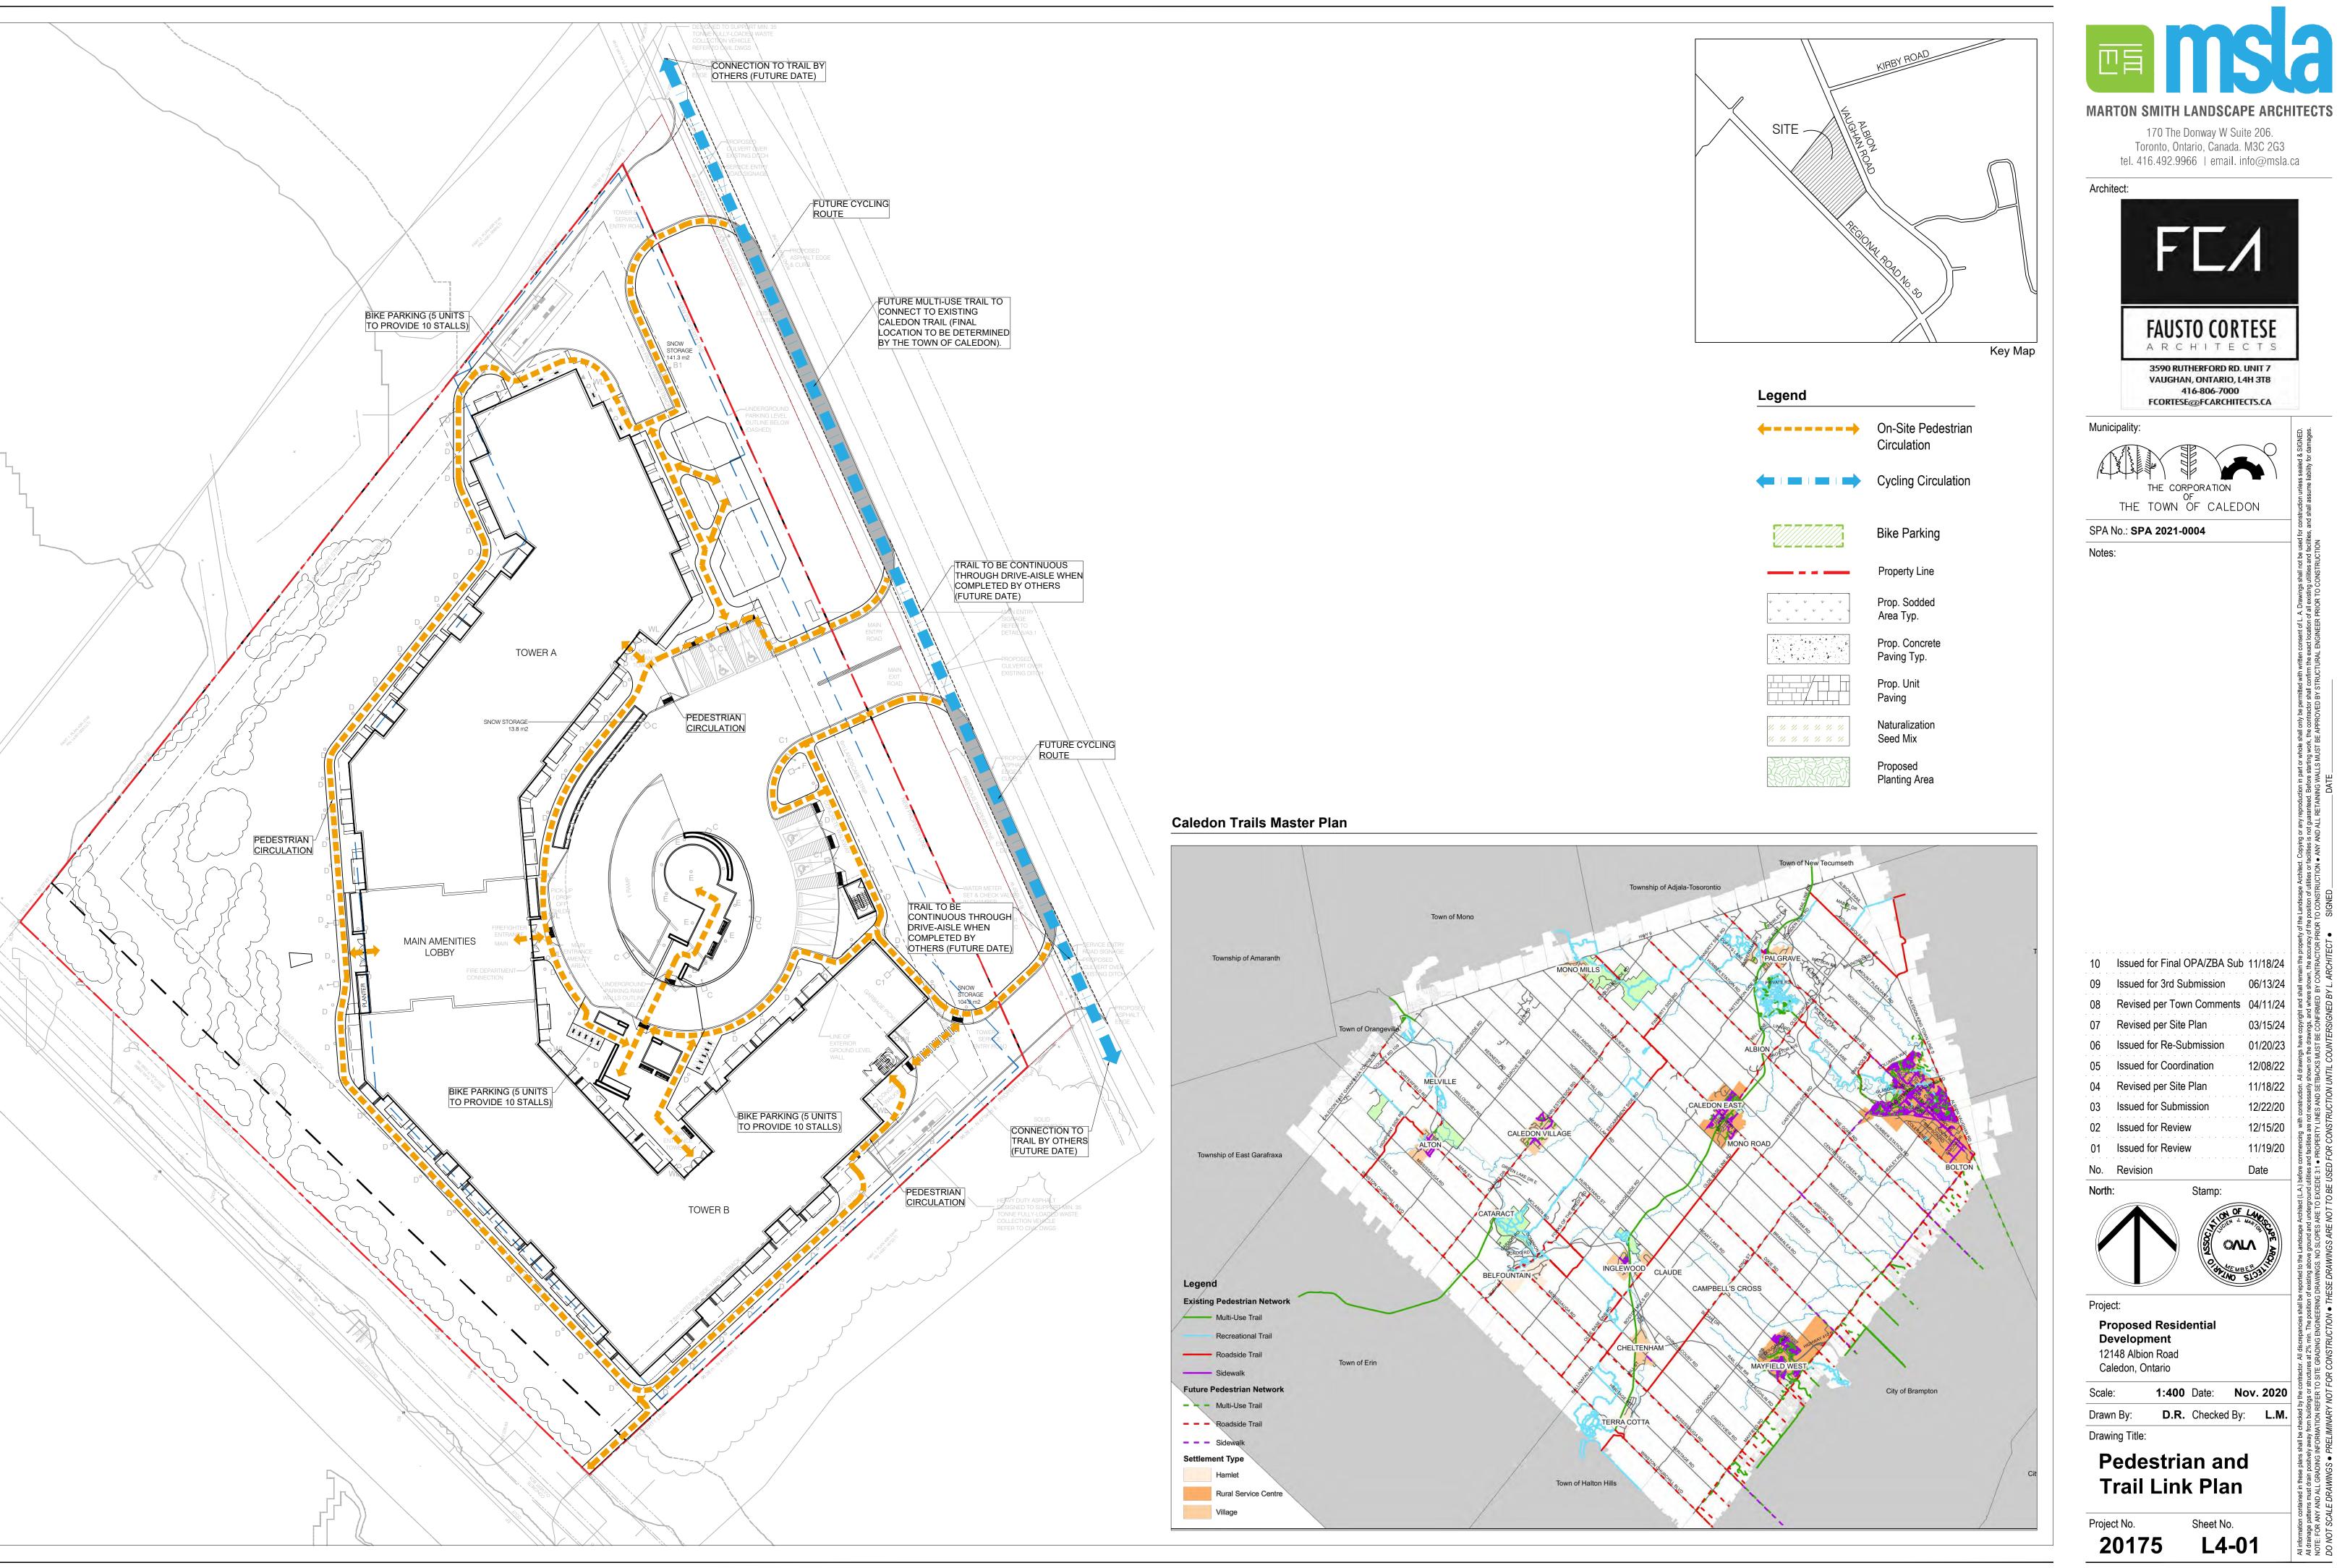



170 The Donway W Suite 206. Toronto, Ontario, Canada. M3C 2G3



3590 RUTHERFORD RD. UNIT 7 VAUGHAN, ONTARIO, L4H 3T8 416-806-7000



Issued for 3rd Submission 06/13/24

03/15/24 01/20/23

11/18/22

12/22/20 12/15/20

**1:400** Date: **Nov. 2020** 

#### General

- 1. These specifications are to be read in conjunction with the general conditions of the contract (contact the project owner or MSLA Landscape Architects).
- 2. Prior to commencing work, the contractor shall:
  - a. Familiarize themselves with the plans, details and specifications of this project;
  - b. Visit the site to ascertain and take account of existing conditions and any deviations from the plans in work by other; and,
  - c. Finalize all design alternatives in consultation with the Landscape Architect.
- 3. Prior to excavating the contractor shall verify the location of all underground utilities. In the event of a conflict between a proposed tree location and an underground service, the exact location of the tree shall be determined on site by the Landscape Architect. The contractor shall, at his/her own expense, repair any damage to existing utilities, structures, facilities, etc. done in the performance of their work.

#### Soft Landscaping Plant Materials

- 4. All plants shall be installed true to specified names, sizes, grades, etc. and shall conform to the standards of the Canadian Nurserv Landscapes Association.
- 5. All plants shall be nursery grown in a hardiness zone appropriate to site conditions, as published by Agriculture Canada, entitled 'Map of Plant Hardiness Zones in Canada'.
- 6. In the event of a discrepancy in plant quantity between the landscape plan and the plant list, the landscape plan shall govern.
- 7. The contractor shall make plants available for inspection by the Landscape Architect prior to shipping to the site. This does not limit

the right of the Landscape Architect and/or Town's representative to later reject plant material that is of poor quality, damaged during shipping or installation, performing poorly while the guarantee period is still in effect, or otherwise does not conform to the specifications.

- 8. Plant substitutions must be approved in writing by the owner, the Landscape Architect and the Town prior to delivery of the material on-site. The Landscape Architect may, upon completion of the work and notwithstanding prior approval at source, reject plant material not conforming to the specifications
- 9. The contractor shall use standard industry methods for planting trees. Trees shall be turned to give the best appearance. They shall also be guyed and staked immediately after planting and as detailed on the drawings.

#### Bed Preparation

- 10. Prior to backfilling, scarify the sides and bottom of the excavated tree pits and shrub beds.
- 11. Where heavy clay soil conditions prevail, backfill to the specified depths with:
  - a. 2 parts "Triple Mix" delivered to the site well-mixed with 1 part local topsoil (topsoil that was removed from the site and stockpiled; if unavailable, a topsoil with clay content must be imported)
- 12. Tree pits must be constructed with saucers and mulch as detailed.

#### Maintenance

- 13. Maintenance of all landscape installations throughout to include: 14. Proper irrigation to ensure optimum growth and development of installed plant material.
- 15. Cultivation, weeding and fertilization of the tree pits and planting

- 16. Insect and disease control using 'Integrated Pest Management'
- 17. Pruning and maintenance to further promote visibility and vitality of its intended use, as directed by the Landscape Architect or the Town.

#### Guarantee

- 18. All plant materials shall be guaranteed for a minimum of 1 year from date of written Landscape Certification for Commencement of Plant Warranty as granted by the Town, and until final certification is granted by the Town. Plants which do not survive satisfactorily during the guarantee period shall be replaced at no extra cost to the owner. Plant material which is replaced due to unsatisfactory performance shall, in turn, be guaranteed for another minimum of 1 year, or until final certification is granted by the Town.
- 19. Similarly, all other landscape work performed under this contract shall be fully guaranteed for the above specified period.
- 20. All work shall be inspected at the end of the warranty period, at which time a final certificate will be issued by the Landscape Architect and submitted to the Town for their inspection, and approval of final certification, permitting release of site work securities.
- 21. At the end of the guarantee period, the contractor shall remove all tree stakes, rodent guards and bark wrap and all extra mulch where necessary.

#### Acceptance

22. Work will be accepted by the owner or their representative upon completion and at the end of the specified maintenance period, provided that all plant material is alive and in healthy growing conditions.

- 23. Written preliminary and final certification must be submitted to the Town by the Landscape Architect. The Certifications shall be signed and stamped with the seal of the OALA.
- 24. Preliminary Certification of the project shall serve as the start of the quarantee period.
- 25. Final acceptance of the landscape works for this project is granted by the Town of Caledon upon conducting a satisfactory final site inspection

#### Continued Responsibility of the Owner

26. The owner has a responsibility to maintain the approved landscape in a well cared for manner that promotes plant vitality and healthy appearance. Any declining or dead plants are to be replaced within the season to sustain a kept landscape. The owner is reminded that future site plan applications for this site will be reviewed with regard to the conformity of the existing landscaping to the approved Landscape Plan registered with the Town of Caledon.



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Architect:



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VAUGHAN, ONTARIO, L4H 3T8

416-806-7000 FCORTESE@FCARCHITECTS.CA

Municipality:



SPA No.: **SPA 2021-0004** 

Notes:

TOWN OF CALEDON - LANDSCAPE STANDARD NOTES

SCALE: N.T.S.

#### GENERAL

- These Specifications are to be read in conjunction with the General Conditions of the contract (contact the project owner or MSLA Landscape Architects).
- ii) Prior to commencing work, the Contractor shall:
- a. Become familiar with the plans, details, and specifications of this project,
- b. Visit the site to ascertain and take account of existing conditions and any deviations from the plans in work by others, and c. Finalize all design alternatives in consultation with the Landscape
- Architect. iii) Prior to excavating, the Contractor shall verify the location of all
- underground utilities. In the event of a conflict between a proposed tree location and an underground service, the exact location of the tree shall be determined on site by the Landscape Architect and/or the Town's representative.
- iv) The Contractor shall, at his or her own expense, repair any damage to existing utilities, structures, facilities, etc. done in the performance of his work.
- v) All site work shall conform to the Canadian National Master Construction Specifications, a copy of which can be obtained from Construction Specifications Canada, 100 Lombard St., Suite 200, Toronto, Ontario MSC 1M3; Tel. (416) 777-2198; Fax (416) 777-2197. It is the responsibility of the Contractor to be thoroughly familiar with these specifications and their implications for this project.

#### PLANT MATERIAL

- All plants shall be installed true to specified names, sizes, grades, etc., and shall conform to the standards of the Canadian Nursery Landscapes Association.
- ii) All plants shall be nursery grown in a hardiness zone appropriate to site conditions, as published by Agriculture Canada, titled 'Map of

#### Plant Hardiness Zones in Canada'.

- iii) In the event of a discrepancy in plant quantity between the Planting Plan and the Plant List, the Planting Plan shall govern.
- iv) The Contractor shall make plants available for inspection by the Landscape Architect and/or the Town's representative prior to shipping to the site. This does not limit the right of the Landscape Architect and/or the Town's representative to later reject plant material that is of poor quality, damaged during shipping or installation, performing poorly while the guarantee period is still in effect, or otherwise does not conform to the specifications
- v) Plant substitutions must be approved in writing by the Town and the Landscape Architect prior to delivery of the material to the site.
- vi) The Contractor shall use standard industry methods for planting trees and shrubs. Trees shall be turned to give the best appearance; they shall also be guyed or staked immediately after planting and as detailed on the drawings.

#### BED PREPARATION

- The Contractor shall scarify the sides and bottom of excavated tree pits and shrub beds prior to backfilling. Due to the heavy clay soil in the Bolton area, tree and planting beds shall be backfilled to the specified depths with:
- a.2 Parts "triple mix," delivered to the site, to be wellmixed with . . . b.1 Part local topsoil (viz., subdivision topsoil that has been removed and stockpiled.) If topsoil is unavailable, topsoil with clay content
- shall be imported and mixed with triple mix. ii) Tree pits shall be constructed with saucers and mulch as detailed.

#### TOPSOIL AND FINE GRADING

- i) The Contractor shall place 100mm of rich topsoil on approved subgrades. Topsoil shall be imported when insufficient amounts are available on site.
- ii) Minor grade deficiencies and irregularities shall be eliminated prior to

#### seeding.

- HYDROSEEDING i) The Contractor shall apply 2280 kg/ha fibre mulch over the newly seeded area to form a uniform, blotter-like ground cover that allows the absorption and percolation of water.
- ii) The area seeded in a single day shall not exceed the area that can be mulched that same day.
- iii) The Contractor shall apply the specified seed mixture using accepted industry methods for hydroseeding and at rates recommended by the seed supplier. The type and rate of fertilizer application shall be as recommended in the topsoil test report for the particular area being seeded.

#### PRELIMINARY ACCEPTANCE

- When landscaping is completed, the Landscape Architect shall submit a Certificate of Completion to the Town of Caledon certifying that all landscape works have been completed in accordance with the approved plans.
- ii) Upon receipt of the Certificate of Completion, the Planning Department will conduct a preliminary inspection of the site and, provided that the works are in satisfactory condition, will grant preliminary acceptance of the landscaping.

#### G. GUARANTEE

All naturalized landscaping shall carry a guarantee/maintenance of THREE (3) years, commencing from the date that preliminary acceptance is granted by the Municipality. The Owner shall provide the Municipality with a copy of the maintenance agreement between the Owner and the Contractor. In each of the next three summers, the Landscape Architect shall conduct an inspection and prepare a report, recommending the replacements and/or works needed to achieve the intent of the approved landscape plan. The Landscape

Architect shall file a copy of the report with the Municipality. Replacement plant material shall be guaranteed for a period of time

i) determined by the Municipality. ii) All other landscape work performed under this contract shall be fully guaranteed for TWO (2) years.

#### H. MAINTENANCE

- ij) The maintenance of all landscape installations throughout the quarantee period shall include:
- a.applying appropriate fertilizer to promote growth,
- b.pruning dead or diseased tissue. c.removing dead plant material,
- d.replacing dead coniferous naturalization species to maintain a
- minimum live-stocking standard of 90%, e.replacing dead deciduous and shrub naturalization species to
- maintain a minimum live-stocking standard of 90%, and f. suppressing weed growth around newly planted trees and shrubs by adding more mulch and/or removing weeds by hand, *not* by cutting the weeds down with power trimmers.

#### CERTIFICATE OF ASSUMPTION

- i) At the end of the guarantee period, the Contractor shall remove all tree stakes, rodent guards, and bark wrap, and shall add extra mulch where necessary.
- ii) When these final tasks have been completed, all landscape work will be inspected by the Municipality and, if satisfied that all work has been completed in accordance with the approved landscape plans, will issue a Certificate of Assumption and release any outstanding funds.

10 Issued for Final OPA/ZBA Sub 11/18/24 Issued for 3rd Submission Revised per Town Comments 04/11/24

07 Revised per Site Plan 03/15/24 06 Issued for Re-Submission 01/20/23 Issued for Coordination 12/08/22 Revised per Site Plan 11/18/22

02 Issued for Review Issued for Review

No. Revision

03 Issued for Submission



12/22/20

12/15/20

11/19/20

Date

Project:

**Proposed Residential Development** 12148 Albion Road

Caledon, Ontario

Scale: **As Shown** Date: Nov. 2020 Drawn By: **D.R.** Checked By: **L.M.** 


## Landscape Notes

Project No.

Drawing Title:


**LD-01** 

TOWN OF CALEDON - NATURALIZATION SPECIFICATIONS STANDARD NOTES

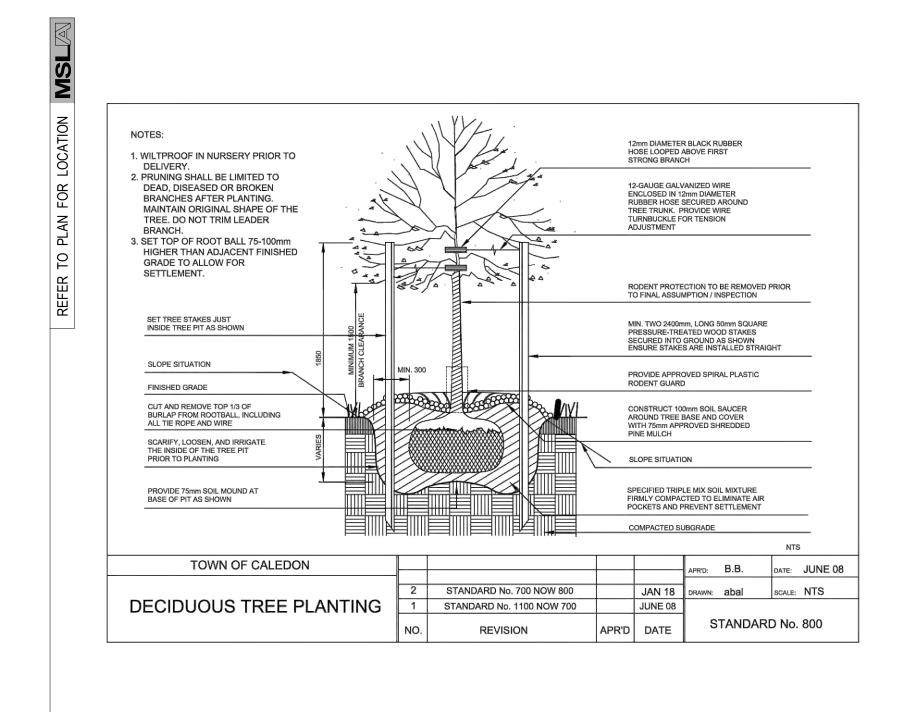


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SCALE: N.T.S. DATE:

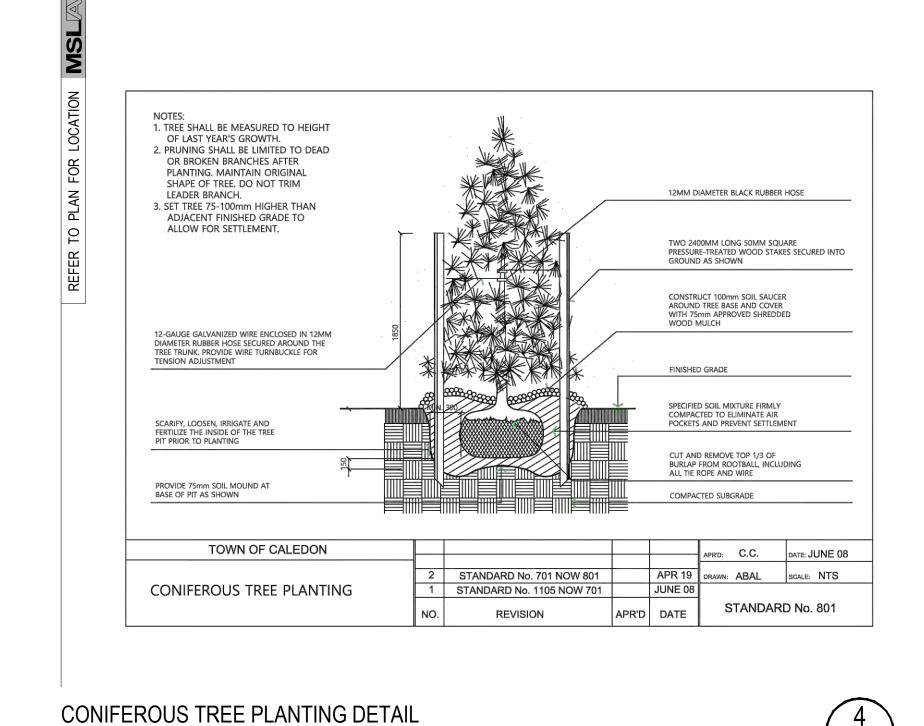


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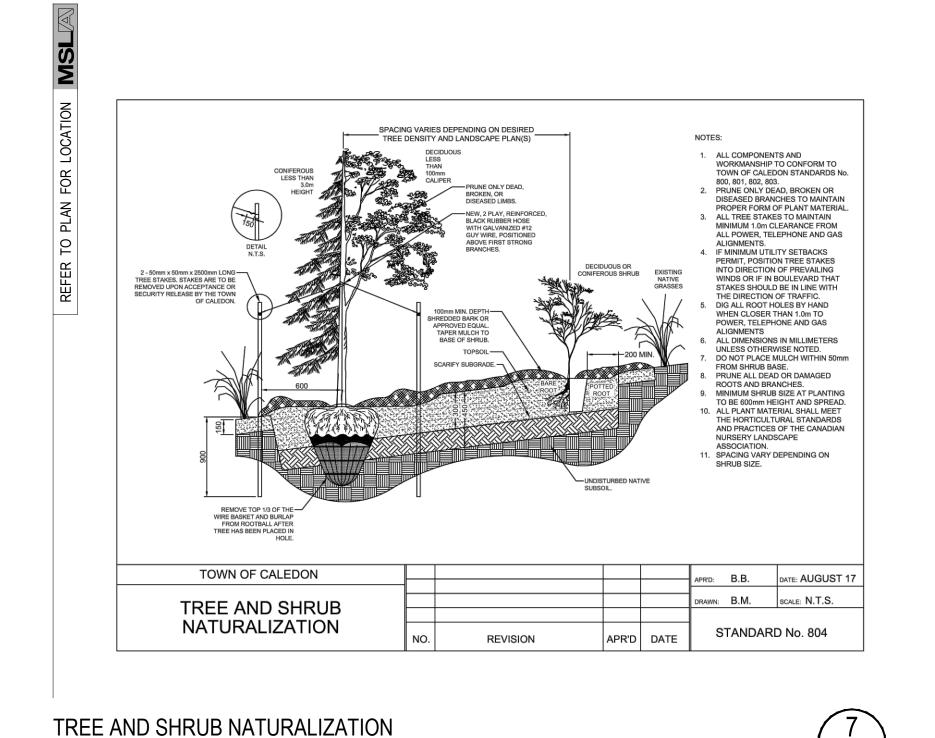





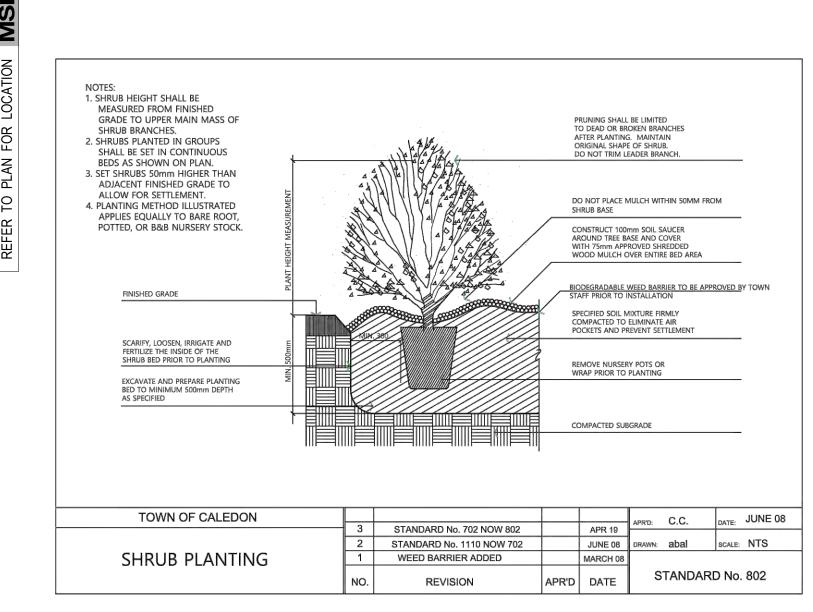

GROUNDCOVER AND PERENNIAL PLANTING DETAIL

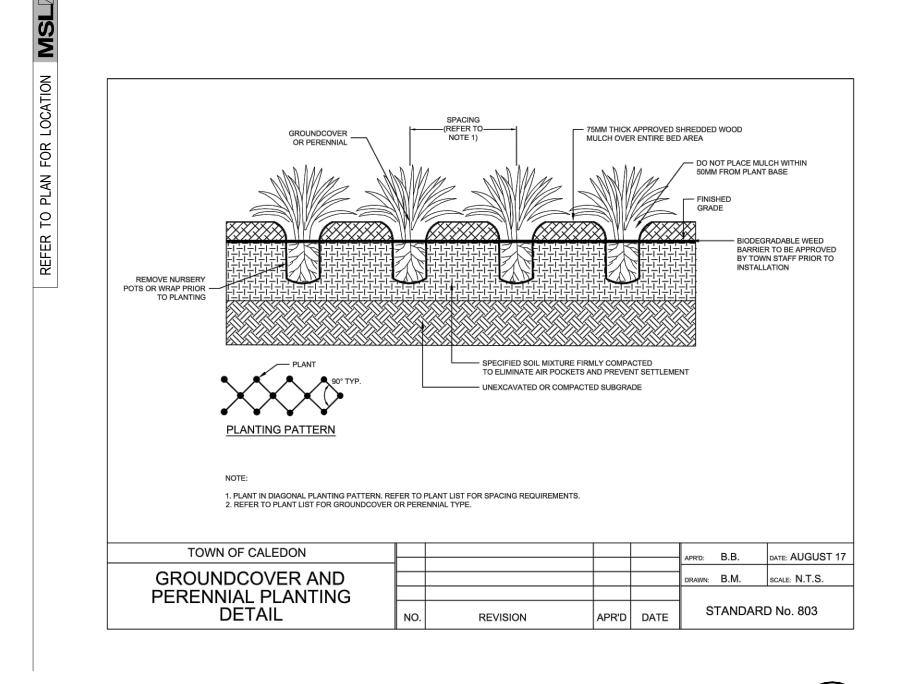
SCALE: N.T.S. DATE:



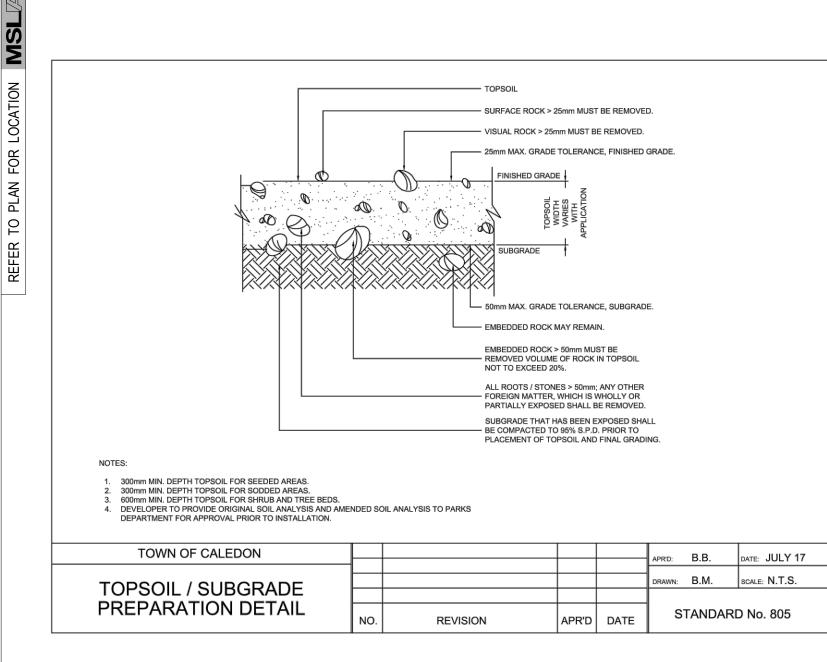

TOPSOIL / SUBGRADE PREPARATION DETAIL

SCALE: N.T.S. DATE:

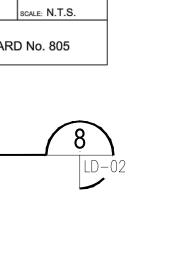

Project: Proposed Residential Development 12148 Albion Road Caledon, Ontario Scale: **As Shown** Date: **Nov. 2020** Drawn By: **D.R.** Checked By: **L.M.** Drawing Title: Landscape **Details** Project No.

**LD-02** 

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THE CORPORATION

THE TOWN OF CALEDON

10 Issued for Final OPA/ZBA Sub 11/18/24

Revised per Town Comments 04/11/24

03/15/24

01/20/23

12/08/22

11/18/22

12/22/20

12/15/20

11/19/20

Date

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07 Revised per Site Plan

06 Issued for Re-Submission

Issued for Coordination

Revised per Site Plan

03 Issued for Submission

02 Issued for Review

01 Issued for Review

No. Revision

SPA No.: **SPA 2021-0004** 


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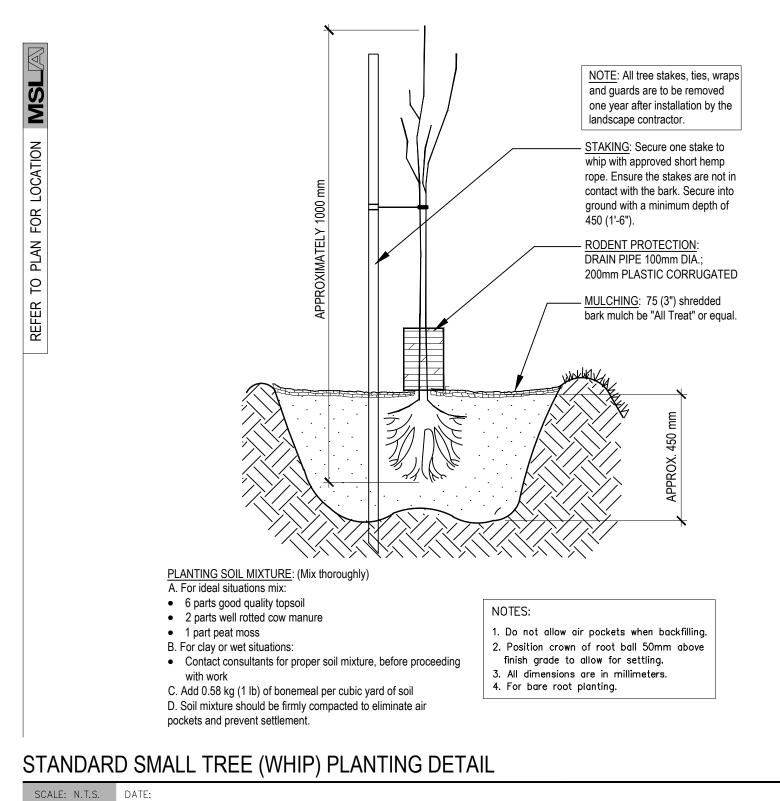
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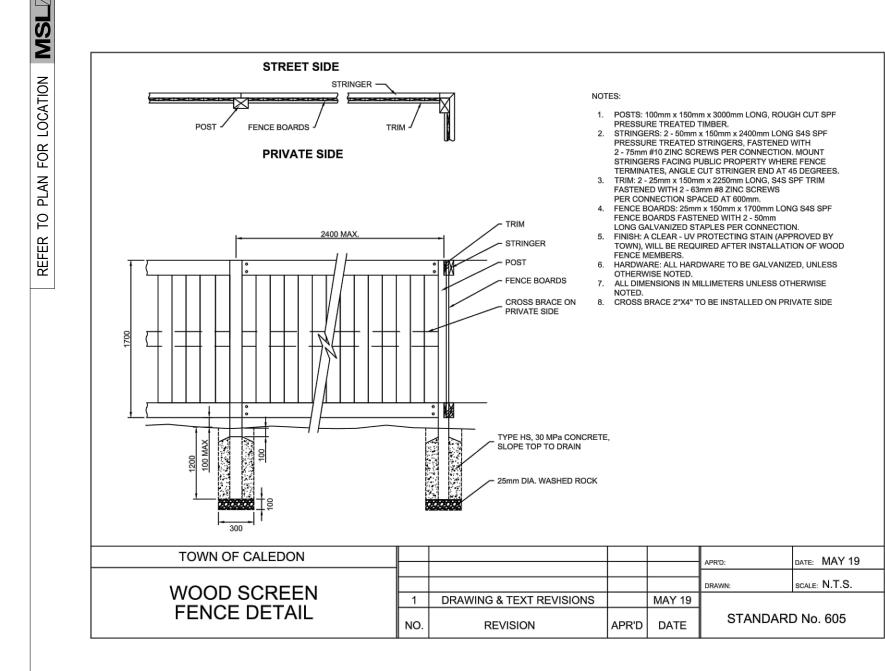
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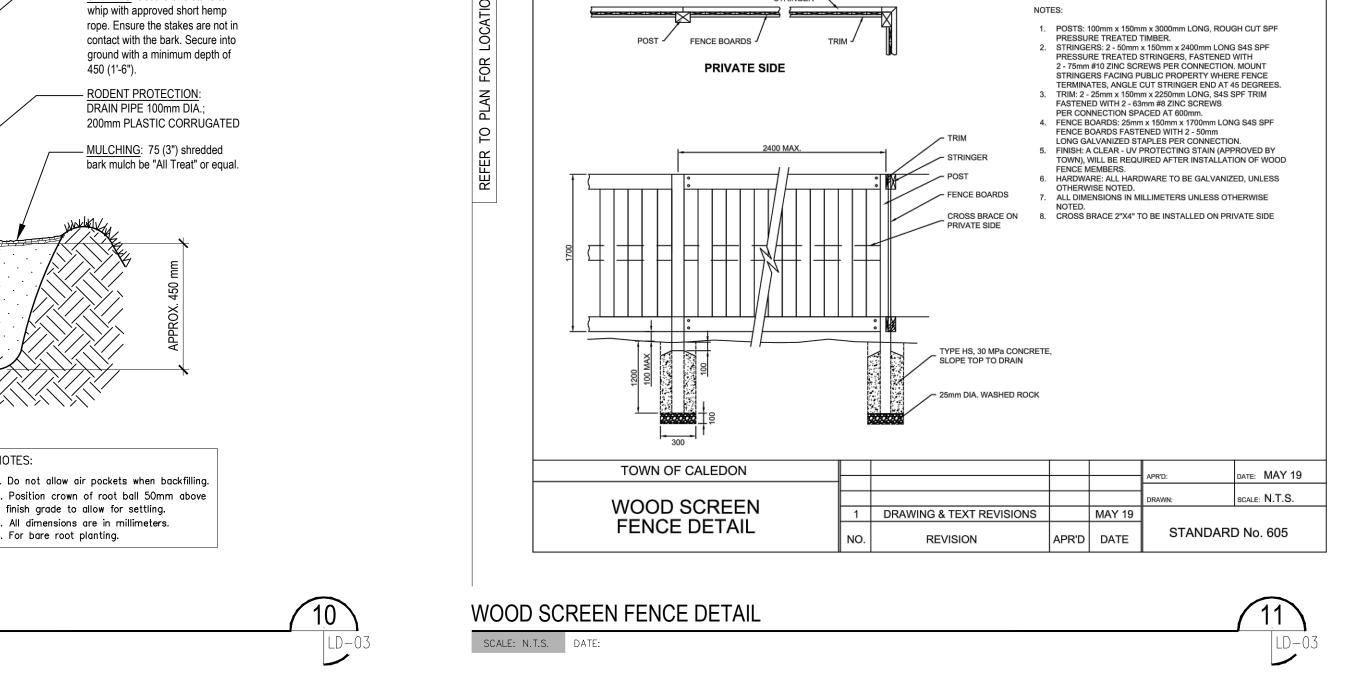
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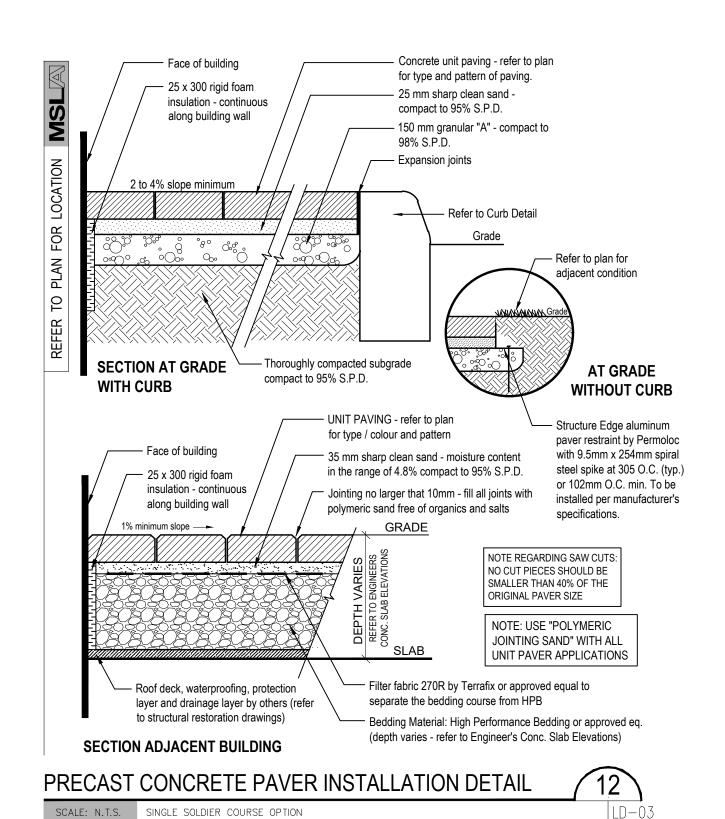
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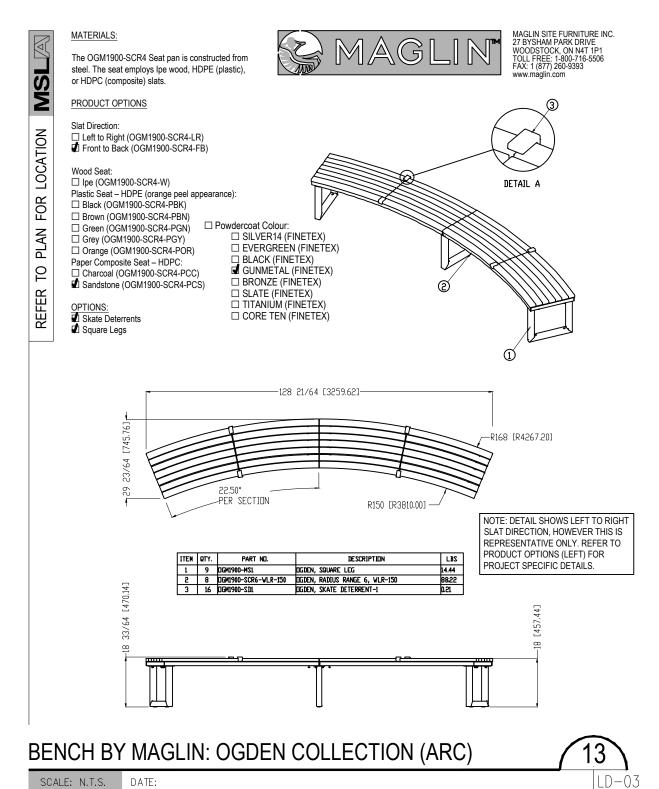










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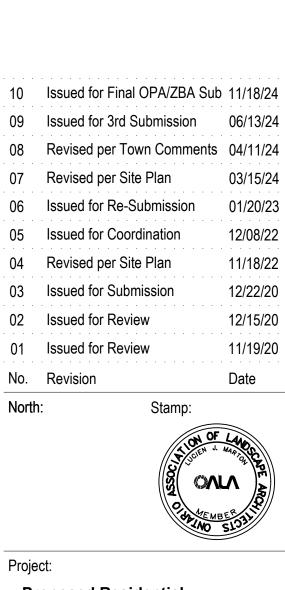


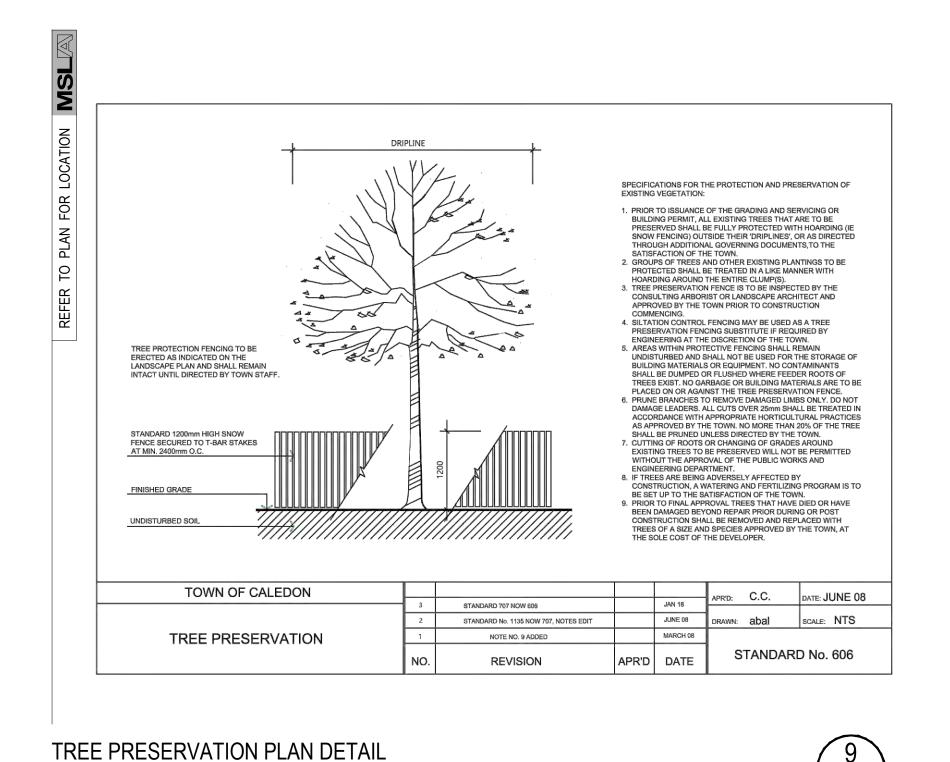

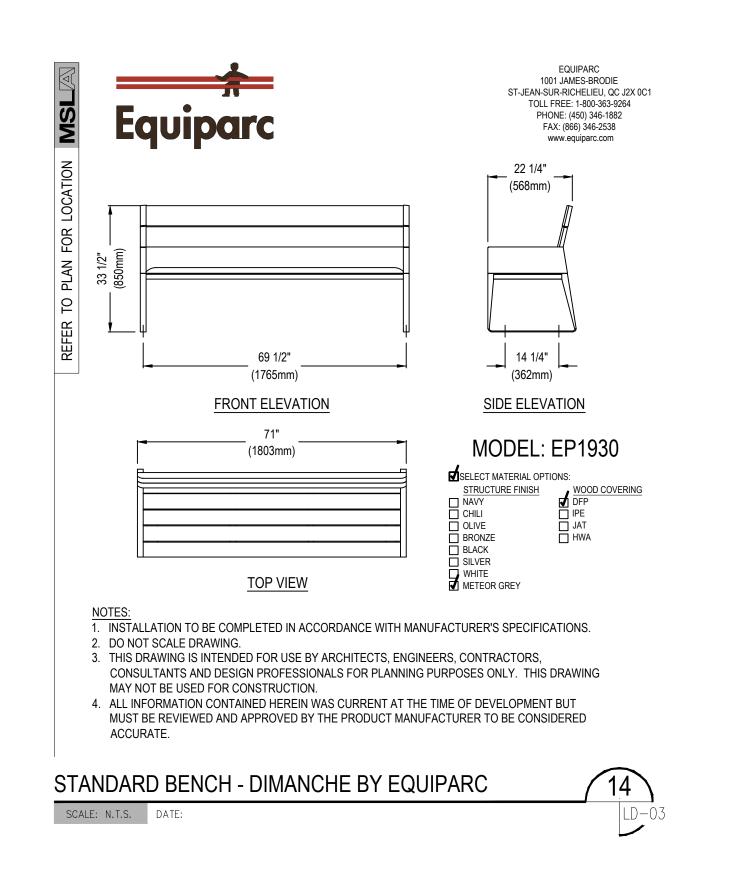

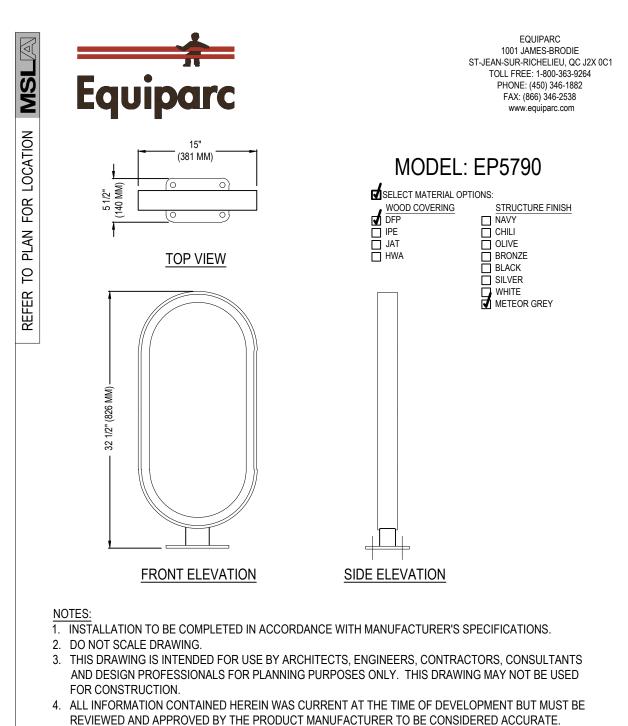**BIKE RING - MTL BY EQUIPARC** 

SCALE: N.T.S. DATE:



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THE CORPORATION THE TOWN OF CALEDON


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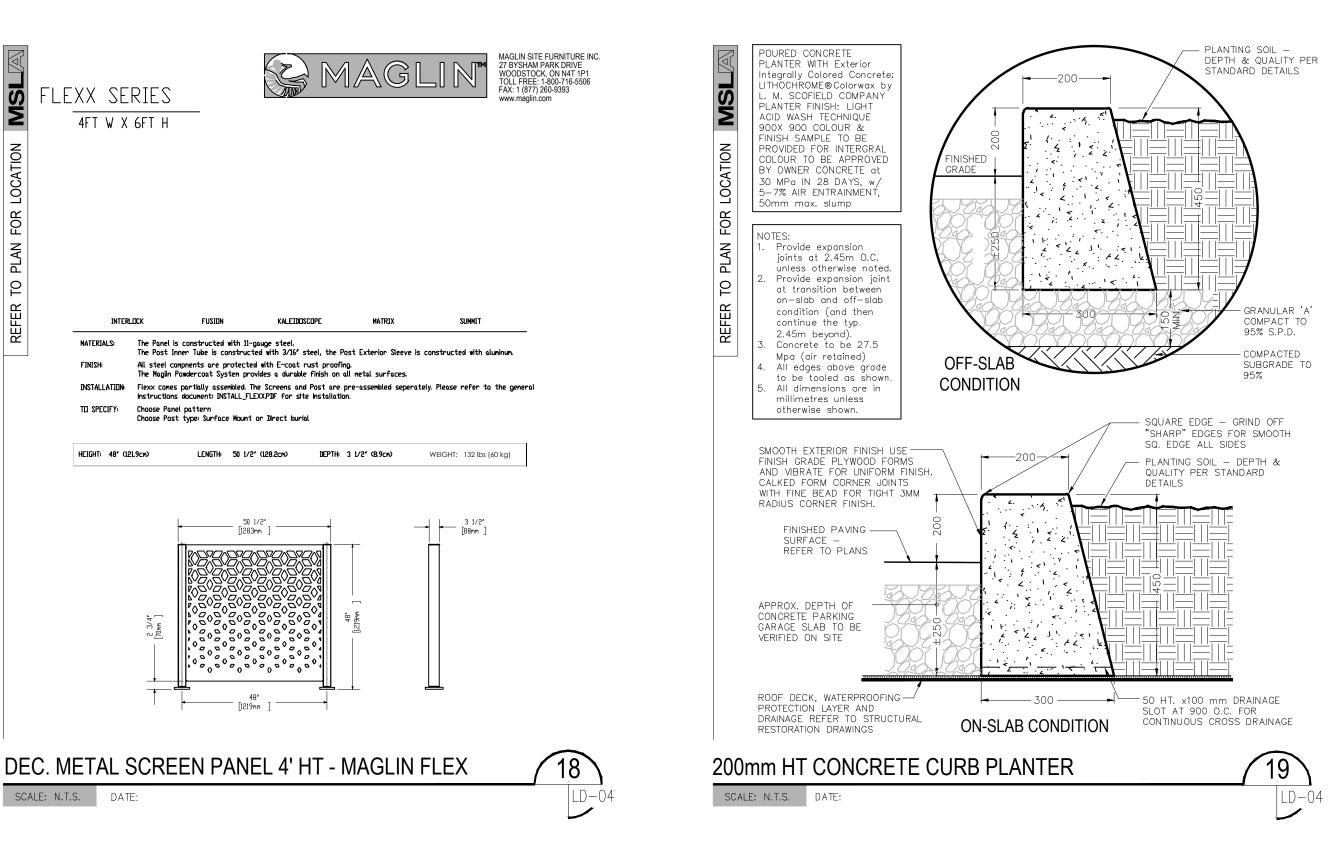
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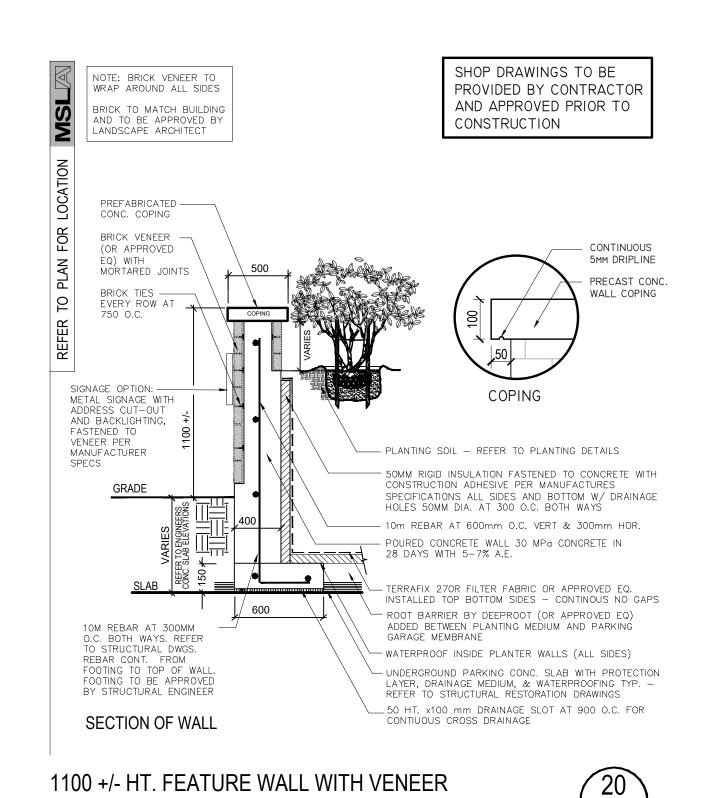
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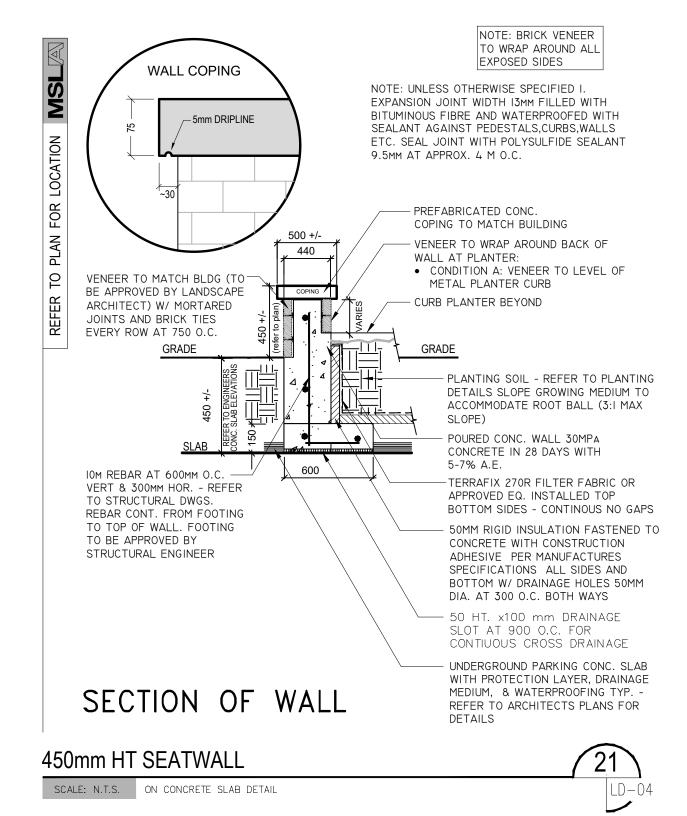
Project: **Proposed Residential** Development 12148 Albion Road Caledon, Ontario Scale: As Shown Date: Nov. 2020 Drawn By: **D.R.** Checked By: **L.M.** Drawing Title: Landscape **Details** Project No. **LD-03** 








SCALE: N.T.S. ON CONCRETE SLAB DETAIL

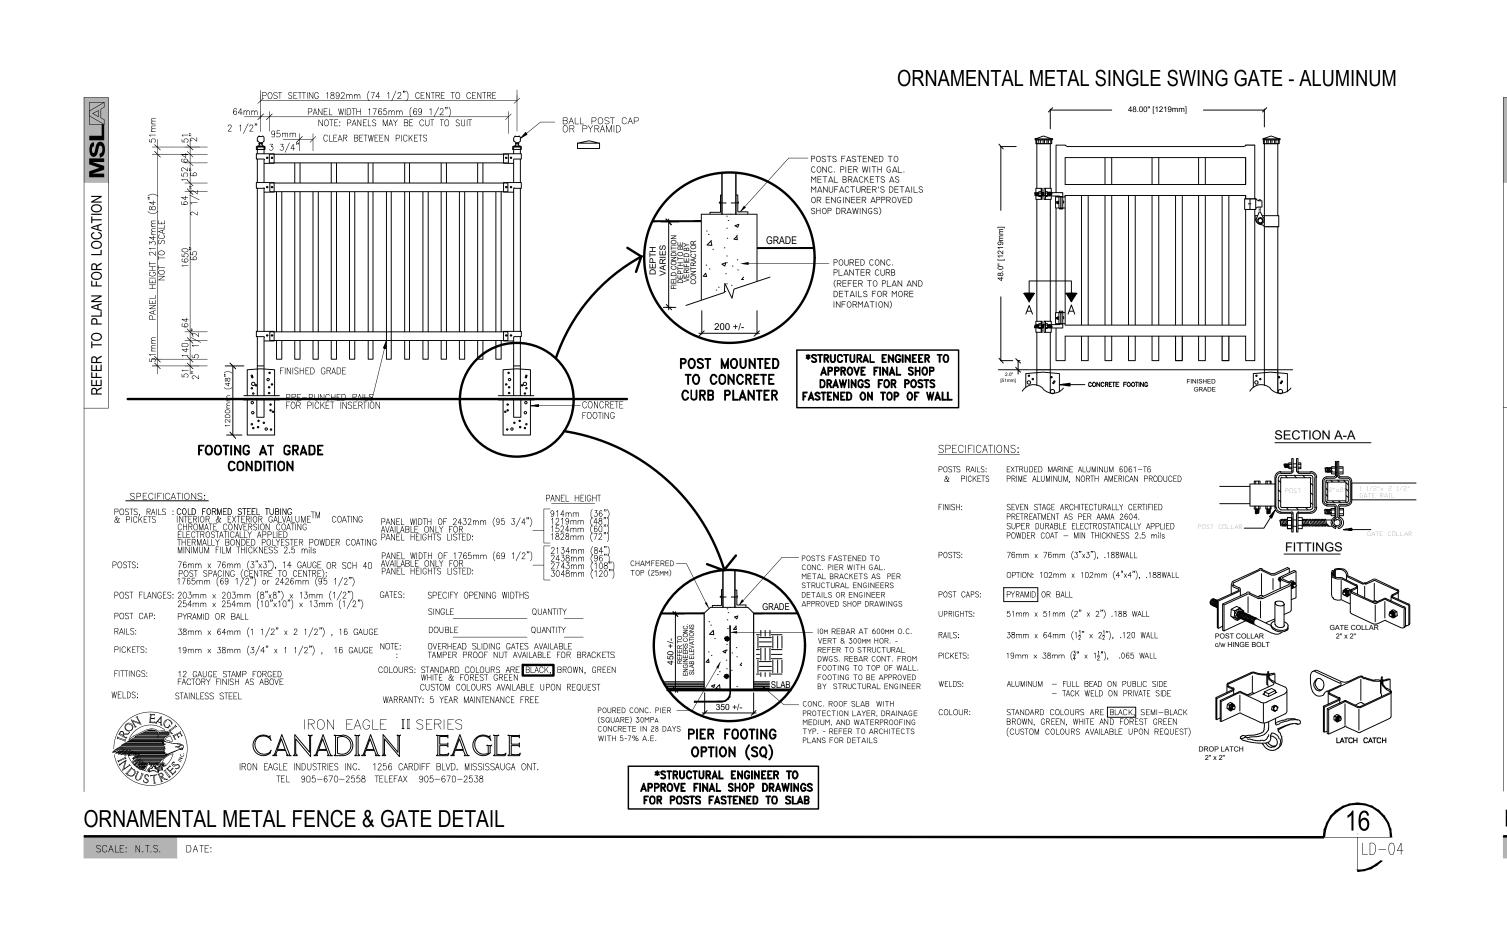

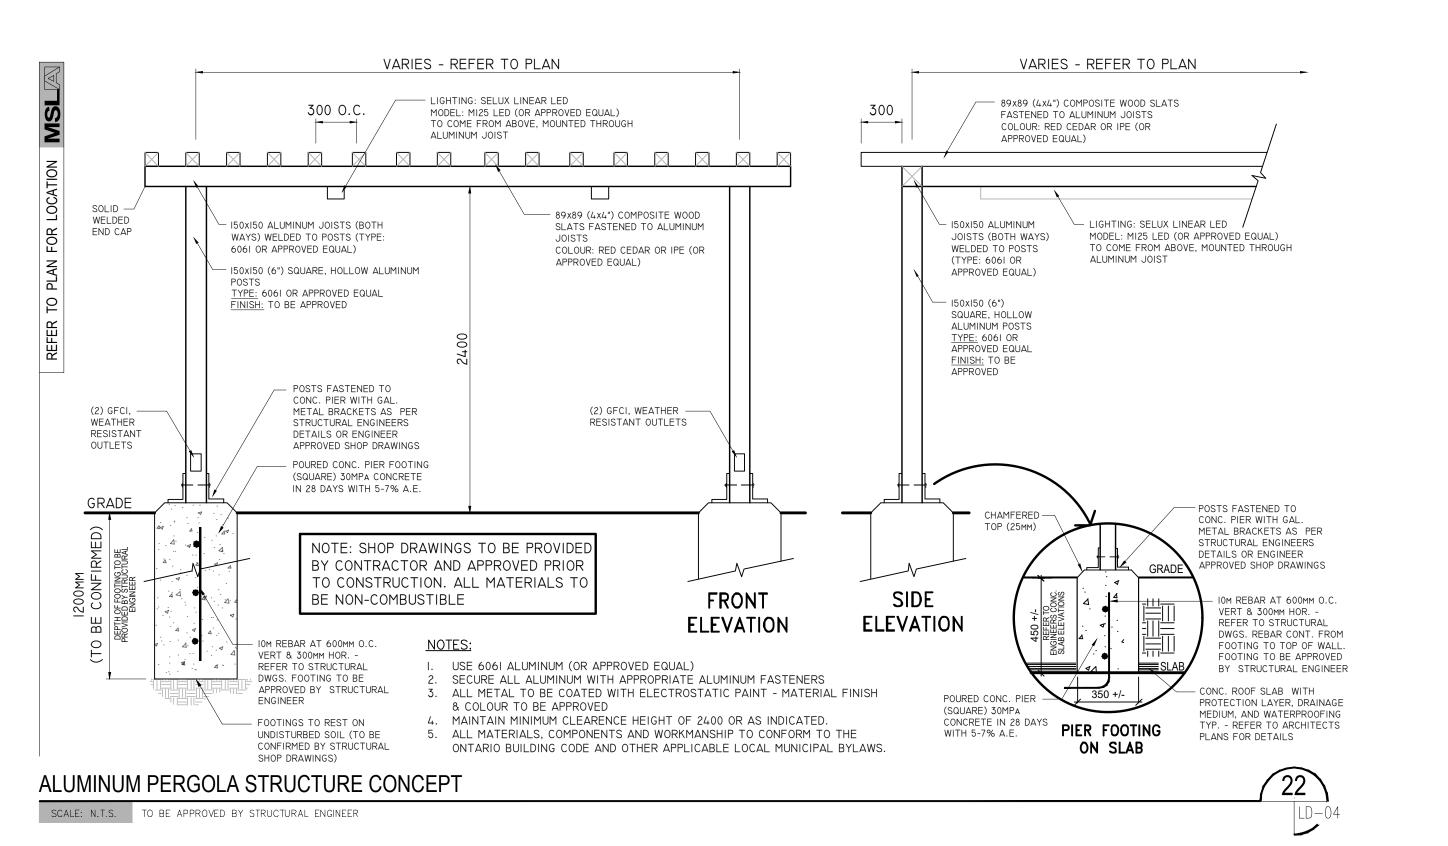



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Architect:



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SPA No.: **SPA 2021-0004** 

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Project:

North:

**Proposed Residential** Development 12148 Albion Road Caledon, Ontario

Scale: **As Shown** Date: **Nov. 2020** 


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Landscape **Details** 


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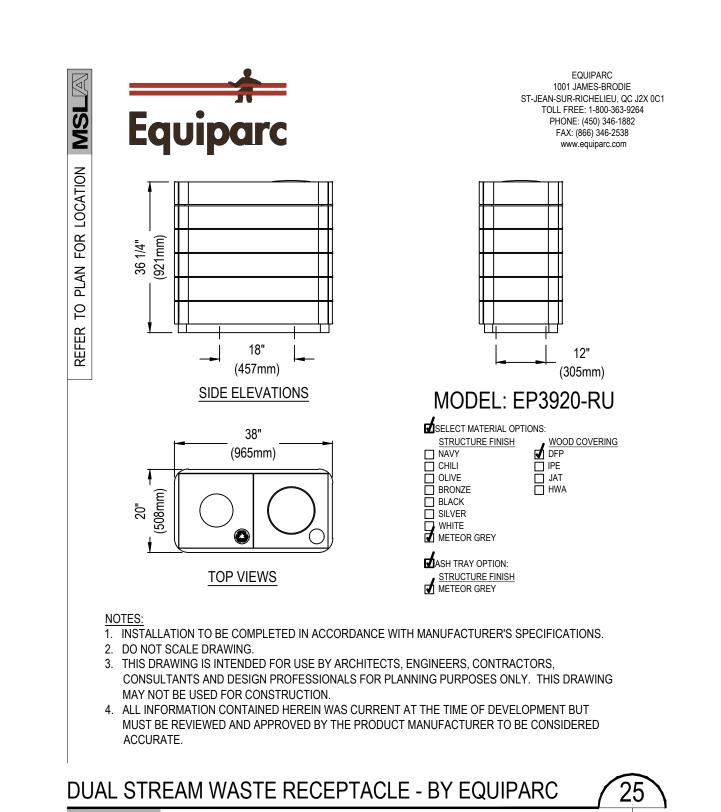
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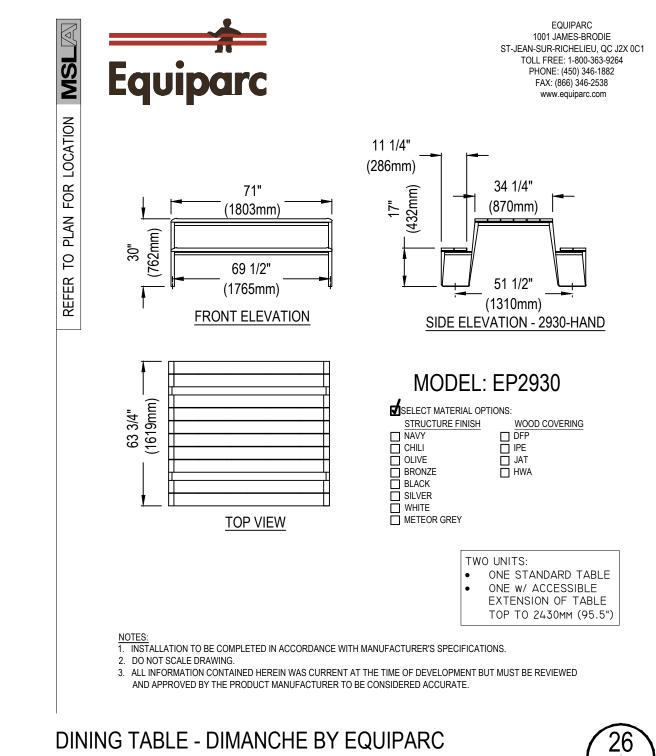
POURED-IN-PLACE RUBBER SAFETY SURFACING - ON SLAB

SCALE: N.T.S. SAFETY SURFACING OVER COMPACTED AGGREGATE BASE W/ CONC. CURB




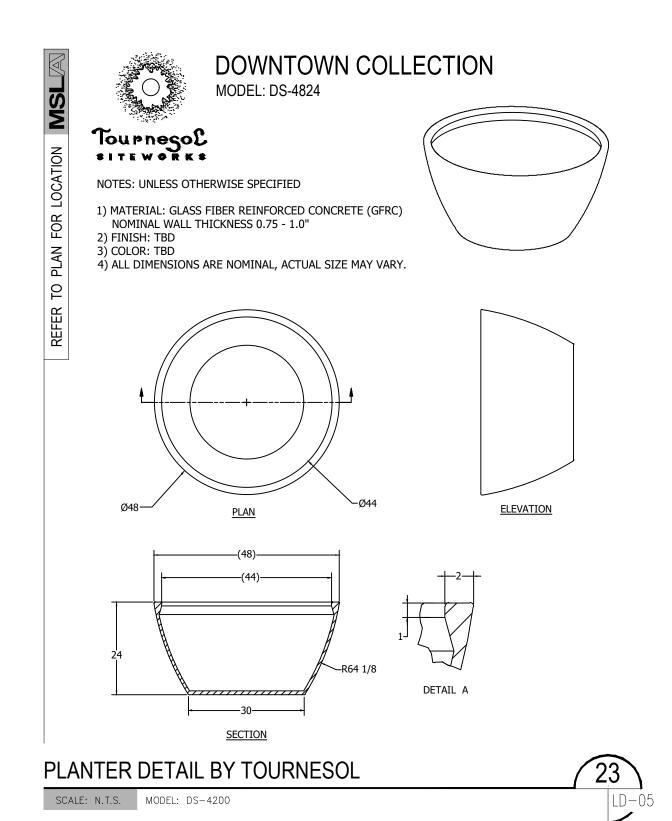


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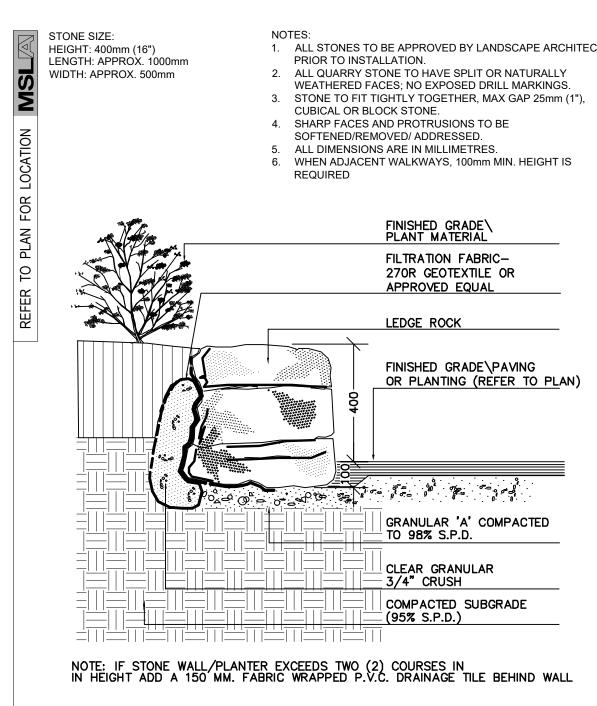


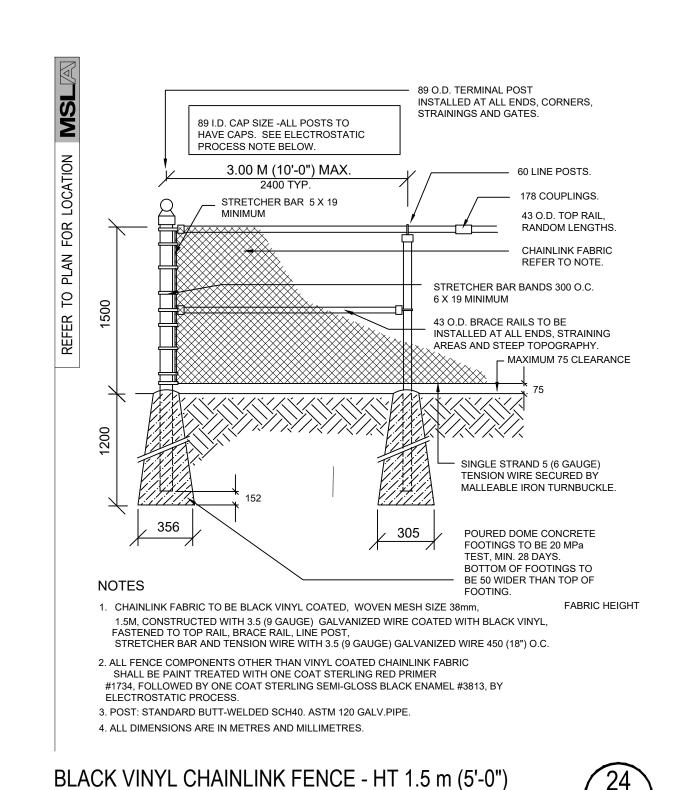
SCALE: N.T.S. DATE:

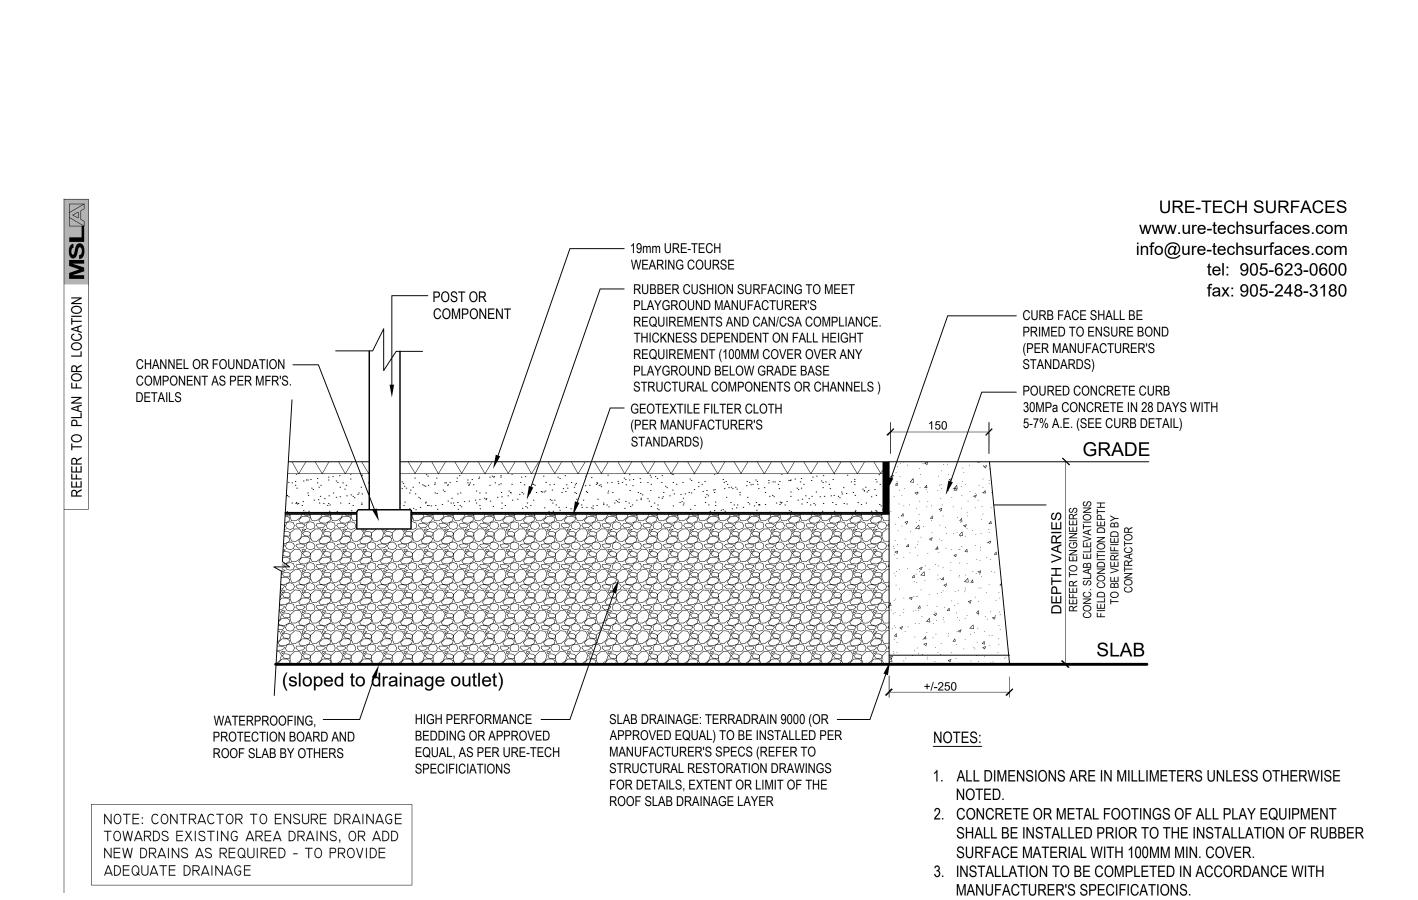

SCALE: N.T.S. DATE:



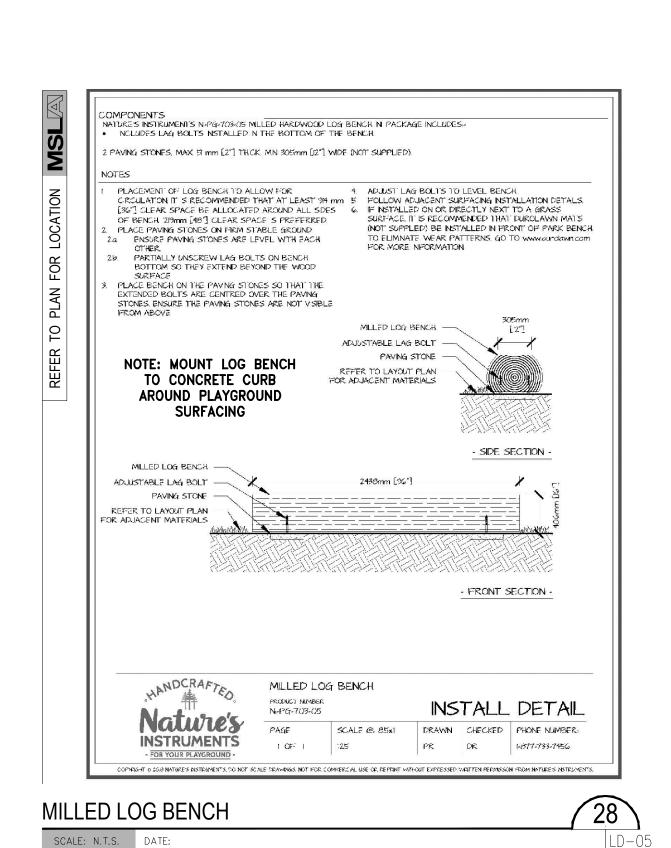

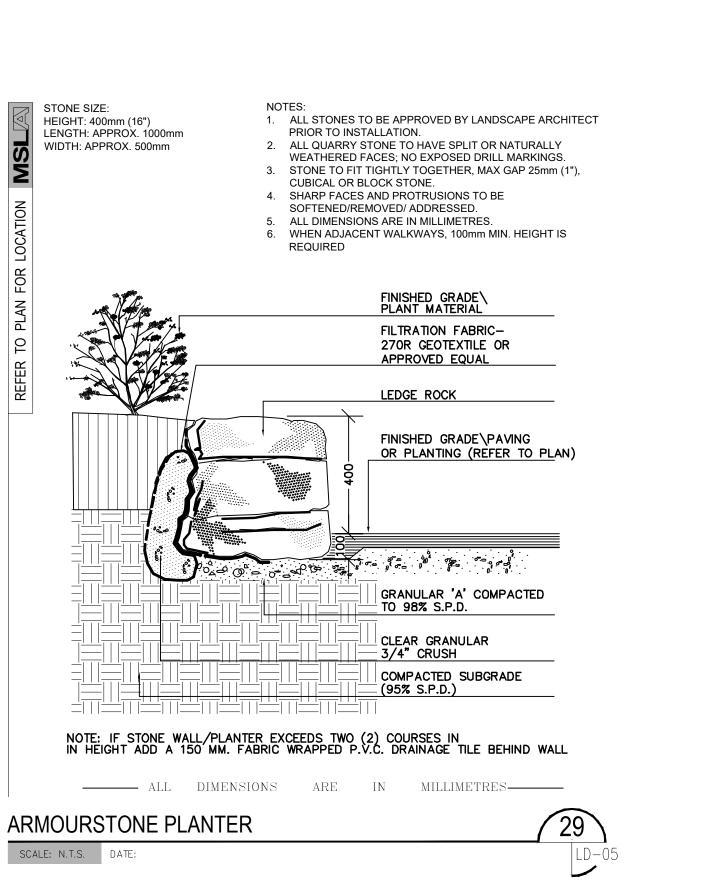



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THE TOWN OF CALEDON SPA No.: **SPA 2021-0004** 

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Project: **Proposed Residential** 

North:

Development 12148 Albion Road Caledon, Ontario

Scale: **As Shown** Date: **Nov. 2020** Drawn By: **D.R.** Checked By: **L.M.** 

Landscape


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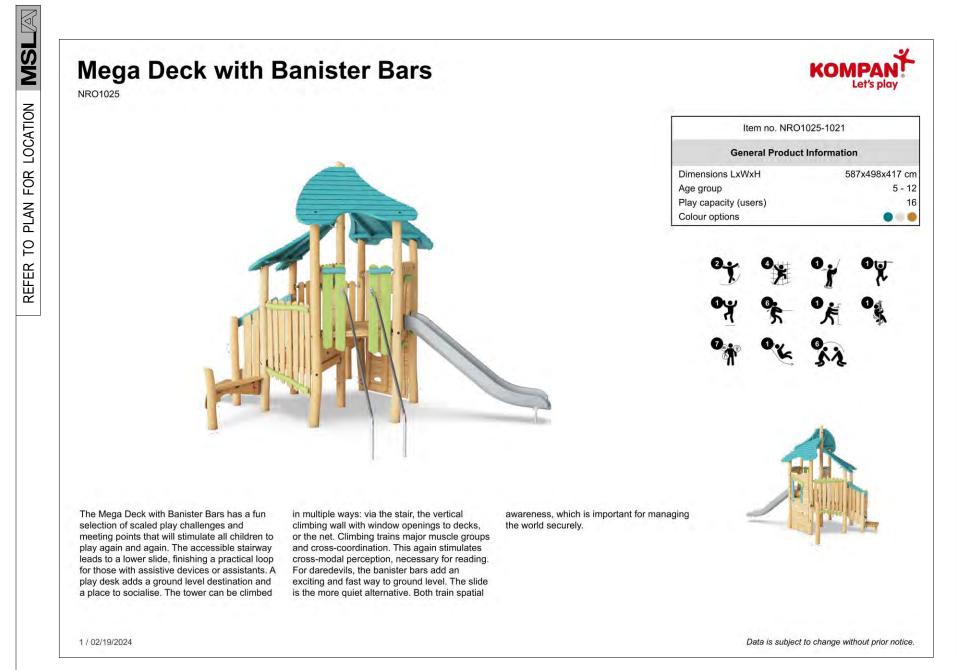






#### TOT LOT PLAYGROUND OPTION - AGES 2-5

SCALE: N.T.S. NOTE: OR APPROVED EQUAL



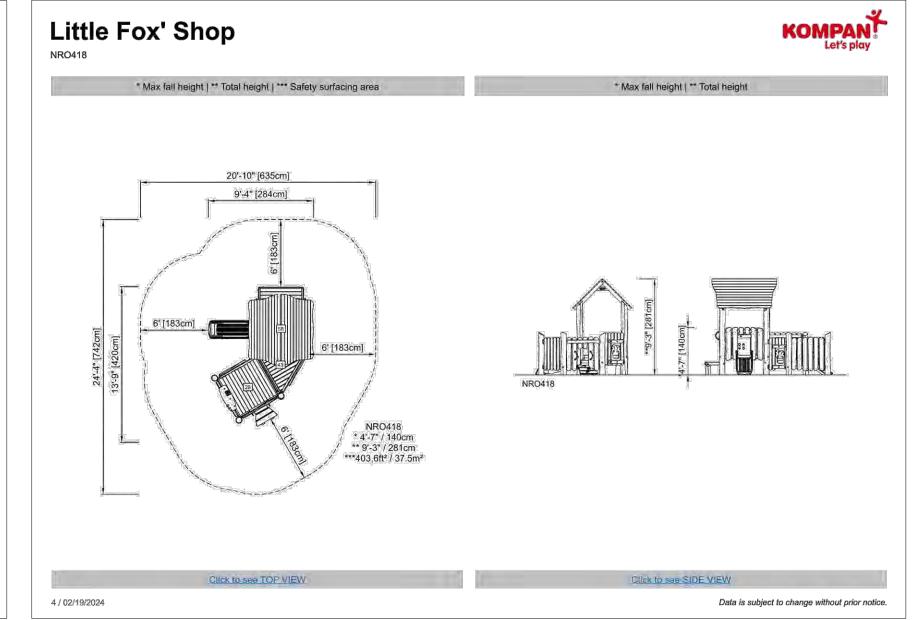

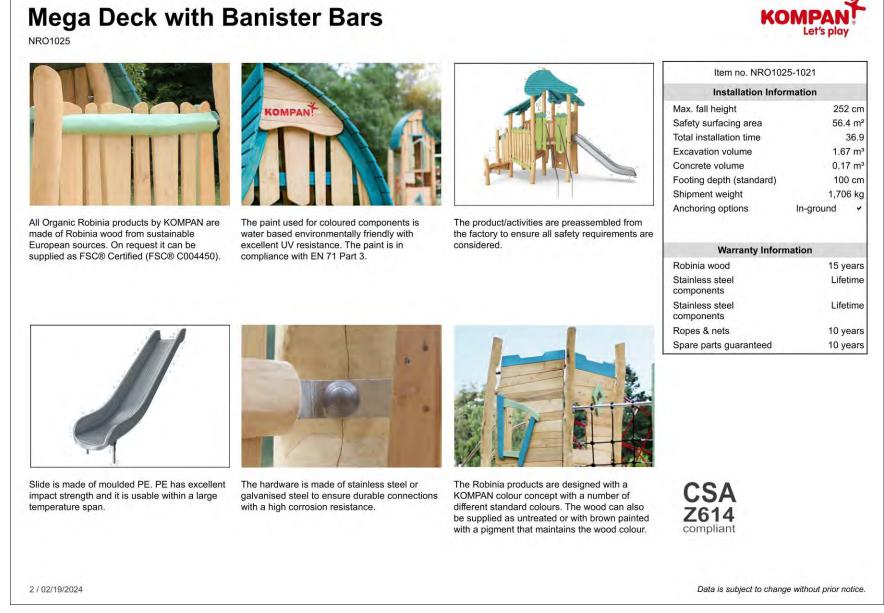

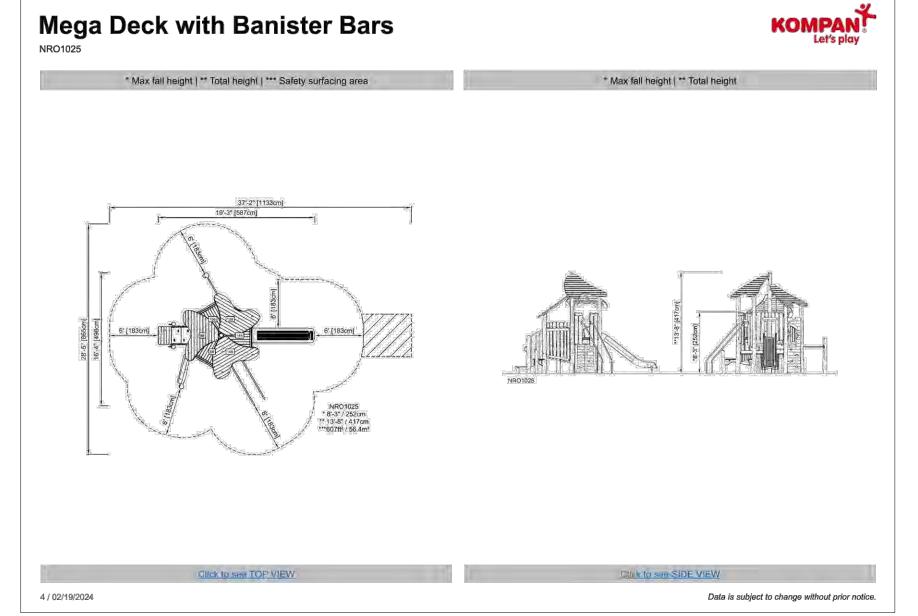

### PLAYGROUND OPTION - AGES 5-12

SCALE: N.T.S. NOTE: OR APPROVED EQUAL

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Architect:



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Issued for Coordination Revised per Site Plan

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Issued for Review No. Revision



**D.R.** Checked By: **L.M.** 

03/15/24

01/20/23

11/18/22

12/22/20

12/15/20

Date

Project:

North:

Proposed Residential Development 12148 Albion Road Caledon, Ontario


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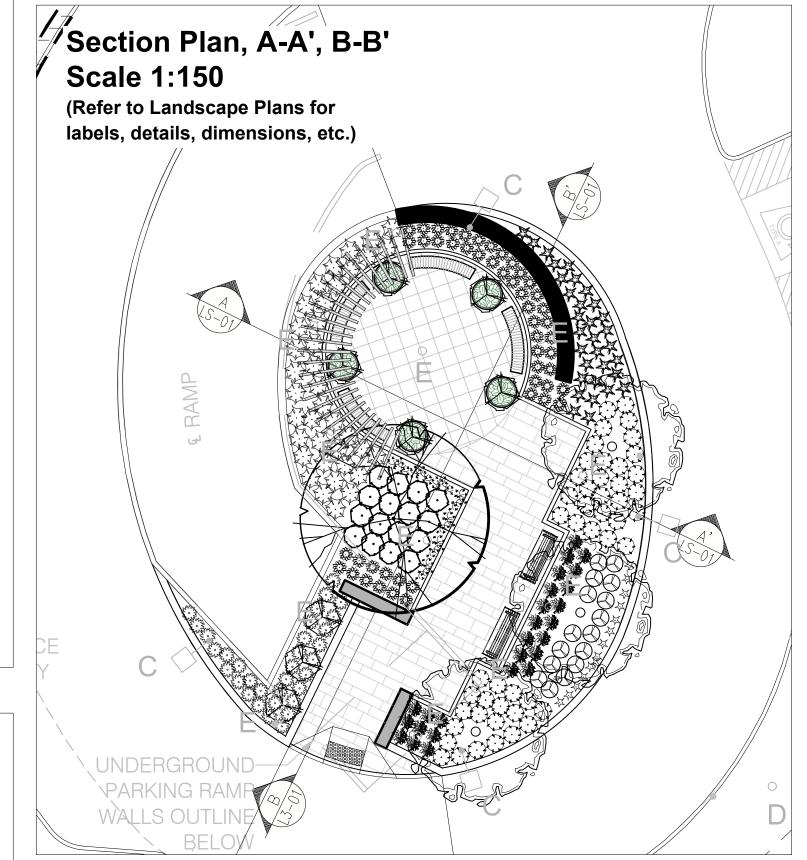
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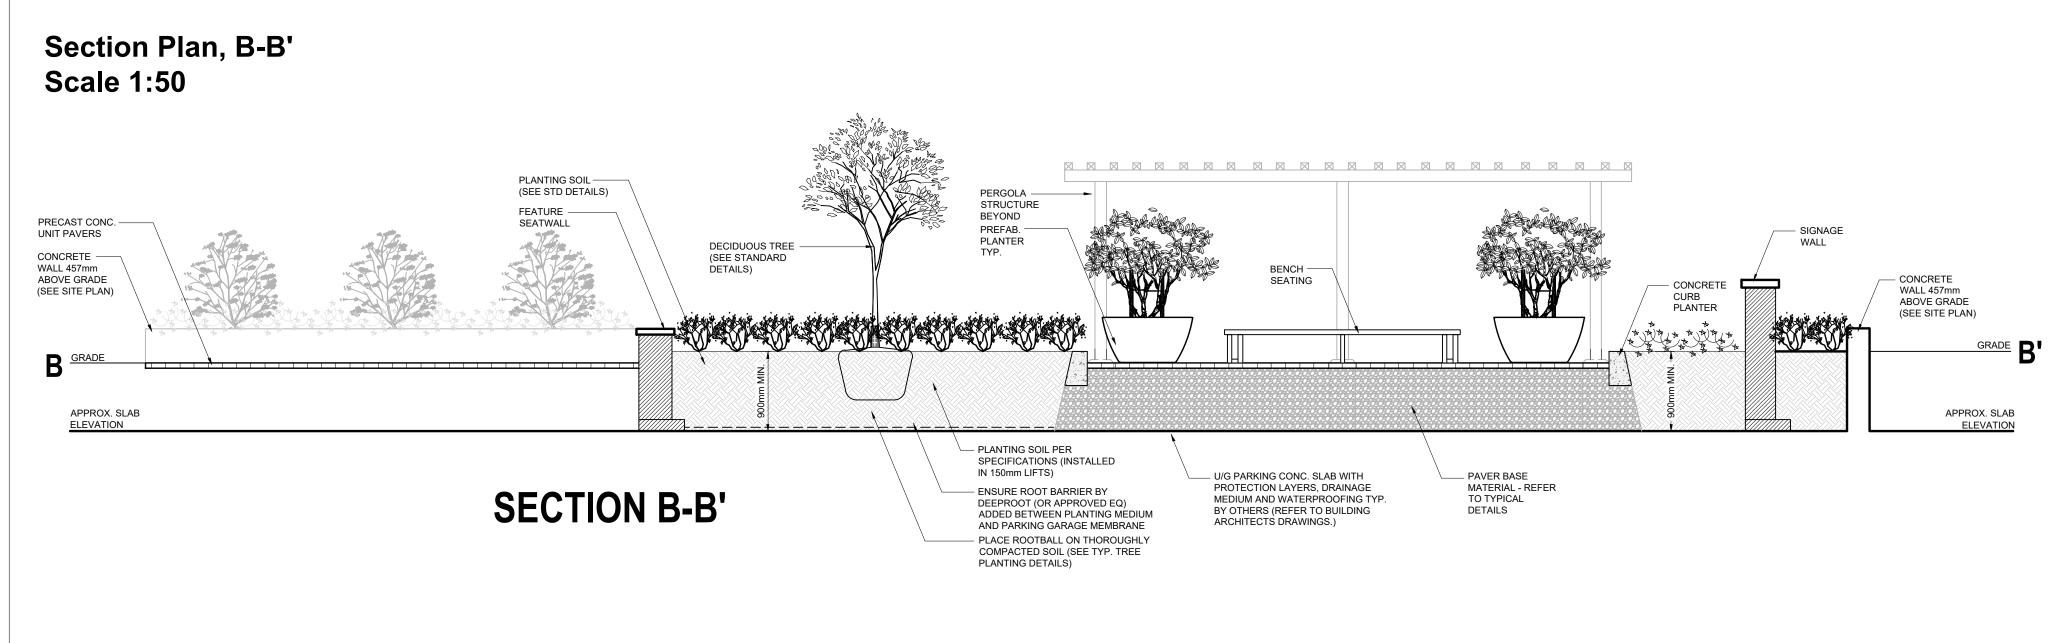
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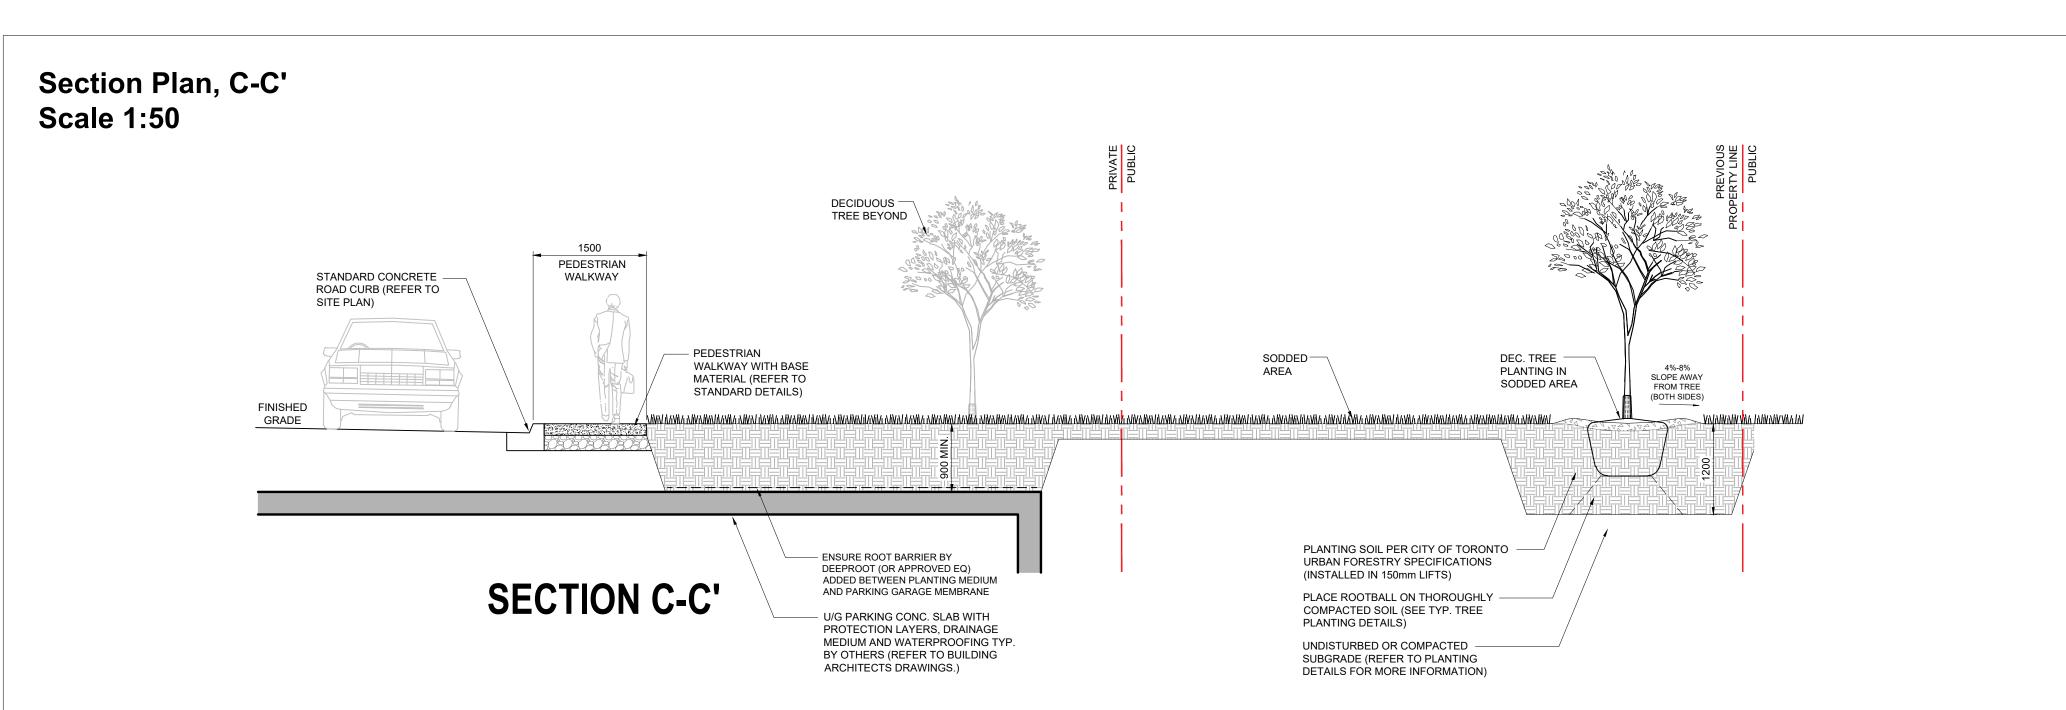
Project No.











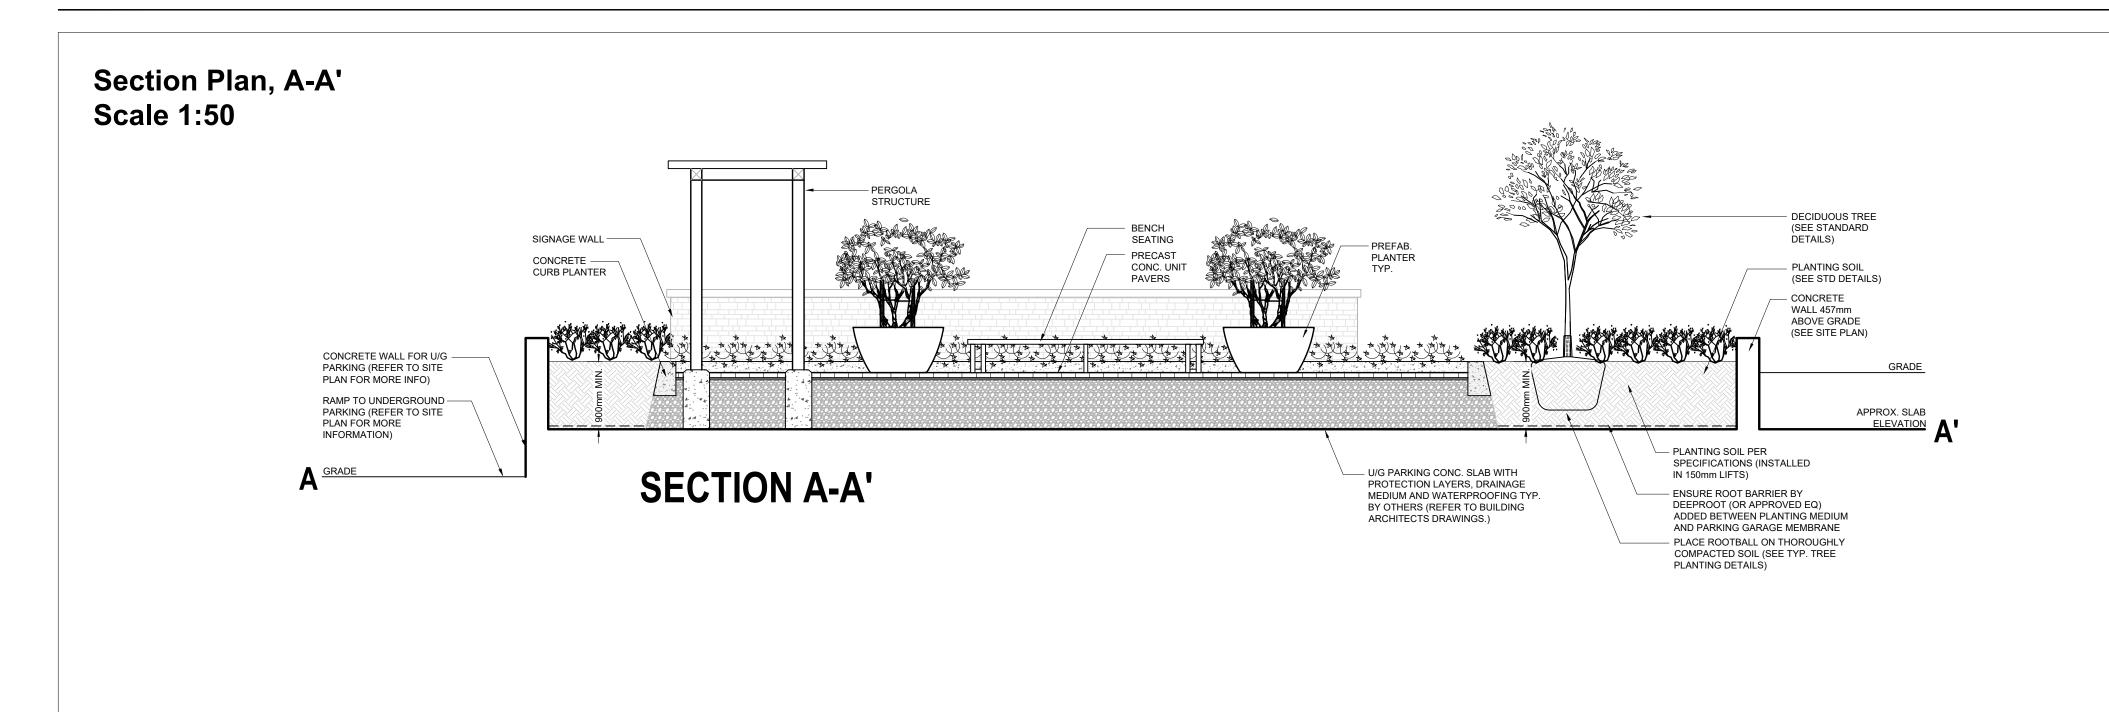

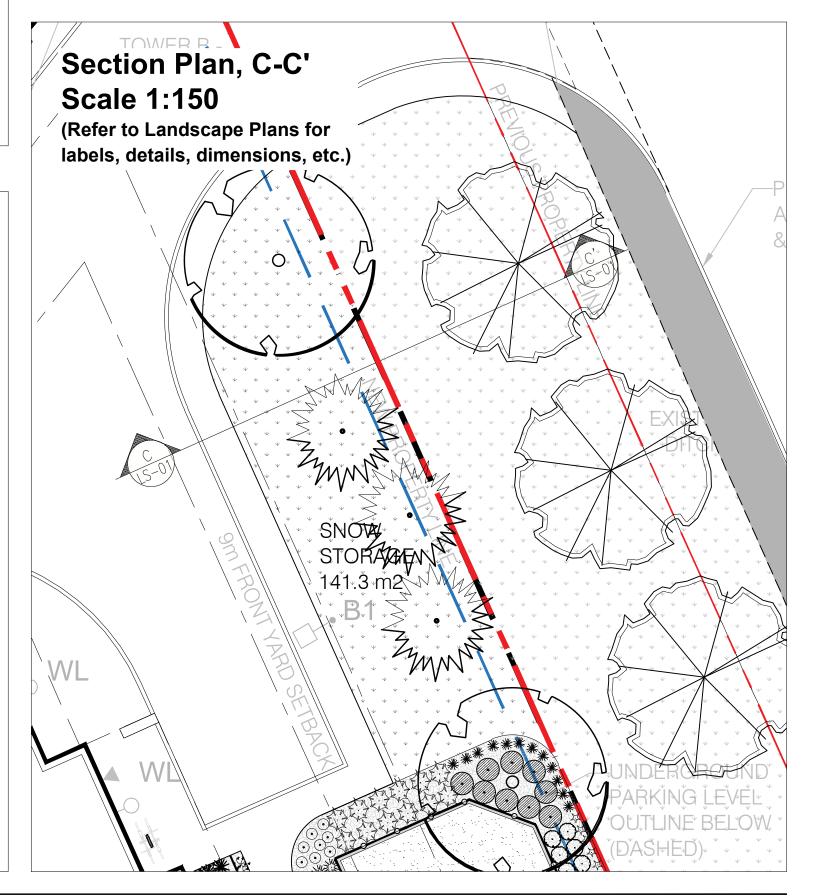

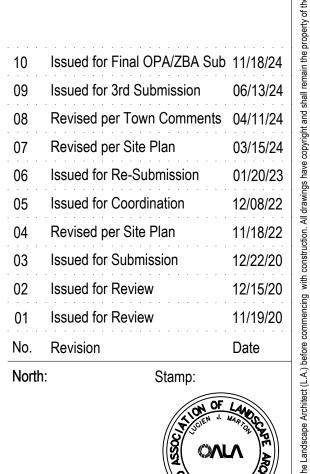

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Development 12148 Albion Road Caledon, Ontario Scale: **As Shown** Date: **Nov. 2020 D.R.** Checked By: **L.M.** Drawing Title: Landscape **Concept Sections** 

Project:

**Proposed Residential** 

Project No. **LS-0**<sup>2</sup>