



ELECTRICAL LEGEND					
SYMBOL DESCRIPTION					
C1()	LED LUMINAIRES, CEILING MOUNTED RESPECTIVELY, LETTER DENOTES FIXTURE TYPE PER SCHEDULE				
D+O +O	LIGHTING STANDARD WITH SINGLE OR DOUBLE HEADS				
$\bigcirc$ W1	LED WALL PACK, LETTER DENOTES FIXTURE TYPE PER SCHEDULE				
PC PC	PHOTOCELL				
	DIRECT CONNECTION C/W DISCONNECT SWITCH				
AFG	ABOVE FINISHED GRADE				
WP	WEATHER PROOF				
EX	DENOTES EXISTING DEVICE(S) TO REMAIN				
D	DENOTES EXISTING DEVICE(S) TO BE REMOVED				
N	DENOTES PROVIDE NEW DEVICE(S)				
1	DENOTES DRAWING REFERENCE NOTES # 1				
1 E-02	DENOTES REFER TO DETAIL #1 ON DRAWING #E-02.				

DRAWING LIST					
DWG. NO.	DRAWING TITLE				
E-11	SITE LIGHTING LAYOUT & DETAILS— ELECTRICAL				
E-12	SITE LIGHTING PHOTOMETRIC ANALYSIS & DETAILS- ELECTRICAL				

	LUMINAIRE SCHEDULE							
TYPE	SYMBOL	DESCRIPTION	LAMP	BALLAST	REMARKS			
L1	•-	EXTERIOR LED POLE LIGHT ON EXISTING POLE AT 8m AFG, C/W CLEAR FLAT GLASS LENS, TYPE 4F DISTRIBUTION, BACKLIGHT CONTROL. BLACK FINISH. APPLICATION: EXTERIOR	85W LED, 4000K, 9039 LUM	120V ELECTRONIC LED DRIVER	CURRENT LIGHTING BEACON #VIPER SERIES OR APPROVED EQUAL.			
L1a	•-	SAME AS FIXTURE 'L1', EXCEPT C/W TYPE 2 DISTRIBUTION. APPLICATION: EXTERIOR	85W LED, 4000K, 8812 LUM	120V ELECTRONIC LED DRIVER	CURRENT LIGHTING BEACON #VIPER SERIES OR APPROVED EQUAL.			
L2	•-	EXTERIOR LED POLE LIGHT, C/W CLEAR FLAT GLASS LENS, LIGHT STANDARD C/W 7m HEIGHT POLE, 1m CONCRETE BASE. TYPE 4F DISTRIBUTION, BACKLIGHT CONTROL. BLACK FINISH. APPLICATION: EXTERIOR	85W LED, 4000K, 9039 LUM	120V ELECTRONIC LED DRIVER	CURRENT LIGHTING BEACON #VIPER SERIES OR APPROVED EQUAL.			
L2a	•-	SAME AS FIXTURE 'L2', EXCEPT C/W TYPE 2 DISTRIBUTION. APPLICATION: EXTERIOR	85W LED, 4000K, 8812 LUM	120V ELECTRONIC LED DRIVER	CURRENT LIGHTING BEACON #VIPER SERIES OR APPROVED EQUAL.			
W1	Q	EXTERIOR WALL PACK, MOUNTED AT 7700mm AFF. C/W CLEAR FLAT GLASS LENS, TYPE 4 DISTRIBUTION, BLACK FINISH. APPLICATION: EXTERIOR	20.9W LED, 4000K 2310 LUM	120V ELECTRONIC LED DRIVER	CURRENT LIGHTING EXO #SLING SERIES OR APPROVED EQUAL.			
W1a	Q	SAME AS FIXTURE 'W1', EXCEPT MOUNTED AT 9200mm AFF. APPLICATION: EXTERIOR	51.76W LED, 4000K 5526 LUM	120V ELECTRONIC LED DRIVER	CURRENT LIGHTING EXO #SLING SERIES OR APPROVED EQUAL.			
W2	Q	EXTERIOR WALL PACK, MOUNTED AT 5500mm AFF. C/W CLEAR FLAT GLASS LENS, TYPE 4 DISTRIBUTION, BLACK FINISH. APPLICATION: EXTERIOR	38.1W LED, 4000K 4070 LUM	120V ELECTRONIC LED DRIVER	CURRENT LIGHTING EXO #SLING SERIES OR APPROVED EQUAL.			
W2a	Q	SAME AS FIXTURE 'W2', EXCEPT C/W 90W LED LAMP. APPLICATION: EXTERIOR	38W LED, 4000 LUM	120V ELECTRONIC LED DRIVER	CURRENT LIGHTING EXO #SLING SERIES OR APPROVED EQUAL.			
<b>W</b> 3	Q	EXTERIOR WALL PACK, MOUNTED AT 2500mm AFF. C/W CLEAR FLAT GLASS LENS, TYPE 3 DISTRIBUTION, BLACK FINISH. APPLICATION: EXTERIOR	14.9W LED, 4000K 1880 LUM	120V ELECTRONIC LED DRIVER	BEACON LIGHTING VIPER WALL SERIES #RD1 SERIES OR APPROVED EQUAL.			
W4	Q	EXTERIOR WALL PACK ON EDGE OF CANOPY, ROUND SHAPE, MOUNTED AT 2500mm AFF AT CANOPY EDGE, C/W CLEAR FLAT GLASS LENS, TYPE 4W DISTRIBUTION, BLACK FINISH. APPLICATION: EXTERIOR	19.9W LED, 4000K 2468 LUM	120V ELECTRONIC LED DRIVER	BEACON LIGHTING GEOPAK SERIES #RD1 SERIES OR APPROVED EQUAL.			
C1	0	6" DIA, EXTERIOR LED DOWNLIGHT, C/W DIA CAST ALUMINUM HOUSING, HIGH PURITY ALUMINUM REFLECTOR, WIDE DISTRIBUTION, C/W CLEAR LENS, BLACK FINISH. LOWER CANOPY IS 2223mm AFG. APPLICATION: EXTERIOR CANOPY	19.5W, LED LAMP, 4000K, 2552LM	120V ELECTRONIC LED DRIVER	HUBBELL PRESCOLITE #LFR-6RD SERIES OR APPROVED EQUAL.			

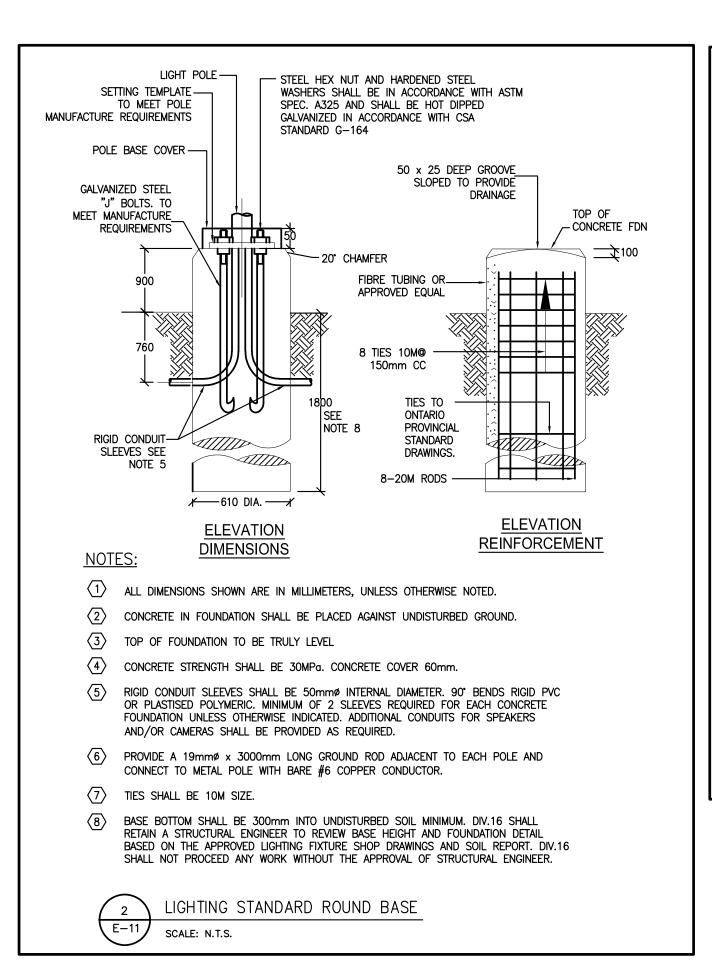

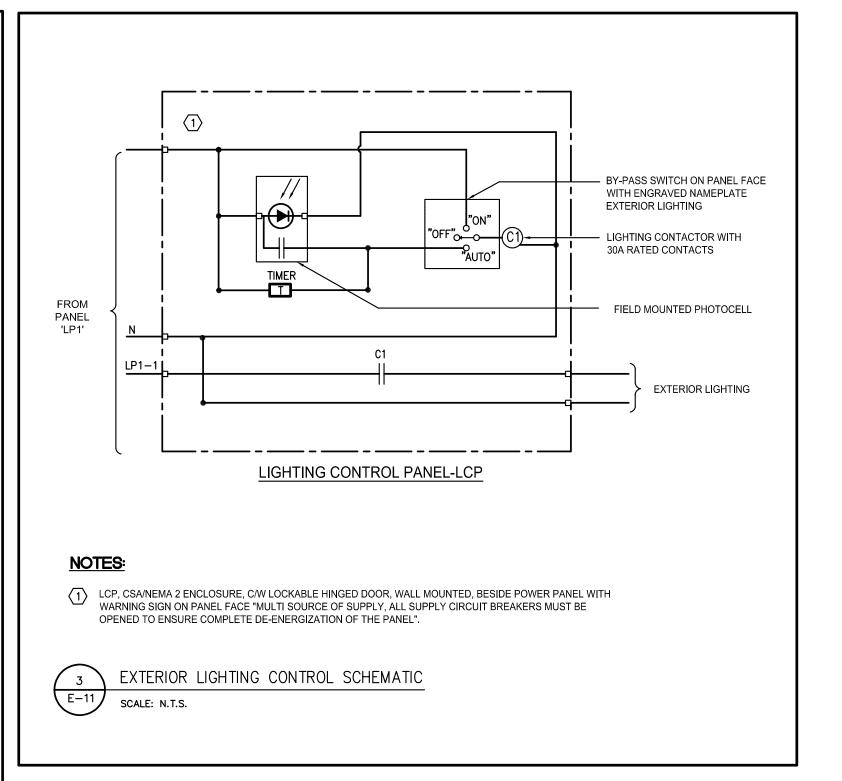

2 Issued for SPA 15 October 2024 1 Issued for Coordination 10 October 2024

EVEREST TRANSPORTATION INC. 12155 Coleraine Drive

Bolton, Ontario, L7E 3B4 project name

PROPOSED INDUSTRIAL BUILDING 12155 Coleraine Drive, Bolton, Ontario Town of Caledon Site Plan File No. SPA-

WHEELWRIGHT GROUP INC. ENGINEERS AND CONTRACTORS 110 FENMAR DRIVE TORONTO, ONTARIO, M9L 1M5

TEL: (416) 741-2630 FAX: (416) 741-9059


HL ENGINEERING LTD
7725 BIRCHMOUNT RD, UNIT 46, MARKHAM,
ON L3R 9X3 905-713-0003 www.hlengineering.ca

scale AS SHOWN drawn FRL

date August 2024 checked MJL

SITE LIGHTING

project & drawing no. 24038 **E-11** LAYOUT & DETAILS

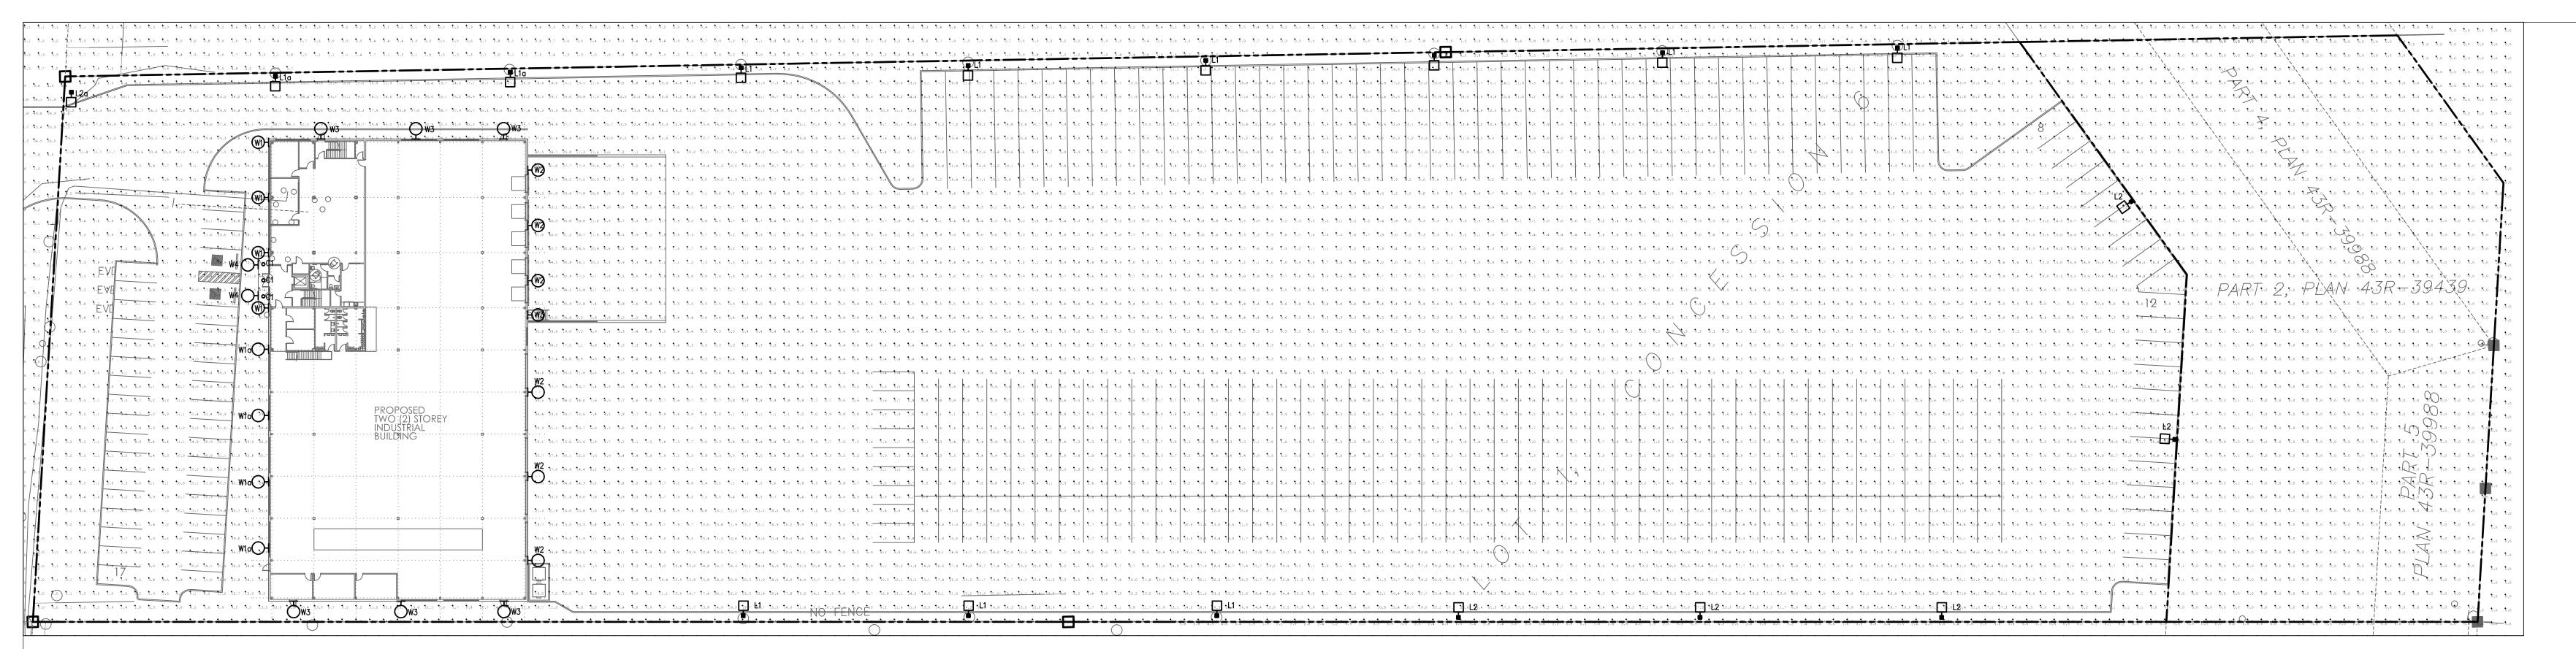

SITE LIGHTING PHOTOMETRIC - ELECTRIC

Calculation Summary								
Label	CalcType	Units	Avg	Max	Min	Avg/Min	Max/M:	
BF PARKING	Illuminance	Lux	54.08	91.7	21.7	2.49	N.A.	
DRIVEWAY AND PARKING	Illuminance	Lux	18.70	126.7	0.5	37.40	N.A.	
PROPERTY LINE SPILL OF LIGHT	Illuminance	Lux	0.88	63.8	0.0	N.A.	N.A.	
WHOLE SITE AREA	Illuminance	Lux	7.10	474.5	0.0	N.A.	N.A.	

2 Issued for SPA1 Issued for Coordination

no. issued / revision

EVEREST TRANSPORTATION INC.
12155 Coleraine Drive
Bolton, Ontario, L7E 3B4

15 October 2024 10 October 2024

project name

PROPOSED INDUSTRIAL BUILDING
12155 Coleraine Drive, Bolton, Ontario
Town of Caledon Site Plan File No. SPA-

WHEELWRIGHT GROUP INC.
ENGINEERS AND CONTRACTORS

110 FENMAR DRIVE
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title
SITE LIGHTING
PHOTOMETRIC &

PHOTOMETRIC &
DETAILS- ELECTRICAL

project & drawing no.