


Appendix G: Existing Conditions Erosion Hazard Delineation

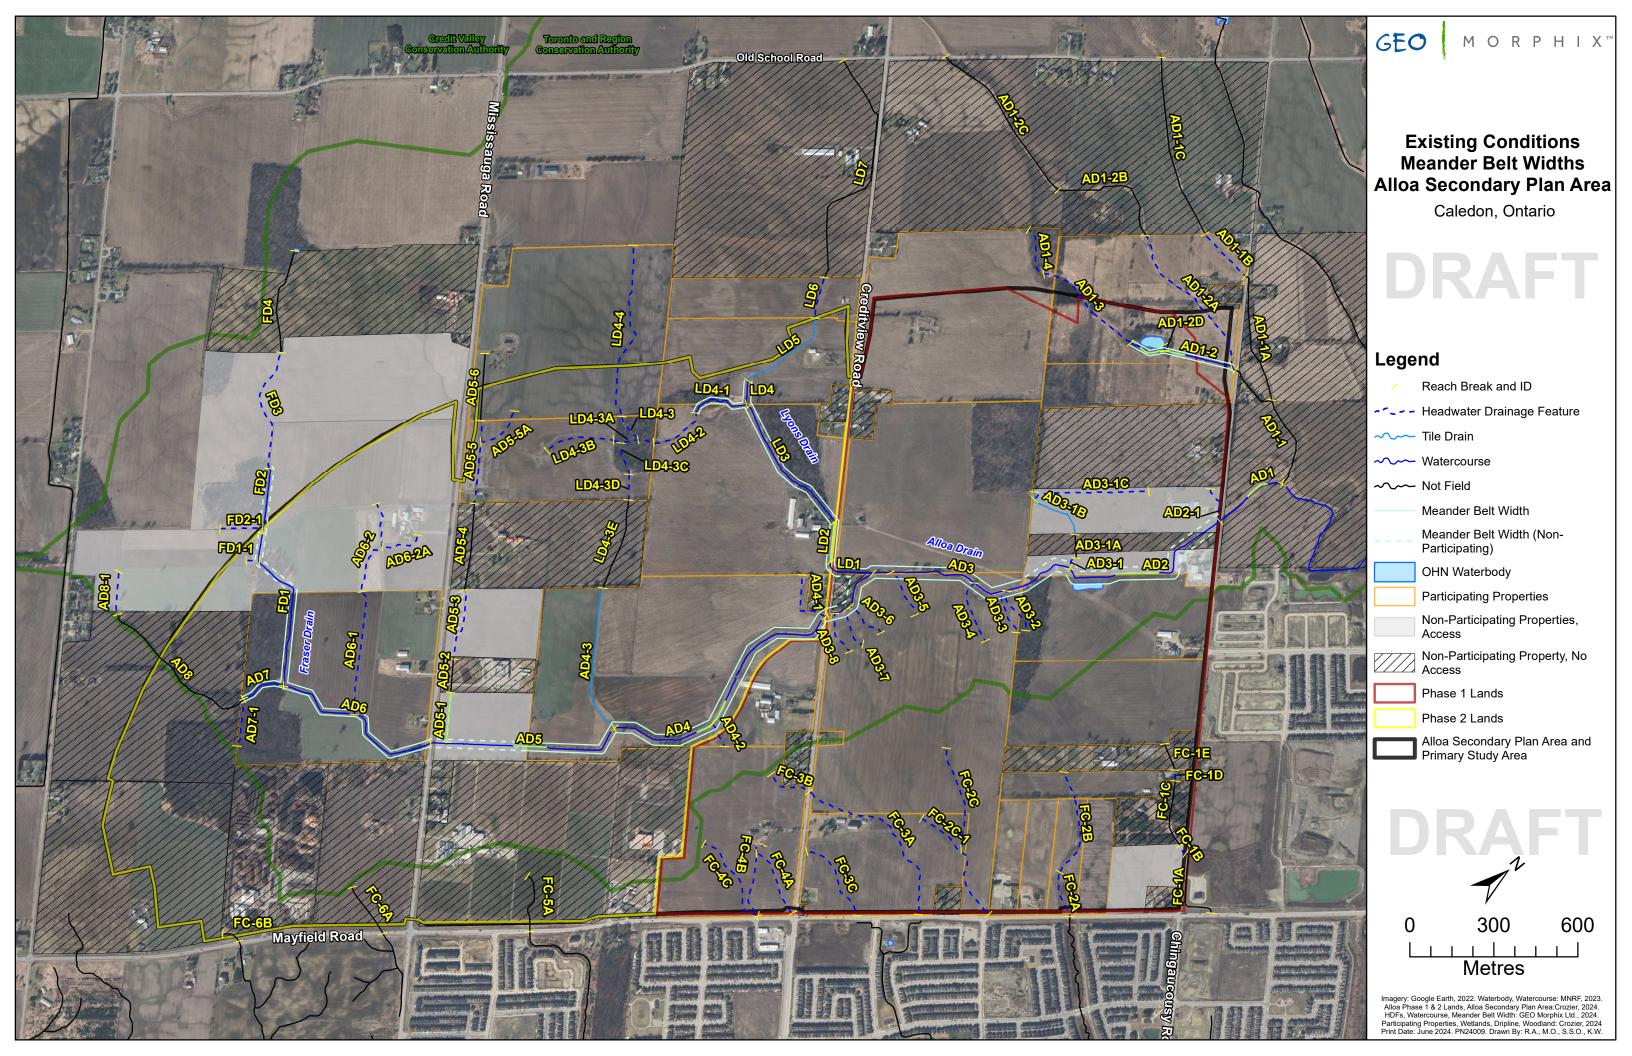

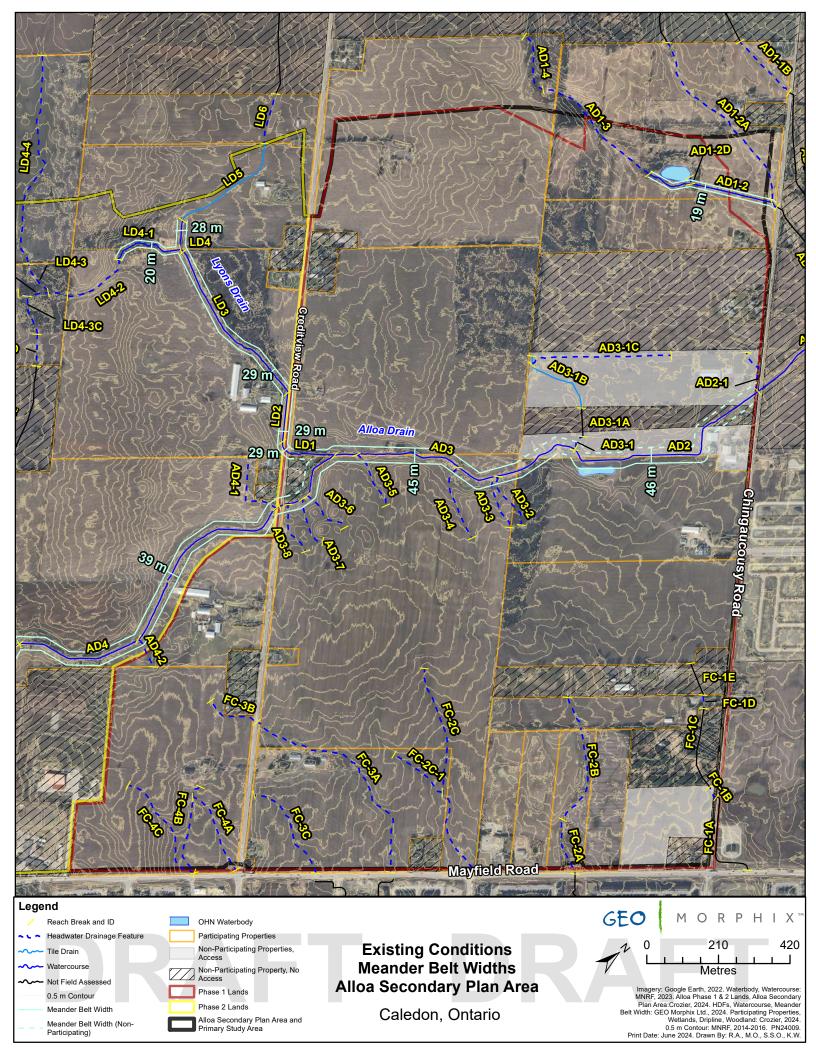


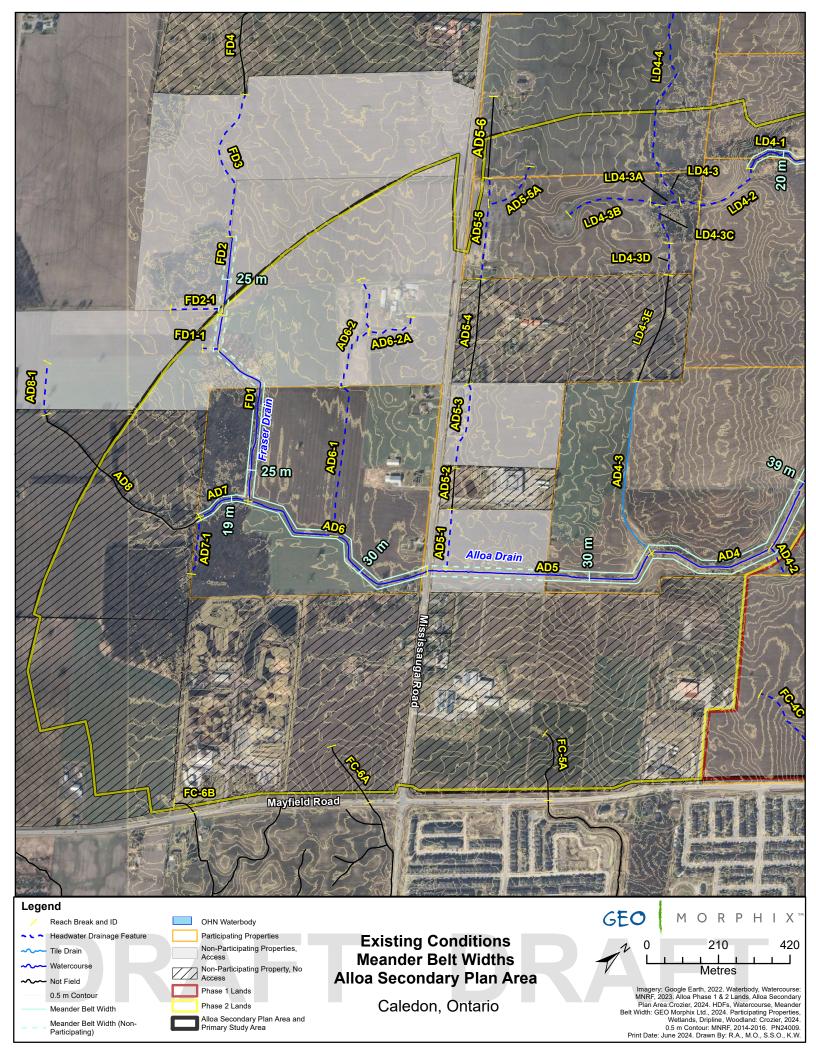



Appendix H:
Proposed Stormwater Management Pond Locations and
Erosion Mitigation Approach



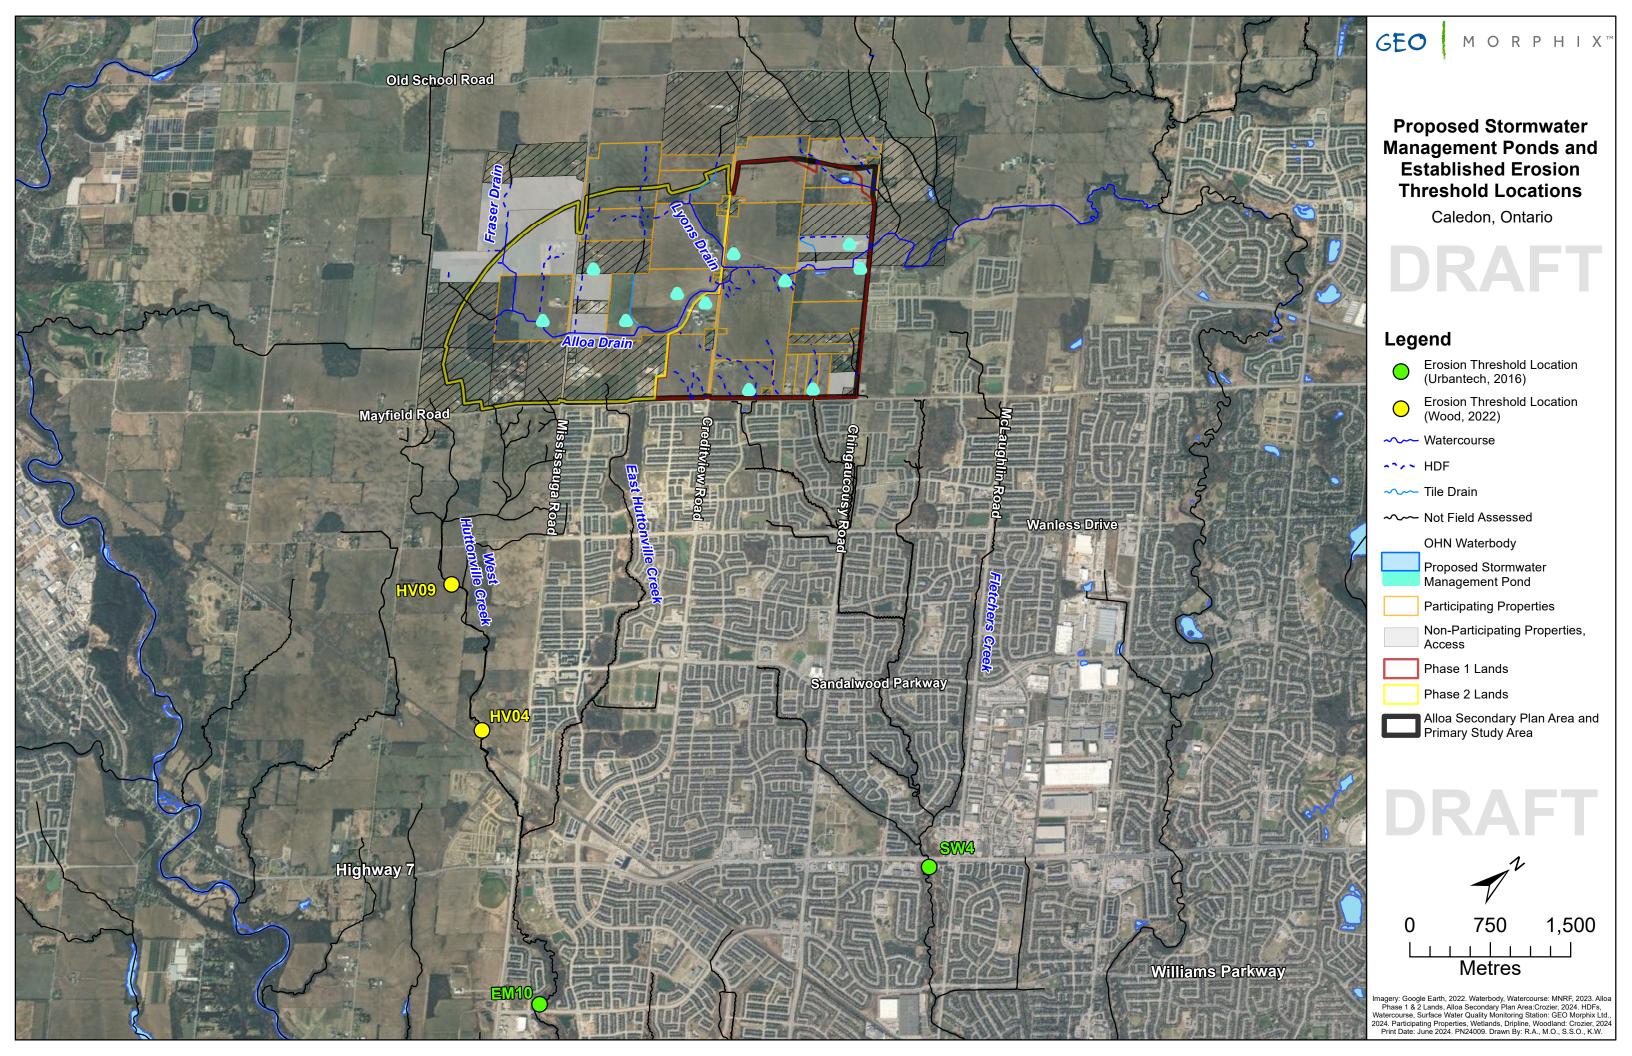


Appendix I: Conceptual Natural Corridor Designs



DATA SHARING TERMS AND CONDITIONS

THE RECIPIENT OF THIS DRAWING AGREES TO THE FOLLOWING TERMS AND CONDITIONS:

- THIS DRAWING IS THE PROPERTY OF GEO MORPHIX LTD.
- MODIFICATION OF THE DRAWING OR DRAWING COMPONENTS IS PROHIBITED WITHOUT CONSENT OF GEO MORPHIX LTD.
- DRAWING INFORMATION WILL NOT BE PROVIDED TO ANY THIRD PARTY
 WITHOUT THE CONSENT OF GEO MORPHIX LTD.
- THIS DRAWING IS APPLICABLE ONLY TO THE SUBJECT PROJECT, AS DENOTED BY THE PROJECT NUMBER "PN" CODE IN THE DESIGN FILE NAME

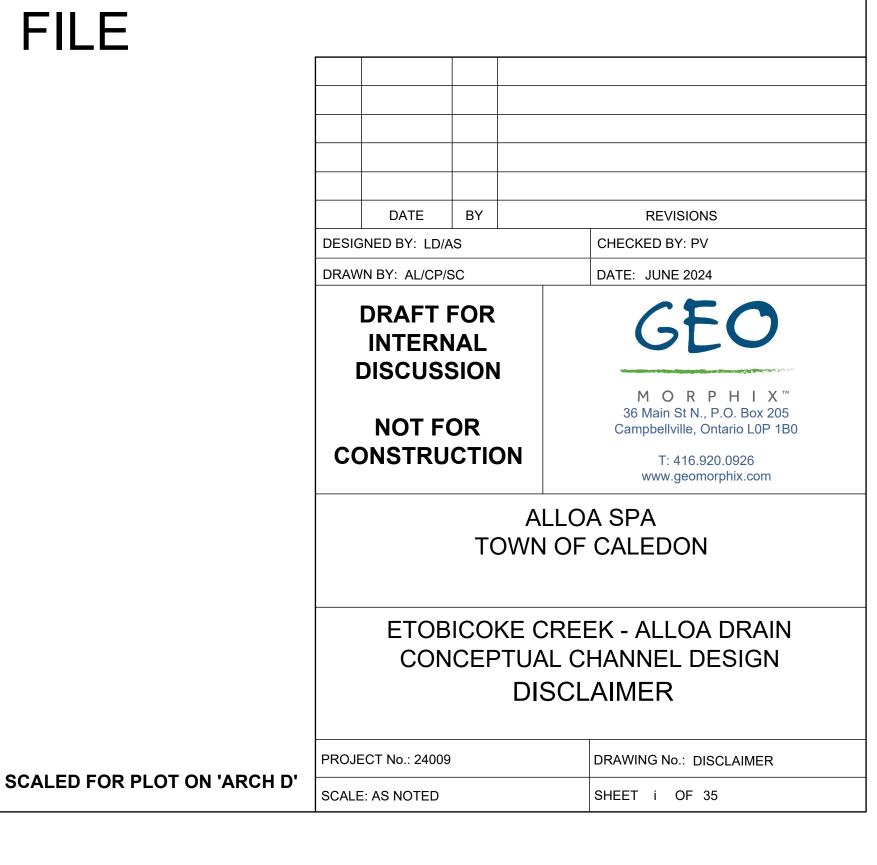



OVERVIEW OF NATURAL CHANNEL DESIGN LOCATIONS

DRAWING SHEET LIST INDEX

SHEET#	SHEET NAME	DETAILS	SHEET#	CHEET NAME	<u> </u>
OTTLL I #		+		SHEET NAME	
1	COVER	COVER SHEET, DRAWINGS INDEX	18	GEO-17	
NATURAL CH	IANNEL DESIGN DRAV	VINGS	19	GEO-18	
2	GEO-1	ETOBICOKE CREEK ALLOA DRAIN - PLAN	20	GEO-19	
3	GEO-2	ETOBICOKE CREEK ALLOA DRAIN - PLAN	21	GEO-20	
4	GEO-3	ETOBICOKE CREEK ALLOA DRAIN - PLAN	22	GEO-21	
5	GEO-4	ETOBICOKE CREEK ALLOA DRAIN - PLAN	23	GEO-22	
6	GEO-5	ETOBICOKE CREEK ALLOA DRAIN - PLAN	24	GEO-23	
7	GEO-6	ETOBICOKE CREEK ALLOA DRAIN - PLAN	25	GEO-24	
8	GEO-7	ETOBICOKE CREEK ALLOA DRAIN - PLAN	26	GEO-25	
9	GEO-8	ETOBICOKE CREEK ALLOA DRAIN - PLAN	27	DET-1	
10	GEO-9	ETOBICOKE CREEK ALLOA DRAIN - PLAN	28	DET-2	
11	GEO-10	ETOBICOKE CREEK ALLOA DRAIN - PLAN	29	DET-3	
12	GEO-11	ETOBICOKE CREEK ALLOA DRAIN - PLAN	30	DET-4	
13	GEO-12	ETOBICOKE CREEK ALLOA DRAIN - PLAN	31	DET-5	
14	GEO-13	ETOBICOKE CREEK ALLOA DRAIN - PLAN	32	DET-6	
15	GEO-14	ETOBICOKE CREEK ALLOA DRAIN - PLAN	33	DET-7	
16	GEO-15	ETOBICOKE CREEK ALLOA DRAIN - PLAN	34	DET-8	
17	GEO-16	ETOBICOKE CREEK ALLOA DRAIN - PLAN	35	DET-9	

SCALED FOR PLOT ON 'ARCH D'

GENERAL NOTES

DESIGN IMPLEMENTATION NOTES

- THE ACCOMPANYING CHANNEL REALIGNMENT TECHNICAL DESIGN BRIEF PREPARED BY GEO MORPHIX LTD. (2024) PROVIDES ADDITIONAL DESIGN DETAILS AND DIRECTION FOR IMPLEMENTATION AND IS TO BE REVIEWED IN CONJUNCTION WITH THIS DRAWING SET. 2. ALL CONTRACT DRAWINGS, SPECIFICATIONS AND APPLICABLE PERMITS MUST BE KEPT ON SITE DURING
- CONSTRUCTION FOR REFERENCE. 3. THE CONTRACTOR MUST NOTIFY THE DESIGNER AND CONTRACT ADMINISTRATOR OF THE INTENT TO
- COMMENCE WORK AT LEAST 48 HOURS IN ADVANCE. 4. THE CONTRACTOR IS RESPONSIBLE FOR ALL UTILITY LOCATES.

CONDITIONS TO SUPPORT CHANNEL REALIGNMENT CONSTRUCTION.

- 5. LAYOUT MUST BE REVIEWED AND APPROVED BY THE DESIGNER / DESIGNER REPRESENTATIVE, DESIGNATED ENGINEER, AND THE CONTRACT ADMINISTRATOR.
- 6. CONSTRUCTION OBSERVATION IS TO BE PERFORMED BY A CERTIFIED FLUVIAL GEOMORPHOLOGIST OR EXPERIENCED ENVIRONMENTAL INSPECTOR UNDER DIRECTION FROM THE DESIGNER. 7. ON-SITE SUPPORT FROM PROJECT ENGINEER (E.G., GEOTECHNICAL, HYDROGEOLOGICAL, AND/OR WATER RESOURCES ENGINEER) REQUIRED TO ASSESS AND ENSURE FAVOURABLE SURFICIAL AND SUBSURFACE
- 8. BE ADVISED THAT THE LOCAL REGULATORY BODY MAY, AT ANY TIME, WITHDRAW THIS PERMISSION, IF, IN THE OPINION OF THE AUTHORITY, THE CONDITIONS OF THE PERMIT ARE NOT BEING COMPLIED WITH. THIS APPROVAL DOES NOT EXEMPT THE PROPERTY OWNER/APPLICANT/AGENT FROM THE PROVISIONS OF ANY OTHER FEDERAL, PROVINCIAL OR MUNICIPAL STATUTES, REGULATIONS OR BY-LAWS, OR ANY RIGHTS UNDER COMMON LAW.

TIMING OF WORKS

- 1. WORKS SHALL BE COMPLETED DURING THE DESIGNATED IN-WATER WORKS WINDOW SET OUT BY MNRF/DFO.
- 2. TREE CLEARING IS TO BE COMPLETED OUTSIDE THE BIRD NESTING SEASON (APRIL 1ST TO AUGUST 1ST) TO COMPLY WITH THE FEDERAL MIGRATORY BIRDS CONVENTION ACT. ANY TREES THAT REQUIRE REMOVAL OUTSIDE OF THIS TIMING WINDOW MUST FIRST BE INSPECTED BY A QUALIFIED BIOLOGIST TO DETERMINE THE PRESENCE OF NESTING BIRDS.

3. THE WEATHER FORECAST SHOULD BE CONTINUALLY MONITORED TO ENSURE THAT WORKS ARE

UNDERTAKEN ONLY DURING FAVOURABLE WEATHER CONDITIONS. 4. COMPLETE THE WORKS WITH MINIMAL AVOIDABLE INTERRUPTIONS ONCE THEY COMMENCE.

SITE AND MATERIAL MANAGEMENT

- 1. ALL CONSTRUCTION EQUIPMENT AND MATERIALS (IMPORTED OR EXCAVATED) MUST BE STORED AT LEAST 30 m AWAY FROM ANY WATERBODY IN A STABLE AREA ABOVE THE ACTIVE FLÓODPLAIN, OR IN A DESIGNATED STAGING/STORAGE AREA.
- 2. IN THE EVENT OF AN UNEXPECTED STORM, ALL UNFIXED ITEMS THAT HAVE THE POTENTIAL TO CAUSE A SPILL OR AN OBSTRUCTION TO FLOW MUST BE MOVED A STABLE AREA ABOVE ACTIVE FLOODPLAIN.
- 3. STOCKPILES MUST BE LOCATED OUTSIDE THE ISOLATED WORK AREAS. 4. STABILIZE, TEMPORARILY OR PERMANENTLY, ANY DISTURBED AREAS AS WORK PROGRESSES, OR SOON AS CONDITIONS ALLOW.
- 5. MINIMIZE THE AREA OF DISTURBANCE TO THE EXTENT POSSIBLE. ALL DISTURBED GROUND LEFT INACTIVE FOR MORE THAN 30 DAYS SHALL BE STABILIZED USING APPROPRIATE EROSION CONTROL MEASURES AND
- AN APPROPRIATE SEED MIX AS NOTED WITHIN THE FINAL APPROVED RESTORATION PLAN. 6. ALL VEGETATION, ADJACENT TO THE WORK AREA, MUST BE PROTECTED AND DELINEATED WITH CONSTRUCTION FENCING OR TREE PROTECTION BARRIERS.
- 7. ALL GRADES IN THE AREA REGULATED BY THE CONSERVATION AUTHORITY MUST BE MAINTAINED OR MATCHED, UNLESS OTHERWISE AUTHORIZED IN THE APPLICABLE PERMIT.
- 8. AN AFTER-HOURS CONTACT NUMBER IS TO BE VISIBLY POSTED ONSITE FOR EMERGENCIES. ALL THE PLANS SHOULD HAVE NAME AND CONTACT INFO OF THE PERSON RESPONSIBLE FOR ESC MEASURES.

EROSION AND SEDIMENT CONTROL

- 1. ALL TEMPORARY EROSION AND SEDIMENT CONTROL MEASURES MUST BE INSTALLED PRIOR TO START OF
- 2. FOLLOWING INSTALLATION OF THE PROPOSED ESC MEASURES, A QUALIFIED AGENT OF THE PROPONENT (E.G. CAN-CISEC CERTIFIED MONITOR) WILL CONDUCT REGULAR SITE VISITS TO MONITOR ALL WORKS, PARTICULARLY THE CONDITION OF THE ESC MEASURES, DEWATERING, AND IN- OR NEAR-WATER WORKS. SHOULD CONCERNS ARISE; THE ENVIRONMENTAL MONITOR WILL CONTACT THE PROPONENT, THE
- CONSERVATION AUTHORITY, AND ANY OTHER APPROPRIATE PARTIES. 3. EROSION AND SEDIMENT CONTROLS MUST BE MAINTAINED DURING CONSTRUCTION, AND ANY REQUIRED REPAIRS OR REPLACEMENTS MUST BE COMPLETED WITHIN 24 HOURS AFTER THEY HAVE BEEN IDENTIFIED
- DURING THE MONITORING. 4. EROSION AND SEDIMENT CONTROLS MAY REQUIRE PERIODIC ADJUSTMENTS TO REFLECT CHANGING SITE CONDITIONS. THE CONTRACTOR WILL BE RESPONSIBLE FOR THESE ADJUSTMENTS TO ENSURE PROPER
- 5. ANY CHANGES TO THE EROSION AND SEDIMENT CONTROL PLAN BEYOND MINOR ADJUSTMENTS MUST BE
- APPROVED BY THE CONTRACT ADMINISTRATOR. 6. ADDITIONAL EROSION AND SEDIMENT CONTROL SUPPLIES MUST BE KEPT ON SITE IN ORDER TO FACILITATE IMMEDIATE REPAIRS AND/OR UPGRADES AS NEEDED.
- 7. ALL TEMPORARY SEDIMENT CONTROLS MUST BE REMOVED AFTER THE CONTRACT ADMINISTRATOR DEEMS THE SITE TO BE STABLE. 8. THE PROJECT PROPONENT OR THEIR REPRESENTATIVE IS ULTIMATELY RESPONSIBLE FOR CONTROLLING
- SEDIMENT AND EROSION WITHIN THE CONSTRUCTION SITE FOR THE TOTAL PERIOD OF THE 9. IF EXCESSIVE SILTATION RESULTS FROM THE CONSTRUCTION ACTIVITIES, THE ONSITE
- SUPERVISOR/INSPECTOR AND/OR THE LOCAL REGULATORY BODY RESERVE THE RIGHT TO REQUEST ADDITIONAL ESC MEASURES WHICH WOULD BE INSTALLED PRIOR TO FURTHER CONSTRUCTION

DELETERIOUS SUBSTANCE CONTROL/SPILL MANAGEMENT

WORK AREA ISOLATION

- 1. PREVENT THE RELEASE OF SEDIMENT, SEDIMENT-LADEN WATER, RAW CONCRETE, CONCRETE LEACHATE OR ANY OTHER DELETERIOUS SUBSTANCES INTO ANY WATERBODY, RAVINE OR STORM SEWER SYSTEM. 2. ENSURE EQUIPMENT AND MACHINERY ARE IN GOOD OPERATING CONDITION (POWER WASHED), FREE OF LEAKS, EXCESS OIL, AND GREASE. 3. NO EQUIPMENT REFUELLING OR SERVICING SHOULD BE UNDERTAKEN WITHIN 30 m OF ANY WATERCOURSE
- 4. A SPILL CONTAINMENT KIT MUST BE READILY ACCESSIBLE ON SITE IN THE EVENT OF A RELEASE OF A
- DELETERIOUS SUBSTANCE TO THE ENVIRONMENT. ONSITE STAFF MUST BE TRAINED IN ITS USE. 5. THE CONTRACT ADMINISTRATOR MUST BE NOTIFIED IMMEDIATELY IN THE EVENT OF A SPILL OF DELETERIOUS SUBSTANCE. ANY SEDIMENT SPILL FROM THE SITE SHOULD BE REPORTED TO MINISTRY OF

ENVIRONMENT (SPILL ACTION CENTER) AT 1-800-268-6060.

- 1. ALL WORK IN ISOLATED WORK AREAS MUST BE COMPLETED IN THE DRY. AN ADEQUATE NUMBER OF PUMPS MUST BE USED FOR UNWATERING.
- 2. CROSSING AN ACTIVE WATERCOURSE OR WETLAND BY EQUIPMENT, VEHICLES, PERSONNEL, ETC. IS NOT PERMITTED UNLESS APPROVED BY THE CONSERVATION AUTHORITY. ALL ACCESS TO WORK SITES SHALL
- BE FROM EITHER SIDES OF THE WATERCOURSE OR WETLAND. 3. THE UNWATERING DISCHARGE LOCATION MUST BE LOCATED AT LEAST 30 M FROM ANY WATERCOURSE OR WETLAND IN AN AREA WITH DENSE VEGETATIVE GROUNDCOVER, AND WHERE THE DISCHARGE CAN
- RETURN TO THE WATERBODY DOWNSTREAM OF THE WORK AREA OVER THE GROUNDCOVER. 4. FISH MUST BE REMOVED FROM THE WORK AREA ONCE ISOLATED. FISH SALVAGE MUST BE COMPLETED BY A QUALIFIED TECHNICIAN WITH A LICENSE FROM THE ONTARIO MINISTRY OF NATURAL RESOURCES AND

	DATE	BY		REVISIONS
DESIG	DESIGNED BY: LD/AS			CHECKED BY: PV
DRAWN BY: AL/CP/SC				DATE: JUNE 2024

DRAFT FOR INTERNAL DISCUSSION


NOT FOR CONSTRUCTION




ALLOA SPA TOWN OF CALEDON

ETOBICOKE CREEK - ALLOA DRAIN CONCEPTUAL CHANNEL DESIGN COVERPAGE

DRAWING No.: COVERPAGE PROJECT No.: 24009 SCALE: AS NOTED SHEET 1 OF 35

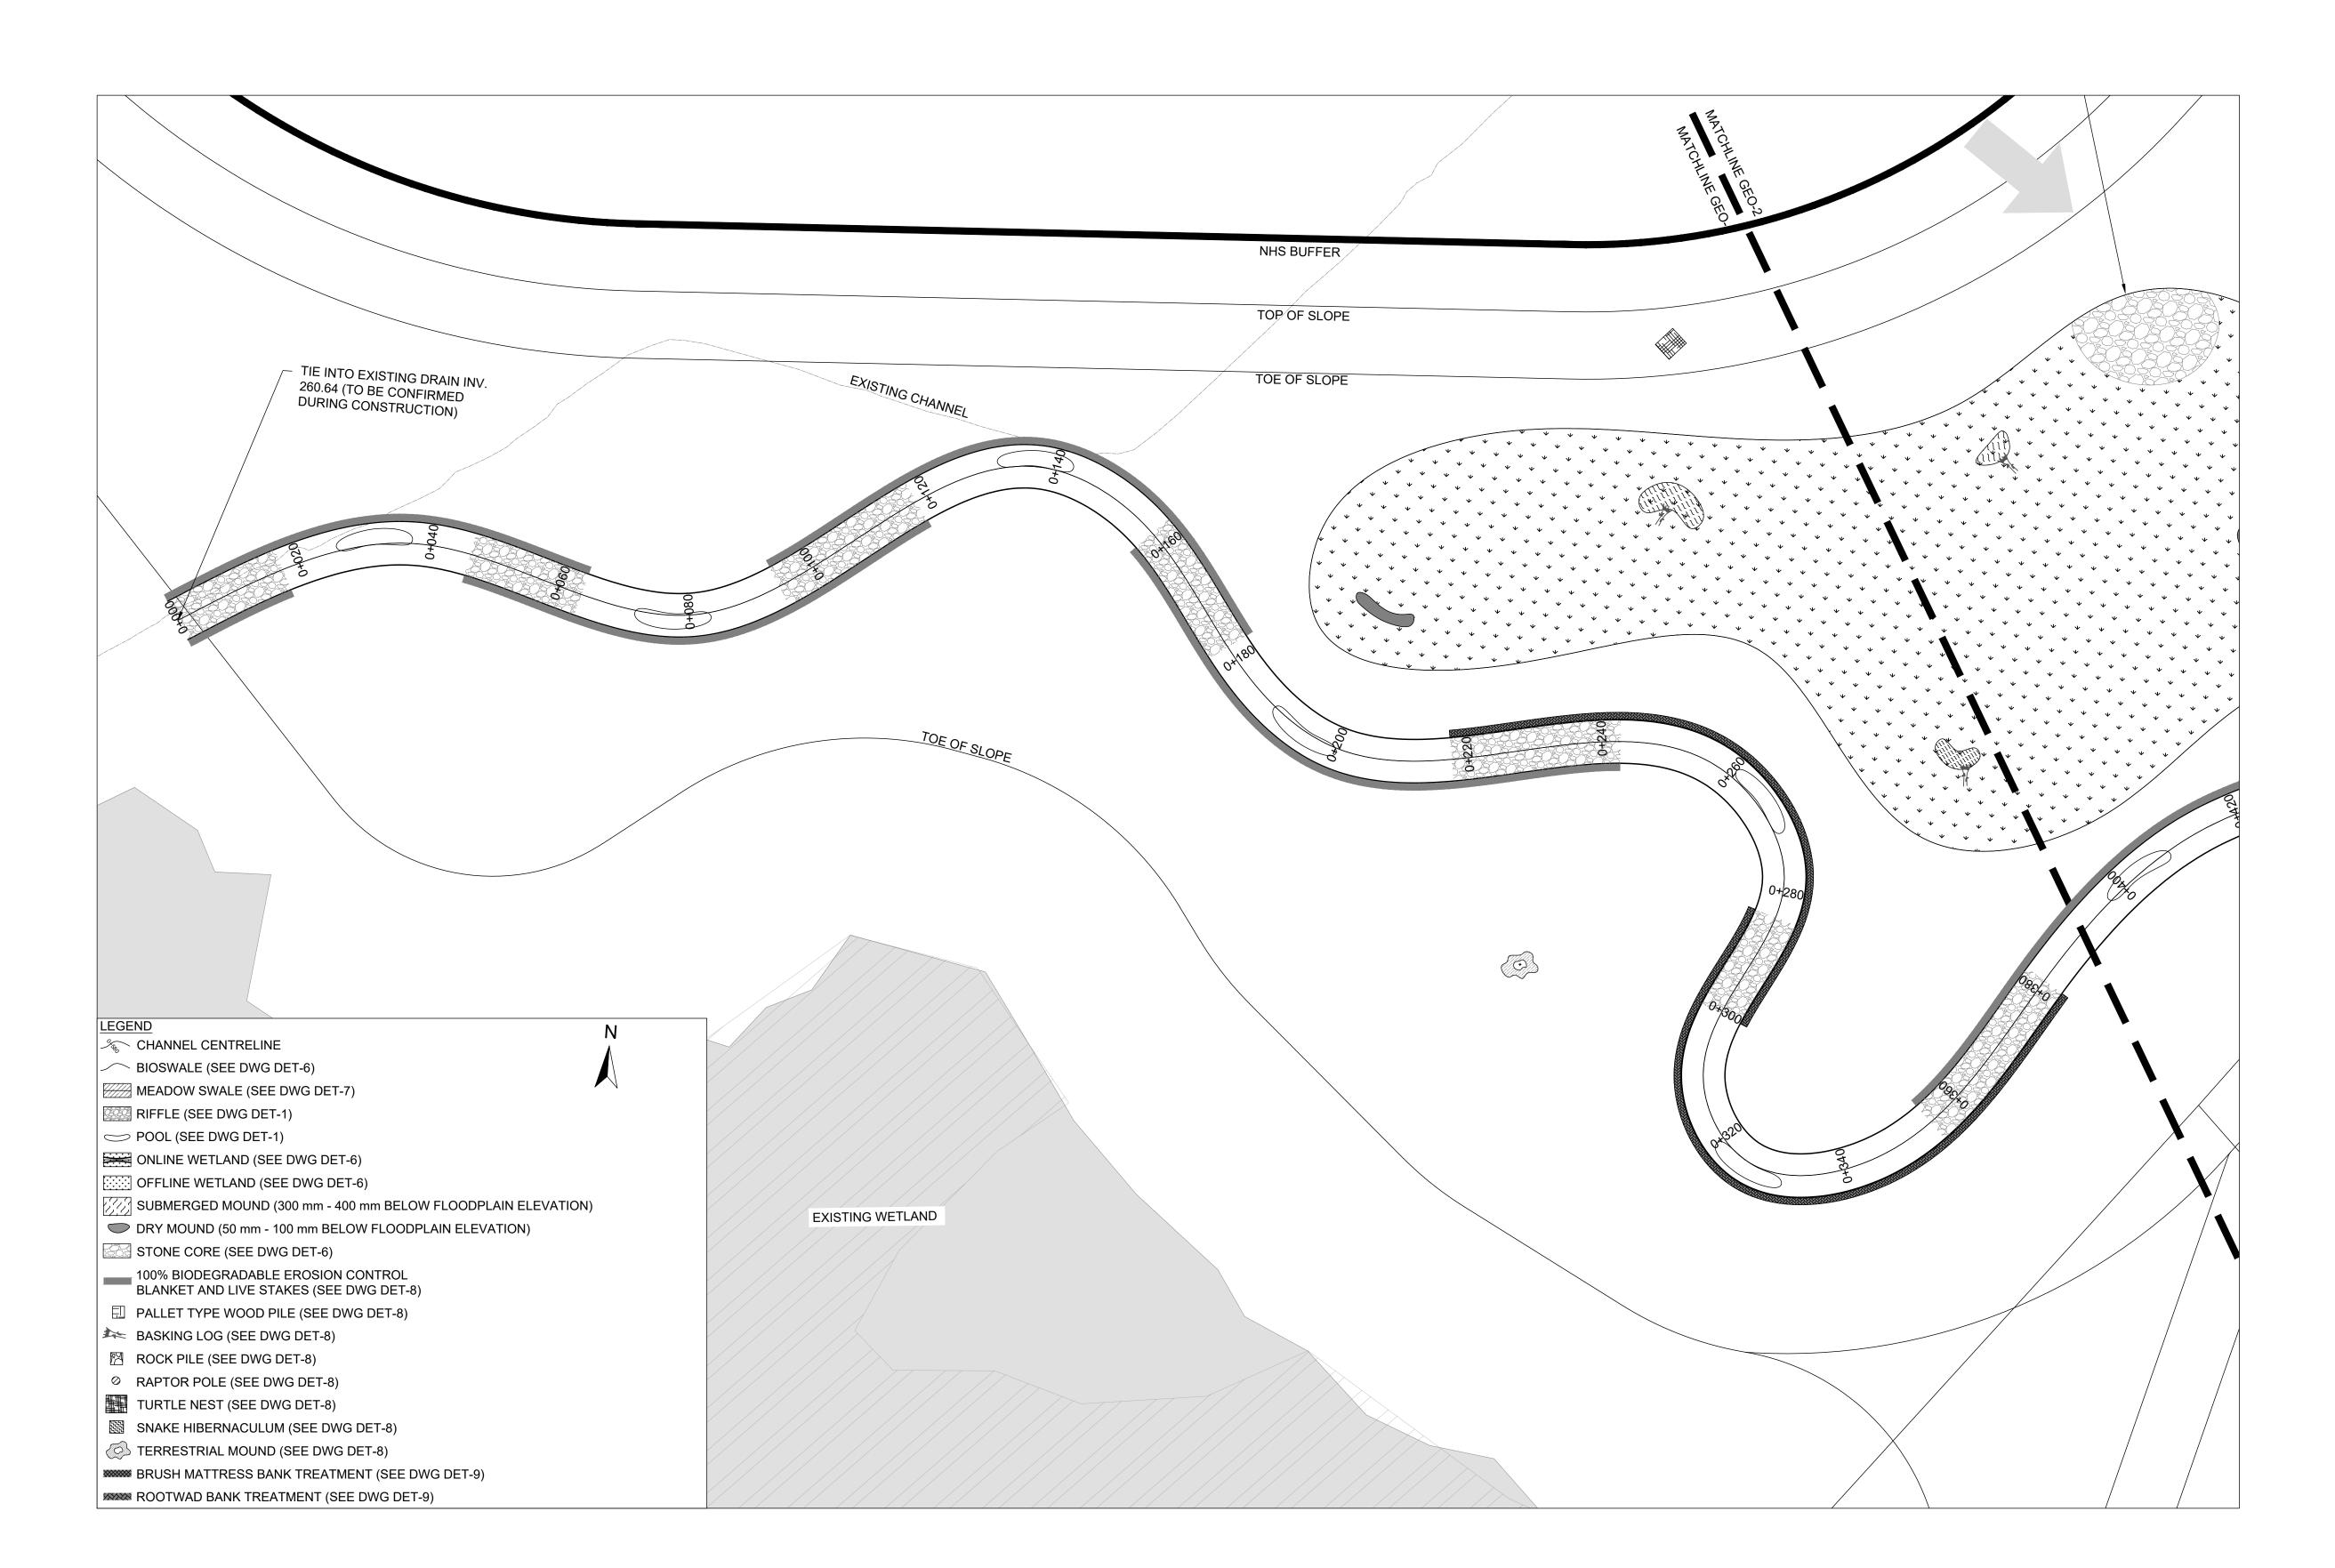

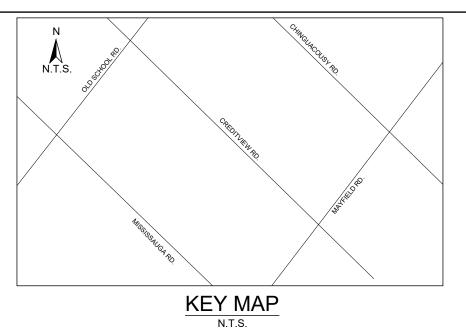

1. THE ACCOMPANYING CHANNEL REALIGNMENT TECHNICAL DESIGN BRIEF PREPARED BY GEO MORPHIX LTD. (2023) PROVIDES ADDITIONAL DESIGN DETAILS AND DIRECTION FOR IMPLEMENTATION AND IS TO BE REVIEWED IN CONJUNCTION WITH THIS DRAWING SET.

2. ALL CONTRACT DRAWINGS, SPECIFICATIONS AND APPLICABLE PERMITS MUST BE KEPT ON SITE DURING

CONSTRUCTION FOR REFERENCE.

3. THE CONTRACTOR MUST NOTIFY THE DESIGNER AND CONTRACT ADMINISTRATOR OF THE INTENT TO COMMENCE WORK AT LEAST 48 HOURS IN ADVANCE.

4. THE CONTRACTOR IS RESPONSIBLE FOR ALL UTILITY LOCATES.
5. LAYOUT MUST BE REVIEWED AND APPROVED BY THE DESIGNER / DESIGNER REPRESENTATIVE, DESIGNATED

ENGINEER, AND THE CONTRACT ADMINISTRATOR. CONSTRUCTION OBSERVATION IS TO BE PERFORMED BY A CERTIFIED FLUVIAL GEOMORPHOLOGIST OR EXPERIENCED ENVIRONMENTAL INSPECTOR UNDER DIRECTION FROM THE DESIGNER.

7. ON-SITE SUPPORT FROM PROJECT ENGINEER (E.G., GEOTECHNICAL, HYDROGEOLOGICAL, AND/OR WATER RESOURCES ENGINEER) REQUIRED TO ASSESS AND ENSURE FAVOURABLE SURFICIAL AND SUBSURFACE CONDITIONS TO SUPPORT CHANNEL REALIGNMENT CONSTRUCTION.

8. BE ADVISED THAT THE LOCAL REGULATORY BODY MAY, AT ANY TIME, WITHDRAW THIS PERMISSION, IF, IN THE OPINION OF THE AUTHORITY. THE CONDITIONS OF THE PERMIT ARE NOT BEING COMPLIED WITH. THIS APPROVAL DOES NOT EXEMPT THE PROPERTY OWNER/APPLICANT/AGENT FROM THE PROVISIONS OF ANY OTHER FEDERAL. PROVINCIAL OR MUNICIPAL STATUTES, REGULATIONS OR BY-LAWS, OR ANY RIGHTS UNDER COMMON LAW.

TIMING OF WORKS

1. WORKS SHALL BE COMPLETED DURING THE DESIGNATED IN-WATER WORKS WINDOW SET OUT BY MNRF/DFO. TREE CLEARING IS TO BE COMPLETED OUTSIDE THE BIRD NESTING SEASON (APRIL 1ST TO AUGUST 1ST) TO COMPLY WITH THE FEDERAL MIGRATORY BIRDS CONVENTION ACT. ANY TREES THAT REQUIRE REMOVAL OUTSIDE OF THIS TIMING WINDOW MUST FIRST BE INSPECTED BY A QUALIFIED BIOLOGIST TO DETERMINE THE PRESENCE OF

3. THE WEATHER FORECAST SHOULD BE CONTINUALLY MONITORED TO ENSURE THAT WORKS ARE UNDERTAKEN

ONLY DURING FAVOURABLE WEATHER CONDITIONS. 4. COMPLETE THE WORKS WITH MINIMAL AVOIDABLE INTERRUPTIONS ONCE THEY COMMENCE.

SITE AND MATERIAL MANAGEMENT

1. ALL CONSTRUCTION EQUIPMENT AND MATERIALS (IMPORTED OR EXCAVATED) MUST BE STORED AT LEAST 30 m

AWAY FROM ANY WATERBODY IN A STABLE AREA ABOVE THE ACTIVE FLOODPLAIN, OR IN A DESIGNATED 2. IN THE EVENT OF AN UNEXPECTED STORM, ALL UNFIXED ITEMS THAT HAVE THE POTENTIAL TO CAUSE A SPILL OR AN OBSTRUCTION TO FLOW MUST BE MOVED A STABLE AREA ABOVE ACTIVE FLOODPLAIN.

3. STOCKPILES MUST BE LOCATED OUTSIDE THE ISOLATED WORK AREAS. 4. STABILIZE, TEMPORARILY OR PERMANENTLY, ANY DISTURBED AREAS AS WORK PROGRESSES, OR SOON AS

CONDITIONS ALLOW. 5. MINIMIZE THE AREA OF DISTURBANCE TO THE EXTENT POSSIBLE. ALL DISTURBED GROUND LEFT INACTIVE FOR MORE THAN 30 DAYS SHALL BE STABILIZED USING APPROPRIATE EROSION CONTROL MEASURES AND AN APPROPRIATE SEED MIX AS NOTED WITHIN THE FINAL APPROVED RESTORATION PLAN.

6. ALL VEGETATION, ADJACENT TO THE WORK AREA, MUST BE PROTECTED AND DELINEATED WITH CONSTRUCTION FFNCING OR TREE PROTECTION BARRIERS. 7. ALL GRADES IN THE AREA REGULATED BY THE CONSERVATION AUTHORITY MUST BE MAINTAINED OR MATCHED,

UNLESS OTHERWISE AUTHORIZED IN THE APPLICABLE PERMIT.

8. AN AFTER-HOURS CONTACT NUMBER IS TO BE VISIBLY POSTED ONSITE FOR EMERGENCIES. ALL THE PLANS SHOULD HAVE NAME AND CONTACT INFO OF THE PERSON RESPONSIBLE FOR ESC MEASURES.

EROSION AND SEDIMENT CONTROL

1. ALL TEMPORARY EROSION AND SEDIMENT CONTROL MEASURES MUST BE INSTALLED PRIOR TO START OF WORKS.
2. FOLLOWING INSTALLATION OF THE PROPOSED ESC MEASURES, A QUALIFIED AGENT OF THE PROPONENT (E.G. CAN-CISEC CERTIFIED MONITOR) WILL CONDUCT REGULAR SITÉ VISITS TO MONITOR ALL WORKS, PARTICULARLY THE CONDITION OF THE ESC MEASURES, DEWATERING, AND IN- OR NEAR-WATER WORKS. SHOULD CONCERNS ARISE, THE ENVIRONMENTAL MONITOR WILL CONTACT THE PROPONENT, THE CONSERVATION AUTHORITY, AND

3. EROSION AND SEDIMENT CONTROLS MUST BE MAINTAINED DURING CONSTRUCTION, AND ANY REQUIRED REPAIRS OR REPLACEMENTS MUST BE COMPLETED WITHIN 24 HOURS AFTER THEY HAVE BEEN IDENTIFIED DURING THE

4. EROSION AND SEDIMENT CONTROLS MAY REQUIRE PERIODIC ADJUSTMENTS TO REFLECT CHANGING SITE CONDITIONS. THE CONTRACTOR WILL BE RESPONSIBLE FOR THESE ADJUSTMENTS TO ENSURE PROPER

ANY CHANGES TO THE EROSION AND SEDIMENT CONTROL PLAN BEYOND MINOR ADJUSTMENTS MUST BE APPROVED BY THE CONTRACT ADMINISTRATOR.

6. ADDITIONAL EROSION AND SEDIMENT CONTROL SUPPLIES MUST BE KEPT ON SITE IN ORDER TO FACILITATE IMMEDIATE REPAIRS AND/OR UPGRADES AS NEEDED. 7. ALL TEMPORARY SEDIMENT CONTROLS MUST BE REMOVED AFTER THE CONTRACT ADMINISTRATOR DEEMS THE

8. THE PROJECT PROPONENT OR THEIR REPRESENTATIVE IS ULTIMATELY RESPONSIBLE FOR CONTROLLING SEDIMENT AND EROSION WITHIN THE CONSTRUCTION SITE FOR THE TOTAL PERIOD OF THE CONSTRUCTION.

9. IF EXCESSIVE SILTATION RESULTS FROM THE CONSTRUCTION ACTIVITIES, THE ONSITE SUPERVISOR/INSPECTOR AND/OR THE LOCAL REGULATORY BODY RESERVE THE RIGHT TO REQUEST ADDITIONAL ESC MEASURES WHICH WOULD BE INSTALLED PRIOR TO FURTHER CONSTRUCTION ACTIVITIES.

DELETERIOUS SUBSTANCE CONTROL/SPILL MANAGEMENT

1. PREVENT THE RELEASE OF SEDIMENT, SEDIMENT-LADEN WATER, RAW CONCRETE, CONCRETE LEACHATE OR ANY OTHER DELETERIOUS SUBSTANCES INTO ANY WATERBODY. RAVINE OR STORM SEWER SYSTEM. 2. ENSURE EQUIPMENT AND MACHINERY ARE IN GOOD OPERATING CONDITION (POWER WASHED), FREE OF LEAKS, EXCESS OIL, AND GREASE.

3. NO EQUIPMENT REFUELLING OR SERVICING SHOULD BE UNDERTAKEN WITHIN 30 m OF ANY WATERCOURSE OR

SURFACE WATER DRAINAGE. 4. A SPILL CONTAINMENT KIT MUST BE READILY ACCESSIBLE ON SITE IN THE EVENT OF A RELEASE OF A DELETERIOUS SUBSTANCE TO THE ENVIRONMENT. ONSITE STAFF MUST BE TRAINED IN ITS USE.

5. THE CONTRACT ADMINISTRATOR MUST BE NOTIFIED IMMEDIATELY IN THE EVENT OF A SPILL OF DELETERIOUS SUBSTANCE. ANY SEDIMENT SPILL FROM THE SITE SHOULD BE REPORTED TO MINISTRY OF ENVIRONMENT (SPILL ACTION CENTER) AT 1-800-268-6060.

WORK AREA ISOLATION

1. ALL WORK IN ISOLATED WORK AREAS MUST BE COMPLETED IN THE DRY. AN ADEQUATE NUMBER OF PUMPS MUST

BE USED FOR UNWATERING.
2. CROSSING AN ACTIVE WATERCOURSE OR WETLAND BY EQUIPMENT, VEHICLES, PERSONNEL, ETC. IS NOT PERMITTED UNLESS APPROVED BY THE CONSERVATION AUTHORITY. ALL ACCESS TO WORK SITES SHALL BE FROM

EITHER SIDES OF THE WATERCOURSE OR WETLAND. 3. THE UNWATERING DISCHARGE LOCATION MUST BE LOCATED AT LEAST 30 M FROM ANY WATERCOURSE OR WETLAND IN AN AREA WITH DENSE VEGETATIVE GROUNDCOVER, AND WHERE THE DISCHARGE CAN RETURN TO

THE WATERBODY DOWNSTREAM OF THE WORK AREA OVER THE GROUNDCOVER. 4. FISH MUST BE REMOVED FROM THE WORK AREA ONCE ISOLATED. FISH SALVAGE MUST BE COMPLETED BY A

QUALIFIED TECHNICIAN WITH A LICENSE FROM THE ONTARIO MINISTRY OF NATURAL RESOURCES AND FORESTRY

DATE BY **REVISIONS**

CHECKED BY: PV DESIGNED BY: LD/AS DRAWN BY: AL/CP/SC DATE: JUNE 2024

DRAFT FOR **INTERNAL** DISCUSSION

 $M O R P H I X^{\mathsf{m}}$

NOT FOR CONSTRUCTION


36 Main St N., P.O. Box 205 Campbellville, Ontario L0P 1B0 T: 416.920.0926 www.geomorphix.com


ALLOA SPA **TOWN OF CALEDON**

ETOBICOKE CREEK - ALLOA DRAIN CONCEPTUAL CHANNEL DESIGN

CHANNEL PLANFORM

PROJECT No.: PN24009 DRAWING No.: GEO-1 SHEET 2 OF 35

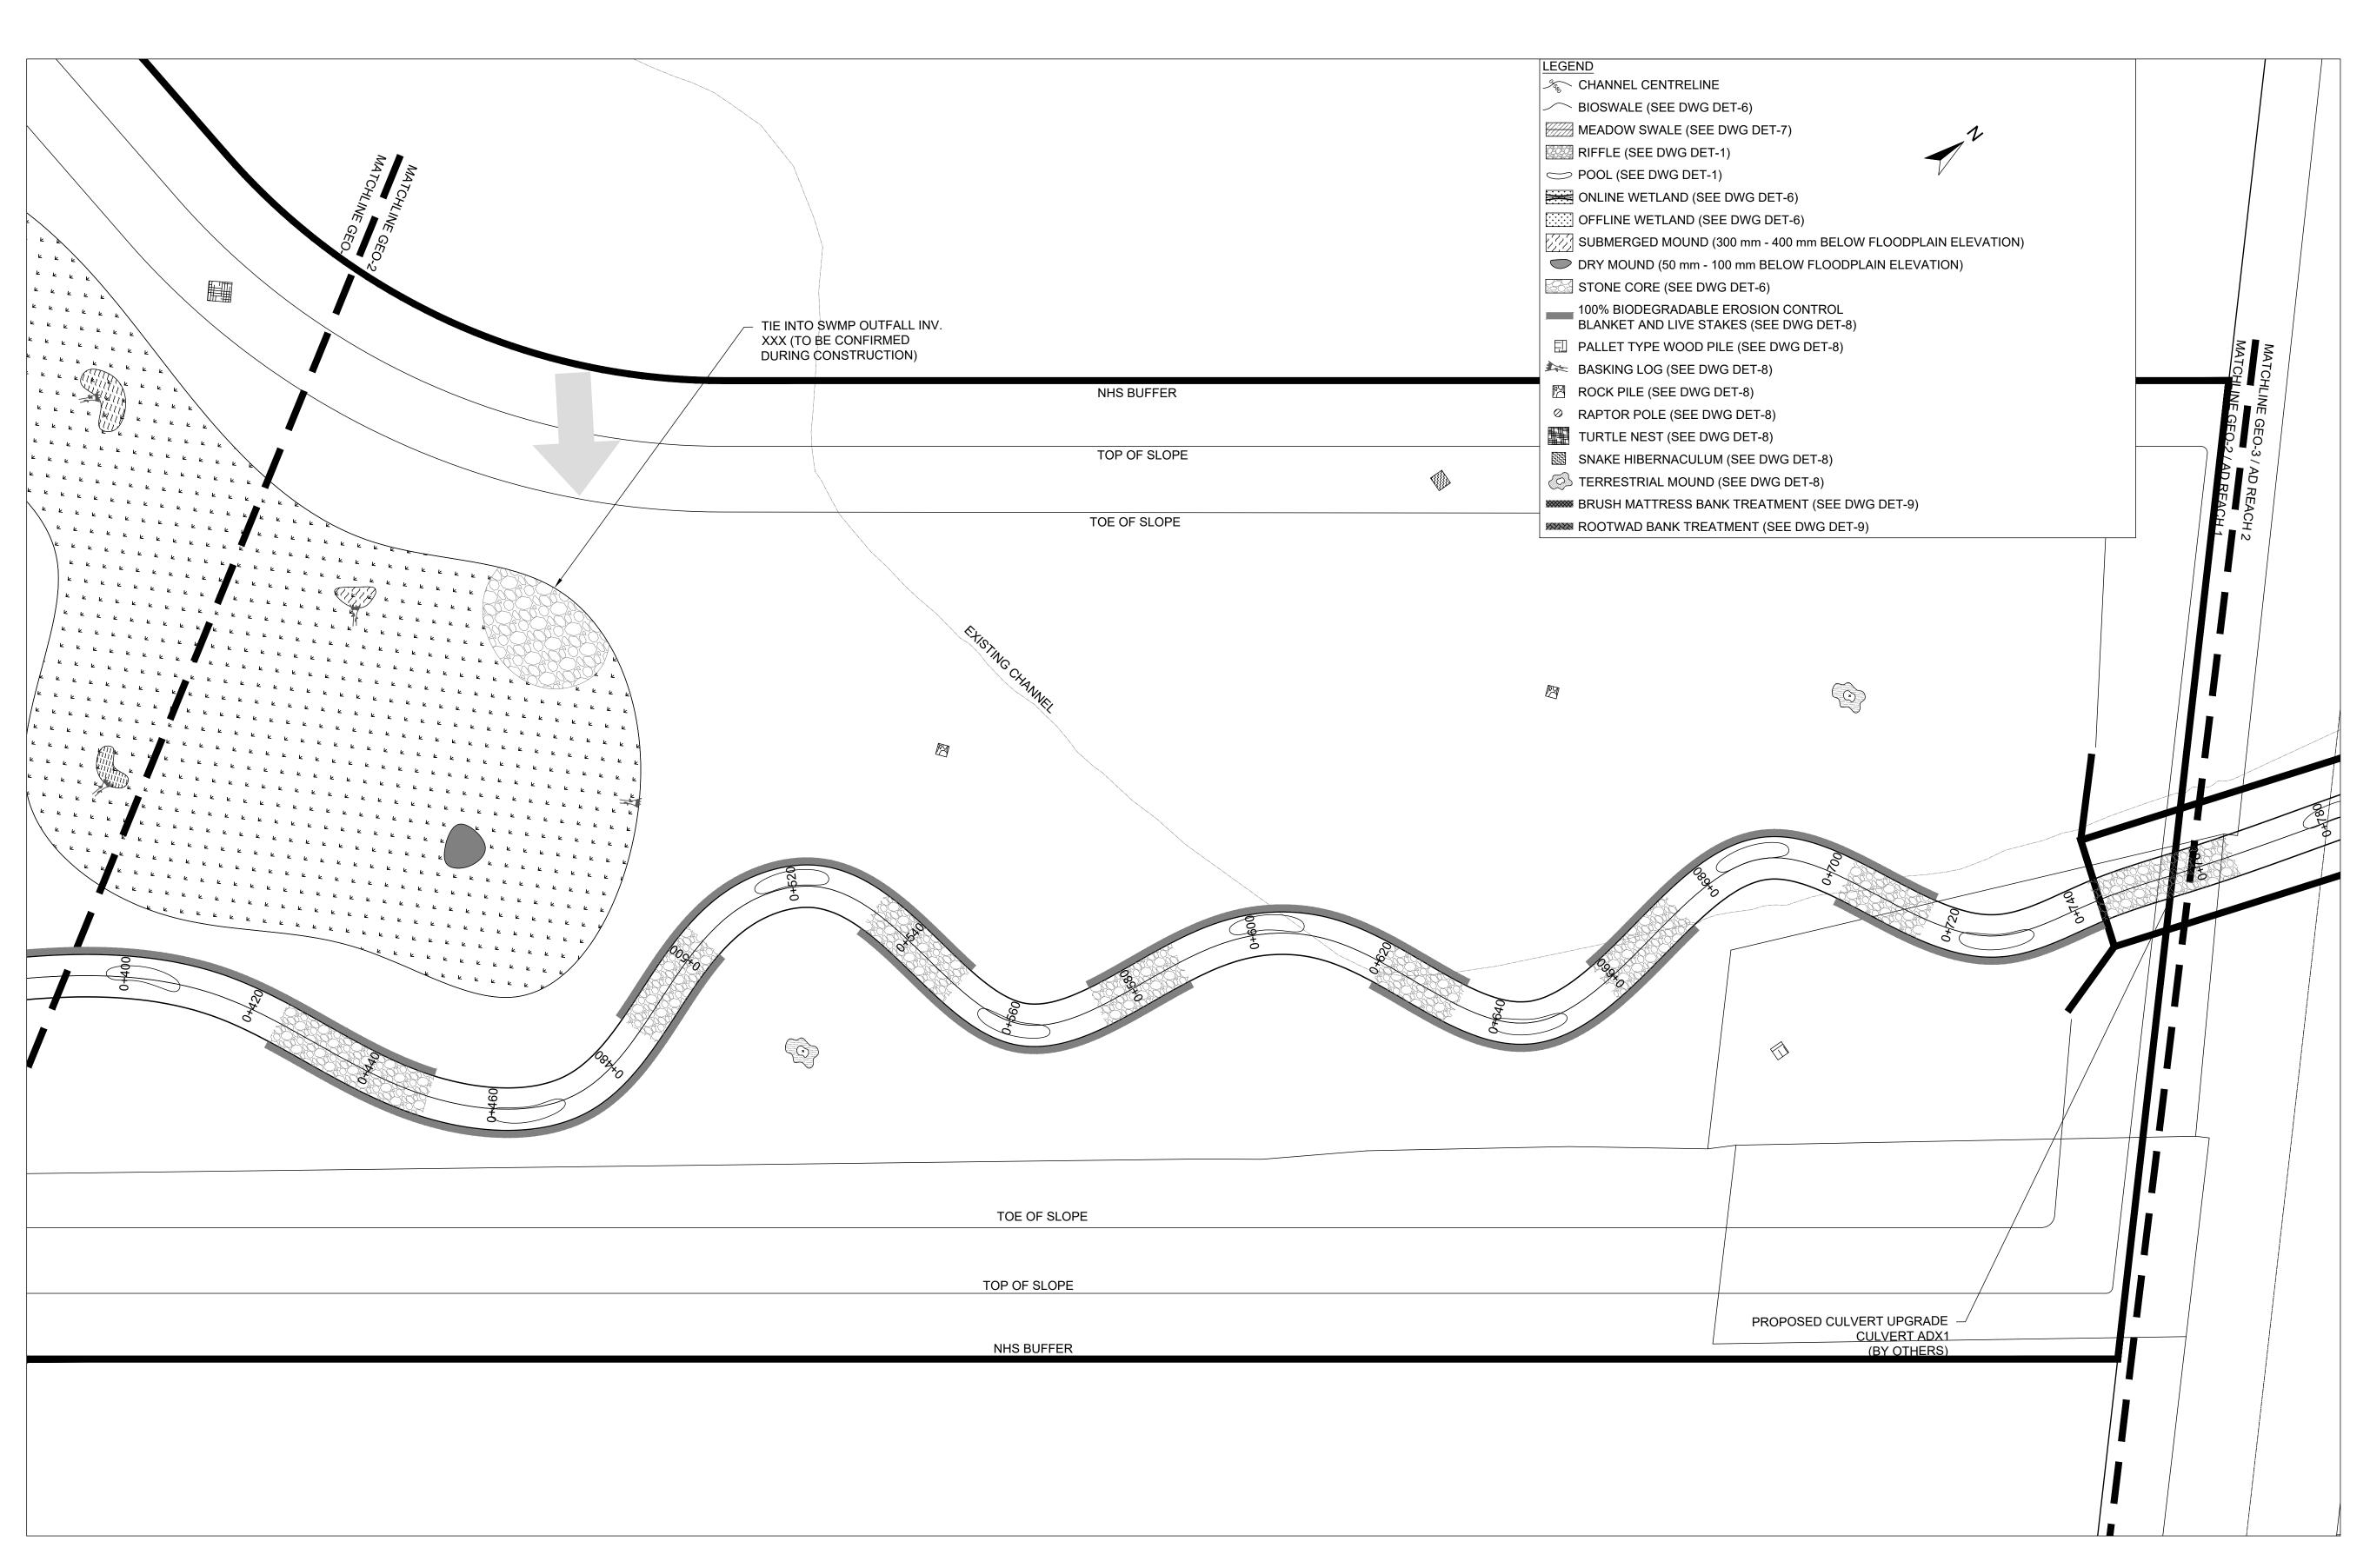

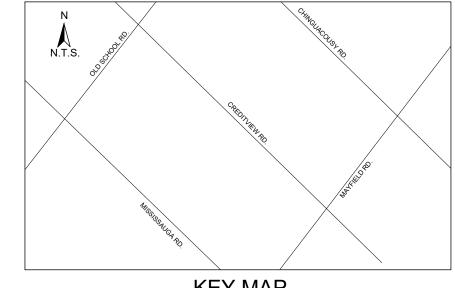

- 1. THE ACCOMPANYING CHANNEL REALIGNMENT TECHNICAL DESIGN BRIEF PREPARED BY GEO MORPHIX LTD. (2023) PROVIDES ADDITIONAL DESIGN DETAILS AND DIRECTION FOR IMPLEMENTATION AND IS TO BE REVIEWED IN
- CONJUNCTION WITH THIS DRAWING SET. 2. ALL CONTRACT DRAWINGS, SPECIFICATIONS AND APPLICABLE PERMITS MUST BE KEPT ON SITE DURING CONSTRUCTION FOR REFERENCE.
- 3. THE CONTRACTOR MUST NOTIFY THE DESIGNER AND CONTRACT ADMINISTRATOR OF THE INTENT TO COMMENCE WORK AT LEAST 48 HOURS IN ADVANCE. 4. THE CONTRACTOR IS RESPONSIBLE FOR ALL UTILITY LOCATES.
- 5. LAYOUT MUST BE REVIEWED AND APPROVED BY THE DESIGNER / DESIGNER REPRESENTATIVE, DESIGNATED
- ENGINEER, AND THE CONTRACT ADMINISTRATOR.
- CONSTRUCTION OBSERVATION IS TO BE PERFORMED BY A CERTIFIED FLUVIAL GEOMORPHOLOGIST OR EXPERIENCED ENVIRONMENTAL INSPECTOR UNDER DIRECTION FROM THE DESIGNER. 7. ON-SITE SUPPORT FROM PROJECT ENGINEER (E.G., GEOTECHNICAL, HYDROGEOLOGICAL, AND/OR WATER
- RESOURCES ENGINEER) REQUIRED TO ASSESS AND ENSURE FAVOURABLE SURFICIAL AND SUBSURFACE CONDITIONS TO SUPPORT CHANNEL REALIGNMENT CONSTRUCTION. 8. BE ADVISED THAT THE LOCAL REGULATORY BODY MAY, AT ANY TIME, WITHDRAW THIS PERMISSION, IF, IN THE
- OPINION OF THE AUTHORITY. THE CONDITIONS OF THE PERMIT ARE NOT BEING COMPLIED WITH. THIS APPROVAL DOES NOT EXEMPT THE PROPERTY OWNER/APPLICANT/AGENT FROM THE PROVISIONS OF ANY OTHER FEDERAL. PROVINCIAL OR MUNICIPAL STATUTES, REGULATIONS OR BY-LAWS, OR ANY RIGHTS UNDER COMMON LAW.

- 1. WORKS SHALL BE COMPLETED DURING THE DESIGNATED IN-WATER WORKS WINDOW SET OUT BY MNRF/DFO. TREE CLEARING IS TO BE COMPLETED OUTSIDE THE BIRD NESTING SEASON (APRIL 1ST TO AUGUST 1ST) TO COMPLY WITH THE FEDERAL MIGRATORY BIRDS CONVENTION ACT. ANY TREES THAT REQUIRE REMOVAL OUTSIDE OF THIS TIMING WINDOW MUST FIRST BE INSPECTED BY A QUALIFIED BIOLOGIST TO DETERMINE THE PRESENCE OF
- 3. THE WEATHER FORECAST SHOULD BE CONTINUALLY MONITORED TO ENSURE THAT WORKS ARE UNDERTAKEN ONLY DURING FAVOURABLE WEATHER CONDITIONS. 4. COMPLETE THE WORKS WITH MINIMAL AVOIDABLE INTERRUPTIONS ONCE THEY COMMENCE.

SITE AND MATERIAL MANAGEMENT

- 1. ALL CONSTRUCTION EQUIPMENT AND MATERIALS (IMPORTED OR EXCAVATED) MUST BE STORED AT LEAST 30 m AWAY FROM ANY WATERBODY IN A STABLE AREA ABOVE THE ACTIVE FLOODPLAIN, OR IN A DESIGNATED
- 2. IN THE EVENT OF AN UNEXPECTED STORM, ALL UNFIXED ITEMS THAT HAVE THE POTENTIAL TO CAUSE A SPILL OR AN OBSTRUCTION TO FLOW MUST BE MOVED A STABLE AREA ABOVE ACTIVE FLOODPLAIN.
- 3. STOCKPILES MUST BE LOCATED OUTSIDE THE ISOLATED WORK AREAS. 4. STABILIZE, TEMPORARILY OR PERMANENTLY, ANY DISTURBED AREAS AS WORK PROGRESSES, OR SOON AS CONDITIONS ALLOW.
- 5. MINIMIZE THE AREA OF DISTURBANCE TO THE EXTENT POSSIBLE. ALL DISTURBED GROUND LEFT INACTIVE FOR MORE THAN 30 DAYS SHALL BE STABILIZED USING APPROPRIATE EROSION CONTROL MEASURES AND AN
- APPROPRIATE SEED MIX AS NOTED WITHIN THE FINAL APPROVED RESTORATION PLAN. 6. ALL VEGETATION, ADJACENT TO THE WORK AREA, MUST BE PROTECTED AND DELINEATED WITH CONSTRUCTION
- FENCING OR TREE PROTECTION BARRIERS. 7. ALL GRADES IN THE AREA REGULATED BY THE CONSERVATION AUTHORITY MUST BE MAINTAINED OR MATCHED,
- UNLESS OTHERWISE AUTHORIZED IN THE APPLICABLE PERMIT.

 8. AN AFTER-HOURS CONTACT NUMBER IS TO BE VISIBLY POSTED ONSITE FOR EMERGENCIES. ALL THE PLANS SHOULD HAVE NAME AND CONTACT INFO OF THE PERSON RESPONSIBLE FOR ESC MEASURES.

EROSION AND SEDIMENT CONTROL

- 1. ALL TEMPORARY EROSION AND SEDIMENT CONTROL MEASURES MUST BE INSTALLED PRIOR TO START OF WORKS. 2. FOLLOWING INSTALLATION OF THE PROPOSED ESC MEASURES. A QUALIFIED AGENT OF THE PROPONENT (E.G. CAN-CISEC CERTIFIED MONITOR) WILL CONDUCT REGULAR SITÉ VISITS TO MONITOR ALL WORKS, PARTICULARLY THE CONDITION OF THE ESC MEASURES, DEWATERING, AND IN- OR NEAR-WATER WORKS. SHOULD CONCERNS ARISE; THE ENVIRONMENTAL MONITOR WILL CONTACT THE PROPONENT, THE CONSERVATION AUTHORITY, AND
- ANY OTHER APPROPRIATE PARTIES. 3. EROSION AND SEDIMENT CONTROLS MUST BE MAINTAINED DURING CONSTRUCTION. AND ANY REQUIRED REPAIRS OR REPLACEMENTS MUST BE COMPLETED WITHIN 24 HOURS AFTER THEY HAVE BEEN IDENTIFIED DURING THE
- 4. EROSION AND SEDIMENT CONTROLS MAY REQUIRE PERIODIC ADJUSTMENTS TO REFLECT CHANGING SITE CONDITIONS. THE CONTRACTOR WILL BE RESPONSIBLE FOR THESE ADJUSTMENTS TO ENSURE PROPER
- 5. ANY CHANGES TO THE EROSION AND SEDIMENT CONTROL PLAN BEYOND MINOR ADJUSTMENTS MUST BE APPROVED BY THE CONTRACT ADMINISTRATOR.
- 6. ADDITIONAL EROSION AND SEDIMENT CONTROL SUPPLIES MUST BE KEPT ON SITE IN ORDER TO FACILITATE IMMEDIATE REPAIRS AND/OR UPGRADES AS NEEDED.
- ALL TEMPORARY SEDIMENT CONTROLS MUST BE REMOVED AFTER THE CONTRACT ADMINISTRATOR DEEMS THE 8. THE PROJECT PROPONENT OR THEIR REPRESENTATIVE IS ULTIMATELY RESPONSIBLE FOR CONTROLLING
- SEDIMENT AND EROSION WITHIN THE CONSTRUCTION SITE FOR THE TOTAL PERIOD OF THE CONSTRUCTION. 9. IF EXCESSIVE SILTATION RESULTS FROM THE CONSTRUCTION ACTIVITIES, THE ONSITE SUPERVISOR/INSPECTOR AND/OR THE LOCAL REGULATORY BODY RESERVE THE RIGHT TO REQUEST ADDITIONAL ESC MEASURES WHICH WOULD BE INSTALLED PRIOR TO FURTHER CONSTRUCTION ACTIVITIES.

DELETERIOUS SUBSTANCE CONTROL/SPILL MANAGEMENT

- 1. PREVENT THE RELEASE OF SEDIMENT, SEDIMENT-LADEN WATER, RAW CONCRETE, CONCRETE LEACHATE OR ANY OTHER DELETERIOUS SUBSTANCES INTO ANY WATERBODY, RAVINE OR STORM SEWER SYSTEM. 2. ENSURE EQUIPMENT AND MACHINERY ARE IN GOOD OPERATING CONDITION (POWER WASHED), FREE OF LEAKS, EXCESS OIL, AND GREASE.

 3. NO EQUIPMENT REFUELLING OR SERVICING SHOULD BE UNDERTAKEN WITHIN 30 m OF ANY WATERCOURSE OR
- SURFACE WATER DRAINAGE. 4. A SPILL CONTAINMENT KIT MUST BE READILY ACCESSIBLE ON SITE IN THE EVENT OF A RELEASE OF A DELETERIOUS SUBSTANCE TO THE ENVIRONMENT. ONSITE STAFF MUST BE TRAINED IN ITS USE.
- 5. THE CONTRACT ADMINISTRATOR MUST BE NOTIFIED IMMEDIATELY IN THE EVENT OF A SPILL OF DELETERIOUS SUBSTANCE. ANY SEDIMENT SPILL FROM THE SITE SHOULD BE REPORTED TO MINISTRY OF ENVIRONMENT (SPILL ACTION CENTER) AT 1-800-268-6060.

WORK AREA ISOLATION

- 1. ALL WORK IN ISOLATED WORK AREAS MUST BE COMPLETED IN THE DRY. AN ADEQUATE NUMBER OF PUMPS MUST BE USED FOR UNWATERING.
 2. CROSSING AN ACTIVE WATERCOURSE OR WETLAND BY EQUIPMENT, VEHICLES, PERSONNEL, ETC. IS NOT
- PERMITTED UNLESS APPROVED BY THE CONSERVATION AUTHORITY. ALL ACCESS TO WORK SITES SHALL BE FROM EITHER SIDES OF THE WATERCOURSE OR WETLAND.
- 3. THE UNWATERING DISCHARGE LOCATION MUST BE LOCATED AT LEAST 30 M FROM ANY WATERCOURSE OR WETLAND IN AN AREA WITH DENSE VEGETATIVE GROUNDCOVER, AND WHERE THE DISCHARGE CAN RETURN TO THE WATERBODY DOWNSTREAM OF THE WORK AREA OVER THE GROUNDCOVER
- 4. FISH MUST BE REMOVED FROM THE WORK AREA ONCE ISOLATED. FISH SALVAGE MUST BE COMPLETED BY A QUALIFIED TECHNICIAN WITH A LICENSE FROM THE ONTARIO MINISTRY OF NATURAL RESOURCES AND FORESTRY

DATE BY **REVISIONS** CHECKED BY: PV

DESIGNED BY: LD/AS DRAWN BY: AL/CP/SC DATE: JUNE 2024

DRAFT FOR **INTERNAL** DISCUSSION

 $M O R P H I X^{\mathsf{m}}$ 36 Main St N., P.O. Box 205

NOT FOR CONSTRUCTION


Campbellville, Ontario L0P 1B0 T: 416.920.0926 www.geomorphix.com


ALLOA SPA TOWN OF CALEDON

ETOBICOKE CREEK - ALLOA DRAIN CONCEPTUAL CHANNEL DESIGN CHANNEL PLANFORM

DRAWING No.: GEO-2 PROJECT No.: PN24009 SHEET 3 OF 35

PLANFORM 1:500

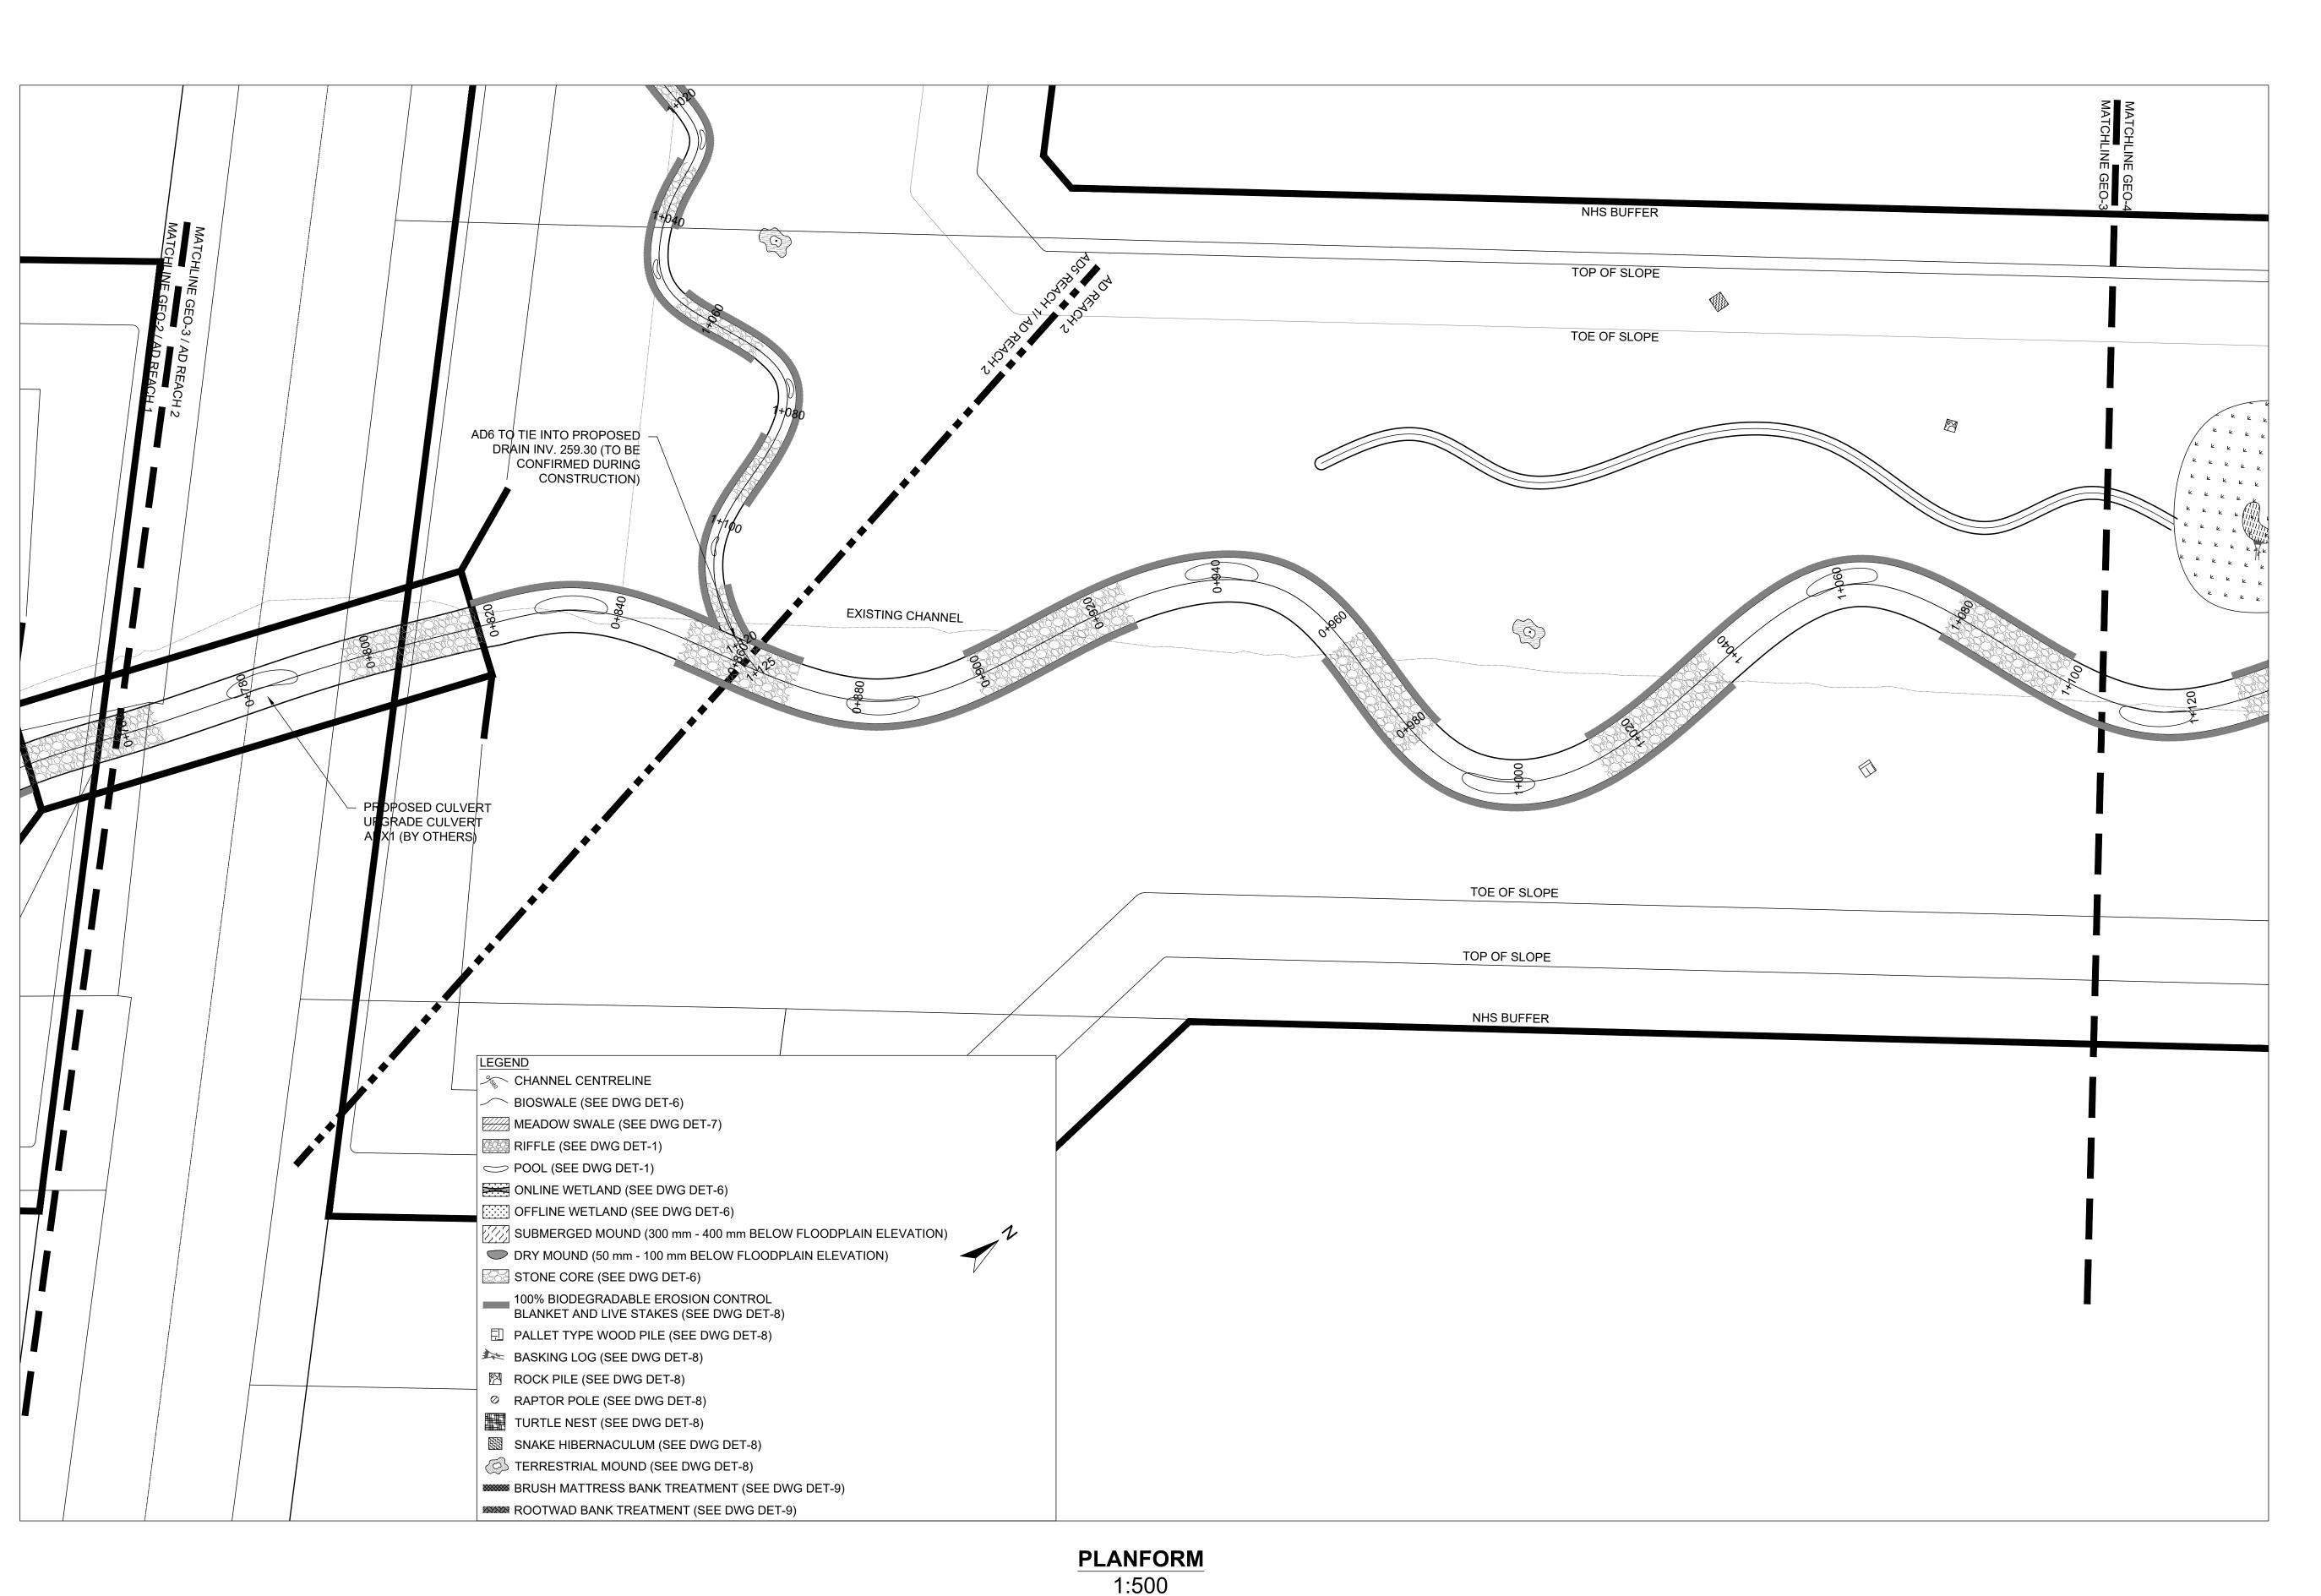

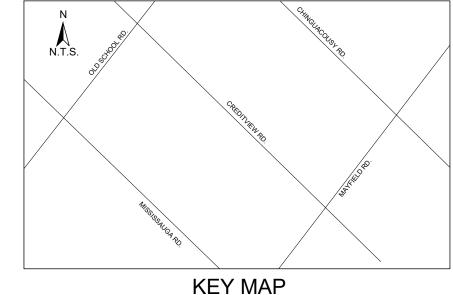

CONJUNCTION WITH THIS DRAWING SET.

- 1. THE ACCOMPANYING CHANNEL REALIGNMENT TECHNICAL DESIGN BRIEF PREPARED BY GEO MORPHIX LTD. (2023) PROVIDES ADDITIONAL DESIGN DETAILS AND DIRECTION FOR IMPLEMENTATION AND IS TO BE REVIEWED IN
- 2. ALL CONTRACT DRAWINGS, SPECIFICATIONS AND APPLICABLE PERMITS MUST BE KEPT ON SITE DURING CONSTRUCTION FOR REFERENCE.

 3. THE CONTRACTOR MUST NOTIFY THE DESIGNER AND CONTRACT ADMINISTRATOR OF THE INTENT TO COMMENCE
- WORK AT LEAST 48 HOURS IN ADVANCE.
- 4. THE CONTRACTOR IS RESPONSIBLE FOR ALL UTILITY LOCATES.
 5. LAYOUT MUST BE REVIEWED AND APPROVED BY THE DESIGNER / DESIGNER REPRESENTATIVE, DESIGNATED ENGINEER, AND THE CONTRACT ADMINISTRATOR.
- CONSTRUCTION OBSERVATION IS TO BE PERFORMED BY A CERTIFIED FLUVIAL GEOMORPHOLOGIST OR EXPERIENCED ENVIRONMENTAL INSPECTOR UNDER DIRECTION FROM THE DESIGNER.
- 7. ON-SITE SUPPORT FROM PROJECT ENGINEER (E.G., GEOTECHNICAL, HYDROGEOLOGICAL, AND/OR WATER
- RESOURCES ENGINEER) REQUIRED TO ASSESS AND ENSURE FAVOURABLE SURFICIAL AND SUBSURFACE CONDITIONS TO SUPPORT CHANNEL REALIGNMENT CONSTRUCTION. 8. BE ADVISED THAT THE LOCAL REGULATORY BODY MAY, AT ANY TIME, WITHDRAW THIS PERMISSION, IF, IN THE
- OPINION OF THE AUTHORITY. THE CONDITIONS OF THE PERMIT ARE NOT BEING COMPLIED WITH. THIS APPROVAL DOES NOT EXEMPT THE PROPERTY OWNER/APPLICANT/AGENT FROM THE PROVISIONS OF ANY OTHER FEDERAL, PROVINCIAL OR MUNICIPAL STATUTES, REGULATIONS OR BY-LAWS, OR ANY RIGHTS UNDER COMMON LAW.

- 1. WORKS SHALL BE COMPLETED DURING THE DESIGNATED IN-WATER WORKS WINDOW SET OUT BY MNRF/DFO. TREE CLEARING IS TO BE COMPLETED OUTSIDE THE BIRD NESTING SEASON (APRIL 1ST TO AUGUST 1ST) TO COMPLY WITH THE FEDERAL MIGRATORY BIRDS CONVENTION ACT. ANY TREES THAT REQUIRE REMOVAL OUTSIDE OF THIS TIMING WINDOW MUST FIRST BE INSPECTED BY A QUALIFIED BIOLOGIST TO DETERMINE THE PRESENCE OF
- 3. THE WEATHER FORECAST SHOULD BE CONTINUALLY MONITORED TO ENSURE THAT WORKS ARE UNDERTAKEN
- ONLY DURING FAVOURABLE WEATHER CONDITIONS. 4. COMPLETE THE WORKS WITH MINIMAL AVOIDABLE INTERRUPTIONS ONCE THEY COMMENCE.

SITE AND MATERIAL MANAGEMENT

- 1. ALL CONSTRUCTION EQUIPMENT AND MATERIALS (IMPORTED OR EXCAVATED) MUST BE STORED AT LEAST 30 m AWAY FROM ANY WATERBODY IN A STABLE AREA ABOVE THE ACTIVE FLOODPLAIN, OR IN A DESIGNATED
- 2. IN THE EVENT OF AN UNEXPECTED STORM, ALL UNFIXED ITEMS THAT HAVE THE POTENTIAL TO CAUSE A SPILL OR AN OBSTRUCTION TO FLOW MUST BE MOVED A STABLE AREA ABOVE ACTIVE FLOODPLAIN.
- 3. STOCKPILES MUST BE LOCATED OUTSIDE THE ISOLATED WORK AREAS.
- 4. STABILIZE, TEMPORARILY OR PERMANENTLY, ANY DISTURBED AREAS AS WORK PROGRESSES, OR SOON AS CONDITIONS ALLOW. 5. MINIMIZE THE AREA OF DISTURBANCE TO THE EXTENT POSSIBLE. ALL DISTURBED GROUND LEFT INACTIVE FOR
- MORE THAN 30 DAYS SHALL BE STABILIZED USING APPROPRIATE EROSION CONTROL MEASURES AND AN APPROPRIATE SEED MIX AS NOTED WITHIN THE FINAL APPROVED RESTORATION PLAN.
- 6. ALL VEGETATION, ADJACENT TO THE WORK AREA, MUST BE PROTECTED AND DELINEATED WITH CONSTRUCTION FENCING OR TREE PROTECTION BARRIERS.
- 7. ALL GRADES IN THE AREA REGULATED BY THE CONSERVATION AUTHORITY MUST BE MAINTAINED OR MATCHED,
- UNLESS OTHERWISE AUTHORIZED IN THE APPLICABLE PERMIT.

 8. AN AFTER-HOURS CONTACT NUMBER IS TO BE VISIBLY POSTED ONSITE FOR EMERGENCIES. ALL THE PLANS SHOULD HAVE NAME AND CONTACT INFO OF THE PERSON RESPONSIBLE FOR ESC MEASURES.

EROSION AND SEDIMENT CONTROL

- 1. ALL TEMPORARY EROSION AND SEDIMENT CONTROL MEASURES MUST BE INSTALLED PRIOR TO START OF WORKS.
 2. FOLLOWING INSTALLATION OF THE PROPOSED ESC MEASURES, A QUALIFIED AGENT OF THE PROPONENT (E.G. CAN-CISEC CERTIFIED MONITOR) WILL CONDUCT REGULAR SITÉ VISITS TO MONITOR ALL WORKS, PARTICULARLY THE CONDITION OF THE ESC MEASURES, DEWATERING, AND IN- OR NEAR-WATER WORKS. SHOULD CONCERNS ARISE; THE ENVIRONMENTAL MONITOR WILL CONTACT THE PROPONENT, THE CONSERVATION AUTHORITY, AND
- 3. EROSION AND SEDIMENT CONTROLS MUST BE MAINTAINED DURING CONSTRUCTION, AND ANY REQUIRED REPAIRS OR REPLACEMENTS MUST BE COMPLETED WITHIN 24 HOURS AFTER THEY HAVE BEEN IDENTIFIED DURING THE
- 4. EROSION AND SEDIMENT CONTROLS MAY REQUIRE PERIODIC ADJUSTMENTS TO REFLECT CHANGING SITE CONDITIONS. THE CONTRACTOR WILL BE RESPONSIBLE FOR THESE ADJUSTMENTS TO ENSURE PROPER
- 5. ANY CHANGES TO THE EROSION AND SEDIMENT CONTROL PLAN BEYOND MINOR ADJUSTMENTS MUST BE
- APPROVED BY THE CONTRACT ADMINISTRATOR. 6. ADDITIONAL EROSION AND SEDIMENT CONTROL SUPPLIES MUST BE KEPT ON SITE IN ORDER TO FACILITATE
- IMMEDIATE REPAIRS AND/OR UPGRADES AS NEEDED. 7. ALL TEMPORARY SEDIMENT CONTROLS MUST BE REMOVED AFTER THE CONTRACT ADMINISTRATOR DEEMS THE
- 8. THE PROJECT PROPONENT OR THEIR REPRESENTATIVE IS ULTIMATELY RESPONSIBLE FOR CONTROLLING SEDIMENT AND EROSION WITHIN THE CONSTRUCTION SITE FOR THE TOTAL PERIOD OF THE CONSTRUCTION. 9. IF EXCESSIVE SILTATION RESULTS FROM THE CONSTRUCTION ACTIVITIES, THE ONSITE SUPERVISOR/INSPECTOR
- AND/OR THE LOCAL REGULATORY BODY RESERVE THE RIGHT TO REQUEST ADDITIONAL ESC MEASURES WHICH WOULD BE INSTALLED PRIOR TO FURTHER CONSTRUCTION ACTIVITIES.

DELETERIOUS SUBSTANCE CONTROL/SPILL MANAGEMENT

- 1. PREVENT THE RELEASE OF SEDIMENT, SEDIMENT-LADEN WATER, RAW CONCRETE, CONCRETE LEACHATE OR ANY OTHER DELETERIOUS SUBSTANCES INTO ANY WATERBODY, RAVINE OR STORM SEWER SYSTEM. 2. ENSURE EQUIPMENT AND MACHINERY ARE IN GOOD OPERATING CONDITION (POWER WASHED), FREE OF LEAKS, EXCESS OIL, AND GREASE.

 3. NO EQUIPMENT REFUELLING OR SERVICING SHOULD BE UNDERTAKEN WITHIN 30 m OF ANY WATERCOURSE OR
- SURFACE WATER DRAINAGE. A SPILL CONTAINMENT KIT MUST BE READILY ACCESSIBLE ON SITE IN THE EVENT OF A RELEASE OF A
 DELETERIOUS SUBSTANCE TO THE ENVIRONMENT. ONSITE STAFF MUST BE TRAINED IN ITS USE.
- 5. THE CONTRACT ADMINISTRATOR MUST BE NOTIFIED IMMEDIATELY IN THE EVENT OF A SPILL OF DELETERIOUS
- SUBSTANCE. ANY SEDIMENT SPILL FROM THE SITE SHOULD BE REPORTED TO MINISTRY OF ENVIRONMENT (SPILL ACTION CENTER) AT 1-800-268-6060.

WORK AREA ISOLATION

- 1. ALL WORK IN ISOLATED WORK AREAS MUST BE COMPLETED IN THE DRY. AN ADEQUATE NUMBER OF PUMPS MUST BE USED FOR UNWATERING.

 CROSSING AN ACTIVE WATERCOURSE OR WETLAND BY EQUIPMENT, VEHICLES, PERSONNEL, ETC. IS NOT
- PERMITTED UNLESS APPROVED BY THE CONSERVATION AUTHORITY. ALL ACCESS TO WORK SITES SHALL BE FROM EITHER SIDES OF THE WATERCOURSE OR WETLAND.
- 3. THE UNWATERING DISCHARGE LOCATION MUST BE LOCATED AT LEAST 30 M FROM ANY WATERCOURSE OR WETLAND IN AN AREA WITH DENSE VEGETATIVE GROUNDCOVER, AND WHERE THE DISCHARGE CAN RETURN TO THE WATERBODY DOWNSTREAM OF THE WORK AREA OVER THE GROUNDCOVER.
- 4. FISH MUST BE REMOVED FROM THE WORK AREA ONCE ISOLATED. FISH SALVAGE MUST BE COMPLETED BY A QUALIFIED TECHNICIAN WITH A LICENSE FROM THE ONTARIO MINISTRY OF NATURAL RESOURCES AND FORESTRY

DATE BY REVISIONS

CHECKED BY: PV DESIGNED BY: LD/AS DRAWN BY: AL/CP/SC DATE: JUNE 2024

DRAFT FOR INTERNAL DISCUSSION


 $M O R P H I X^{\mathsf{m}}$ 36 Main St N., P.O. Box 205


NOT FOR CONSTRUCTION Campbellville, Ontario L0P 1B0 T: 416.920.0926 www.geomorphix.com

ALLOA SPA TOWN OF CALEDON

ETOBICOKE CREEK - ALLOA DRAIN CONCEPTUAL CHANNEL DESIGN CHANNEL PLANFORM

PROJECT No.: PN24009 DRAWING No.: GEO-3 SCALE: AS NOTED SHEET 4 OF 35

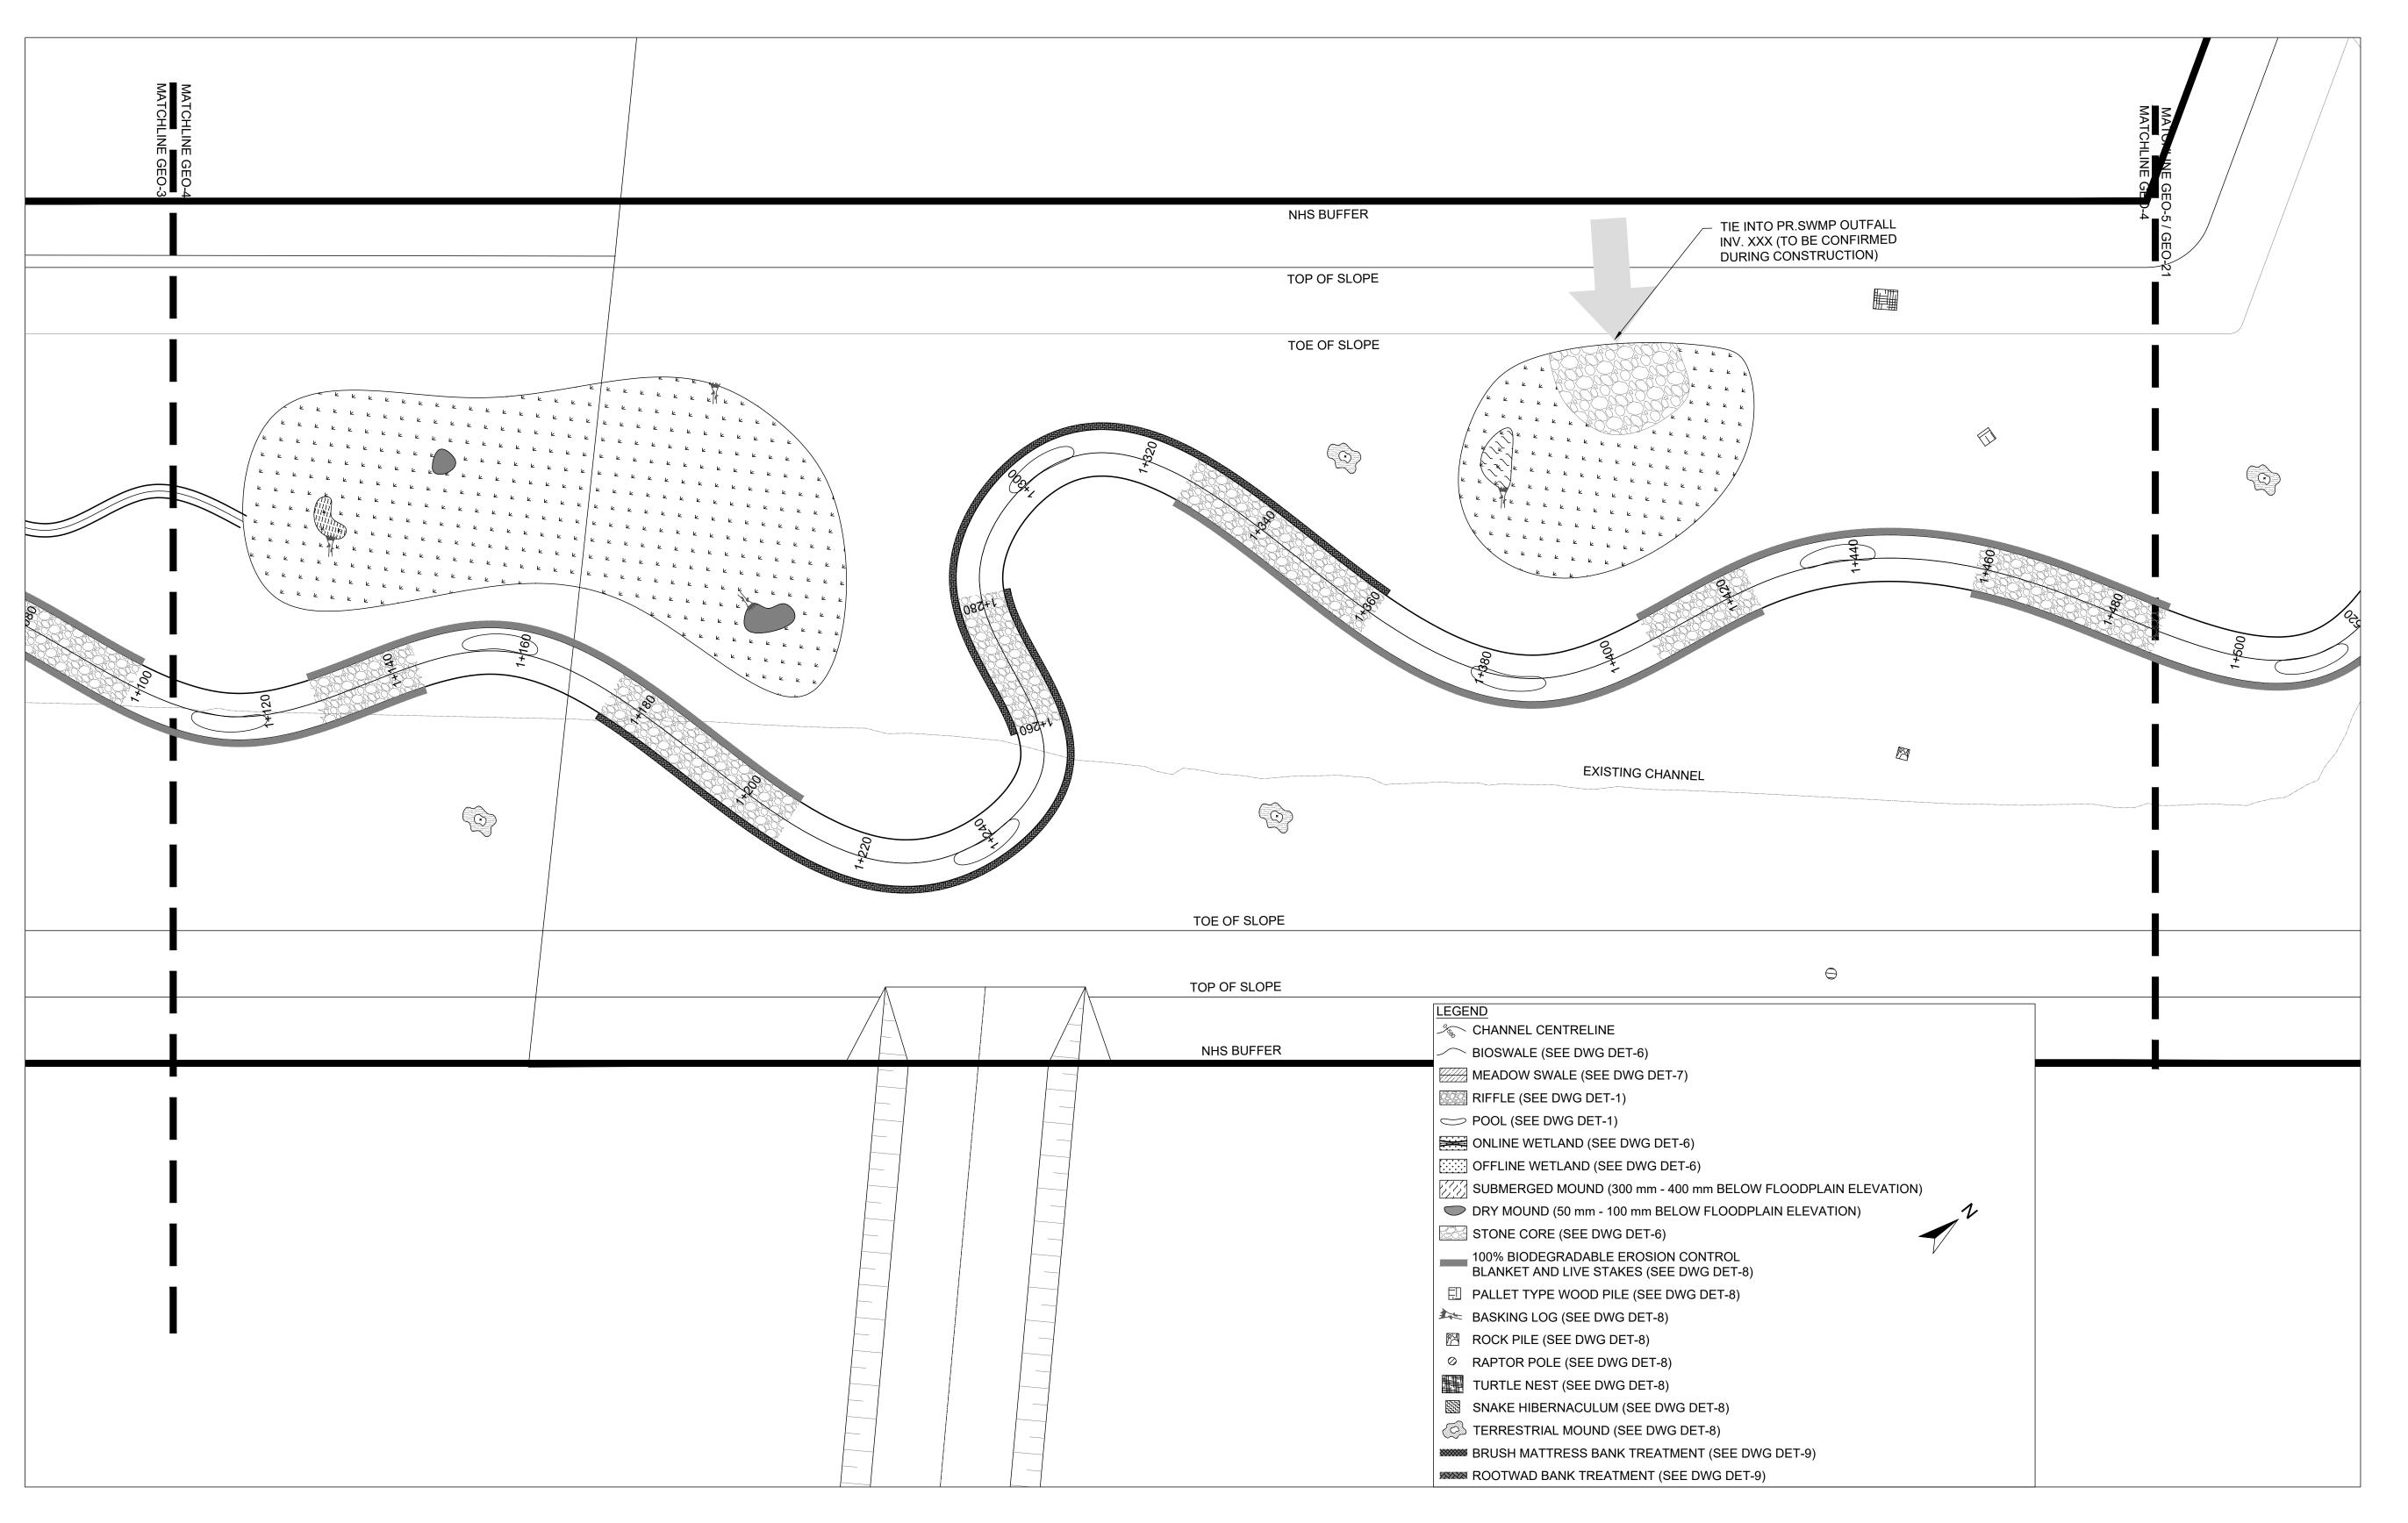

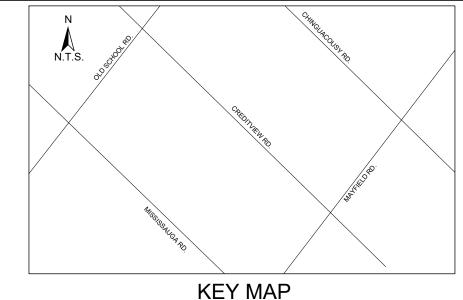

- 1. THE ACCOMPANYING CHANNEL REALIGNMENT TECHNICAL DESIGN BRIEF PREPARED BY GEO MORPHIX LTD. (2023) PROVIDES ADDITIONAL DESIGN DETAILS AND DIRECTION FOR IMPLEMENTATION AND IS TO BE REVIEWED IN
- CONJUNCTION WITH THIS DRAWING SET. 2. ALL CONTRACT DRAWINGS, SPECIFICATIONS AND APPLICABLE PERMITS MUST BE KEPT ON SITE DURING CONSTRUCTION FOR REFERENCE.

 3. THE CONTRACTOR MUST NOTIFY THE DESIGNER AND CONTRACT ADMINISTRATOR OF THE INTENT TO COMMENCE
- WORK AT LEAST 48 HOURS IN ADVANCE. 4. THE CONTRACTOR IS RESPONSIBLE FOR ALL UTILITY LOCATES.
- 5. LAYOUT MUST BE REVIEWED AND APPROVED BY THE DESIGNER / DESIGNER REPRESENTATIVE, DESIGNATED ENGINEER, AND THE CONTRACT ADMINISTRATOR.
- CONSTRUCTION OBSERVATION IS TO BE PERFORMED BY A CERTIFIED FLUVIAL GEOMORPHOLOGIST OR EXPERIENCED ENVIRONMENTAL INSPECTOR UNDER DIRECTION FROM THE DESIGNER.
- 7. ON-SITE SUPPORT FROM PROJECT ENGINEER (E.G., GEOTECHNICAL, HYDROGEOLOGICAL, AND/OR WATER RESOURCES ENGINEER) REQUIRED TO ASSESS AND ENSURE FAVOURABLE SURFICIAL AND SUBSURFACE
- CONDITIONS TO SUPPORT CHANNEL REALIGNMENT CONSTRUCTION. 8. BE ADVISED THAT THE LOCAL REGULATORY BODY MAY, AT ANY TIME, WITHDRAW THIS PERMISSION, IF, IN THE OPINION OF THE AUTHORITY. THE CONDITIONS OF THE PERMIT ARE NOT BEING COMPLIED WITH. THIS APPROVAL DOES NOT EXEMPT THE PROPERTY OWNER/APPLICANT/AGENT FROM THE PROVISIONS OF ANY OTHER FEDERAL,

- 1. WORKS SHALL BE COMPLETED DURING THE DESIGNATED IN-WATER WORKS WINDOW SET OUT BY MNRF/DFO. TREE CLEARING IS TO BE COMPLETED OUTSIDE THE BIRD NESTING SEASON (APRIL 1ST TO AUGUST 1ST) TO COMPLY WITH THE FEDERAL MIGRATORY BIRDS CONVENTION ACT. ANY TREES THAT REQUIRE REMOVAL OUTSIDE
- OF THIS TIMING WINDOW MUST FIRST BE INSPECTED BY A QUALIFIED BIOLOGIST TO DETERMINE THE PRESENCE OF

PROVINCIAL OR MUNICIPAL STATUTES, REGULATIONS OR BY-LAWS, OR ANY RIGHTS UNDER COMMON LAW.

3. THE WEATHER FORECAST SHOULD BE CONTINUALLY MONITORED TO ENSURE THAT WORKS ARE UNDERTAKEN ONLY DURING FAVOURABLE WEATHER CONDITIONS 4. COMPLETE THE WORKS WITH MINIMAL AVOIDABLE INTERRUPTIONS ONCE THEY COMMENCE.

SITE AND MATERIAL MANAGEMENT

- 1. ALL CONSTRUCTION EQUIPMENT AND MATERIALS (IMPORTED OR EXCAVATED) MUST BE STORED AT LEAST 30 m
- AWAY FROM ANY WATERBODY IN A STABLE AREA ABOVE THE ACTIVE FLOODPLAIN, OR IN A DESIGNATED
- 2. IN THE EVENT OF AN UNEXPECTED STORM, ALL UNFIXED ITEMS THAT HAVE THE POTENTIAL TO CAUSE A SPILL OR AN OBSTRUCTION TO FLOW MUST BE MOVED A STABLE AREA ABOVE ACTIVE FLOODPLAIN. 3. STOCKPILES MUST BE LOCATED OUTSIDE THE ISOLATED WORK AREAS.
- 4. STABILIZE, TEMPORARILY OR PERMANENTLY, ANY DISTURBED AREAS AS WORK PROGRESSES, OR SOON AS CONDITIONS ALLOW.
- 5. MINIMIZE THE AREA OF DISTURBANCE TO THE EXTENT POSSIBLE. ALL DISTURBED GROUND LEFT INACTIVE FOR
- MORE THAN 30 DAYS SHALL BE STABILIZED USING APPROPRIATE EROSION CONTROL MEASURES AND AN APPROPRIATE SEED MIX AS NOTED WITHIN THE FINAL APPROVED RESTORATION PLAN.
- 6. ALL VEGETATION, ADJACENT TO THE WORK AREA, MUST BE PROTECTED AND DELINEATED WITH CONSTRUCTION FENCING OR TREE PROTECTION BARRIERS. 7. ALL GRADES IN THE AREA REGULATED BY THE CONSERVATION AUTHORITY MUST BE MAINTAINED OR MATCHED,
- UNLESS OTHERWISE AUTHORIZED IN THE APPLICABLE PERMIT.

 8. AN AFTER-HOURS CONTACT NUMBER IS TO BE VISIBLY POSTED ONSITE FOR EMERGENCIES. ALL THE PLANS
- SHOULD HAVE NAME AND CONTACT INFO OF THE PERSON RESPONSIBLE FOR ESC MEASURES.

EROSION AND SEDIMENT CONTROL

- 1. ALL TEMPORARY EROSION AND SEDIMENT CONTROL MEASURES MUST BE INSTALLED PRIOR TO START OF WORKS. 2. FOLLOWING INSTALLATION OF THE PROPOSED ESC MEASURES, A QUALIFIED AGENT OF THE PROPONENT (E.G. CAN-CISEC CERTIFIED MONITOR) WILL CONDUCT REGULAR SITÉ VISITS TO MONITOR ALL WORKS, PARTICULARLY THE CONDITION OF THE ESC MEASURES, DEWATERING, AND IN- OR NEAR-WATER WORKS. SHOULD CONCERNS ARISE; THE ENVIRONMENTAL MONITOR WILL CONTACT THE PROPONENT, THE CONSERVATION AUTHORITY, AND
- 3. EROSION AND SEDIMENT CONTROLS MUST BE MAINTAINED DURING CONSTRUCTION, AND ANY REQUIRED REPAIRS OR REPLACEMENTS MUST BE COMPLETED WITHIN 24 HOURS AFTER THEY HAVE BEEN IDENTIFIED DURING THE
- 4. EROSION AND SEDIMENT CONTROLS MAY REQUIRE PERIODIC ADJUSTMENTS TO REFLECT CHANGING SITE CONDITIONS. THE CONTRACTOR WILL BE RESPONSIBLE FOR THESE ADJUSTMENTS TO ENSURE PROPER
- 5. ANY CHANGES TO THE EROSION AND SEDIMENT CONTROL PLAN BEYOND MINOR ADJUSTMENTS MUST BE APPROVED BY THE CONTRACT ADMINISTRATOR.
- 6. ADDITIONAL EROSION AND SEDIMENT CONTROL SUPPLIES MUST BE KEPT ON SITE IN ORDER TO FACILITATE IMMEDIATE REPAIRS AND/OR LIPGRADES AS NEEDED
- 7. ALL TEMPORARY SEDIMENT CONTROLS MUST BE REMOVED AFTER THE CONTRACT ADMINISTRATOR DEEMS THE 8. THE PROJECT PROPONENT OR THEIR REPRESENTATIVE IS ULTIMATELY RESPONSIBLE FOR CONTROLLING
- SEDIMENT AND EROSION WITHIN THE CONSTRUCTION SITE FOR THE TOTAL PERIOD OF THE CONSTRUCTION. 9. IF EXCESSIVE SILTATION RESULTS FROM THE CONSTRUCTION ACTIVITIES, THE ONSITE SUPERVISOR/INSPECTOR
- AND/OR THE LOCAL REGULATORY BODY RESERVE THE RIGHT TO REQUEST ADDITIONAL ESC MEASURES WHICH WOULD BE INSTALLED PRIOR TO FURTHER CONSTRUCTION ACTIVITIES.

DELETERIOUS SUBSTANCE CONTROL/SPILL MANAGEMENT

- 1. PREVENT THE RELEASE OF SEDIMENT, SEDIMENT-LADEN WATER, RAW CONCRETE, CONCRETE LEACHATE OR ANY OTHER DELETERIOUS SUBSTANCES INTO ANY WATERBODY. RAVINE OR STORM SEWER SYSTEM. 2. ENSURE EQUIPMENT AND MACHINERY ARE IN GOOD OPERATING CONDITION (POWER WASHED), FREE OF LEAKS, EXCESS OIL, AND GREASE 3. NO EQUIPMENT REFUELLING OR SERVICING SHOULD BE UNDERTAKEN WITHIN 30 m OF ANY WATERCOURSE OR
- SURFACE WATER DRAINAGE. 4. A SPILL CONTAINMENT KIT MUST BE READILY ACCESSIBLE ON SITE IN THE EVENT OF A RELEASE OF A
- DELETERIOUS SUBSTANCE TO THE ENVIRONMENT. ONSITE STAFF MUST BE TRAINED IN ITS USE. 5. THE CONTRACT ADMINISTRATOR MUST BE NOTIFIED IMMEDIATELY IN THE EVENT OF A SPILL OF DELETERIOUS
- SUBSTANCE. ANY SEDIMENT SPILL FROM THE SITE SHOULD BE REPORTED TO MINISTRY OF ENVIRONMENT (SPILL ACTION CENTER) AT 1-800-268-6060.

WORK AREA ISOLATION

- 1. ALL WORK IN ISOLATED WORK AREAS MUST BE COMPLETED IN THE DRY. AN ADEQUATE NUMBER OF PUMPS MUST BE USED FOR UNWATERING.
 2. CROSSING AN ACTIVE WATERCOURSE OR WETLAND BY EQUIPMENT, VEHICLES, PERSONNEL, ETC. IS NOT
- PERMITTED UNLESS APPROVED BY THE CONSERVATION AUTHORITY. ALL ACCESS TO WORK SITES SHALL BE FROM EITHER SIDES OF THE WATERCOURSE OR WETLAND.
- 3. THE UNWATERING DISCHARGE LOCATION MUST BE LOCATED AT LEAST 30 M FROM ANY WATERCOURSE OR WETLAND IN AN AREA WITH DENSE VEGETATIVE GROUNDCOVER, AND WHERE THE DISCHARGE CAN RETURN TO THE WATERBODY DOWNSTREAM OF THE WORK AREA OVER THE GROUNDCOVER
- 4. FISH MUST BE REMOVED FROM THE WORK AREA ONCE ISOLATED. FISH SALVAGE MUST BE COMPLETED BY A QUALIFIED TECHNICIAN WITH A LICENSE FROM THE ONTARIO MINISTRY OF NATURAL RESOURCES AND FORESTRY

DATE BY REVISIONS CHECKED BY: PV DESIGNED BY: LD/AS

DRAWN BY: AL/CP/SC DRAFT FOR

DATE: JUNE 2024

NOT FOR CONSTRUCTION

INTERNAL

DISCUSSION


 $M O R P H I X^{\mathsf{m}}$ 36 Main St N., P.O. Box 205 Campbellville, Ontario L0P 1B0 T: 416.920.0926


www.geomorphix.com **ALLOA SPA**

TOWN OF CALEDON

ETOBICOKE CREEK - ALLOA DRAIN CONCEPTUAL CHANNEL DESIGN CHANNEL PLANFORM

DRAWING No.: GEO-4 PROJECT No.: PN24009 SCALED FOR PLOT ON 'ARCH D' | SCALE: AS NOTED SHEET 5 OF 35

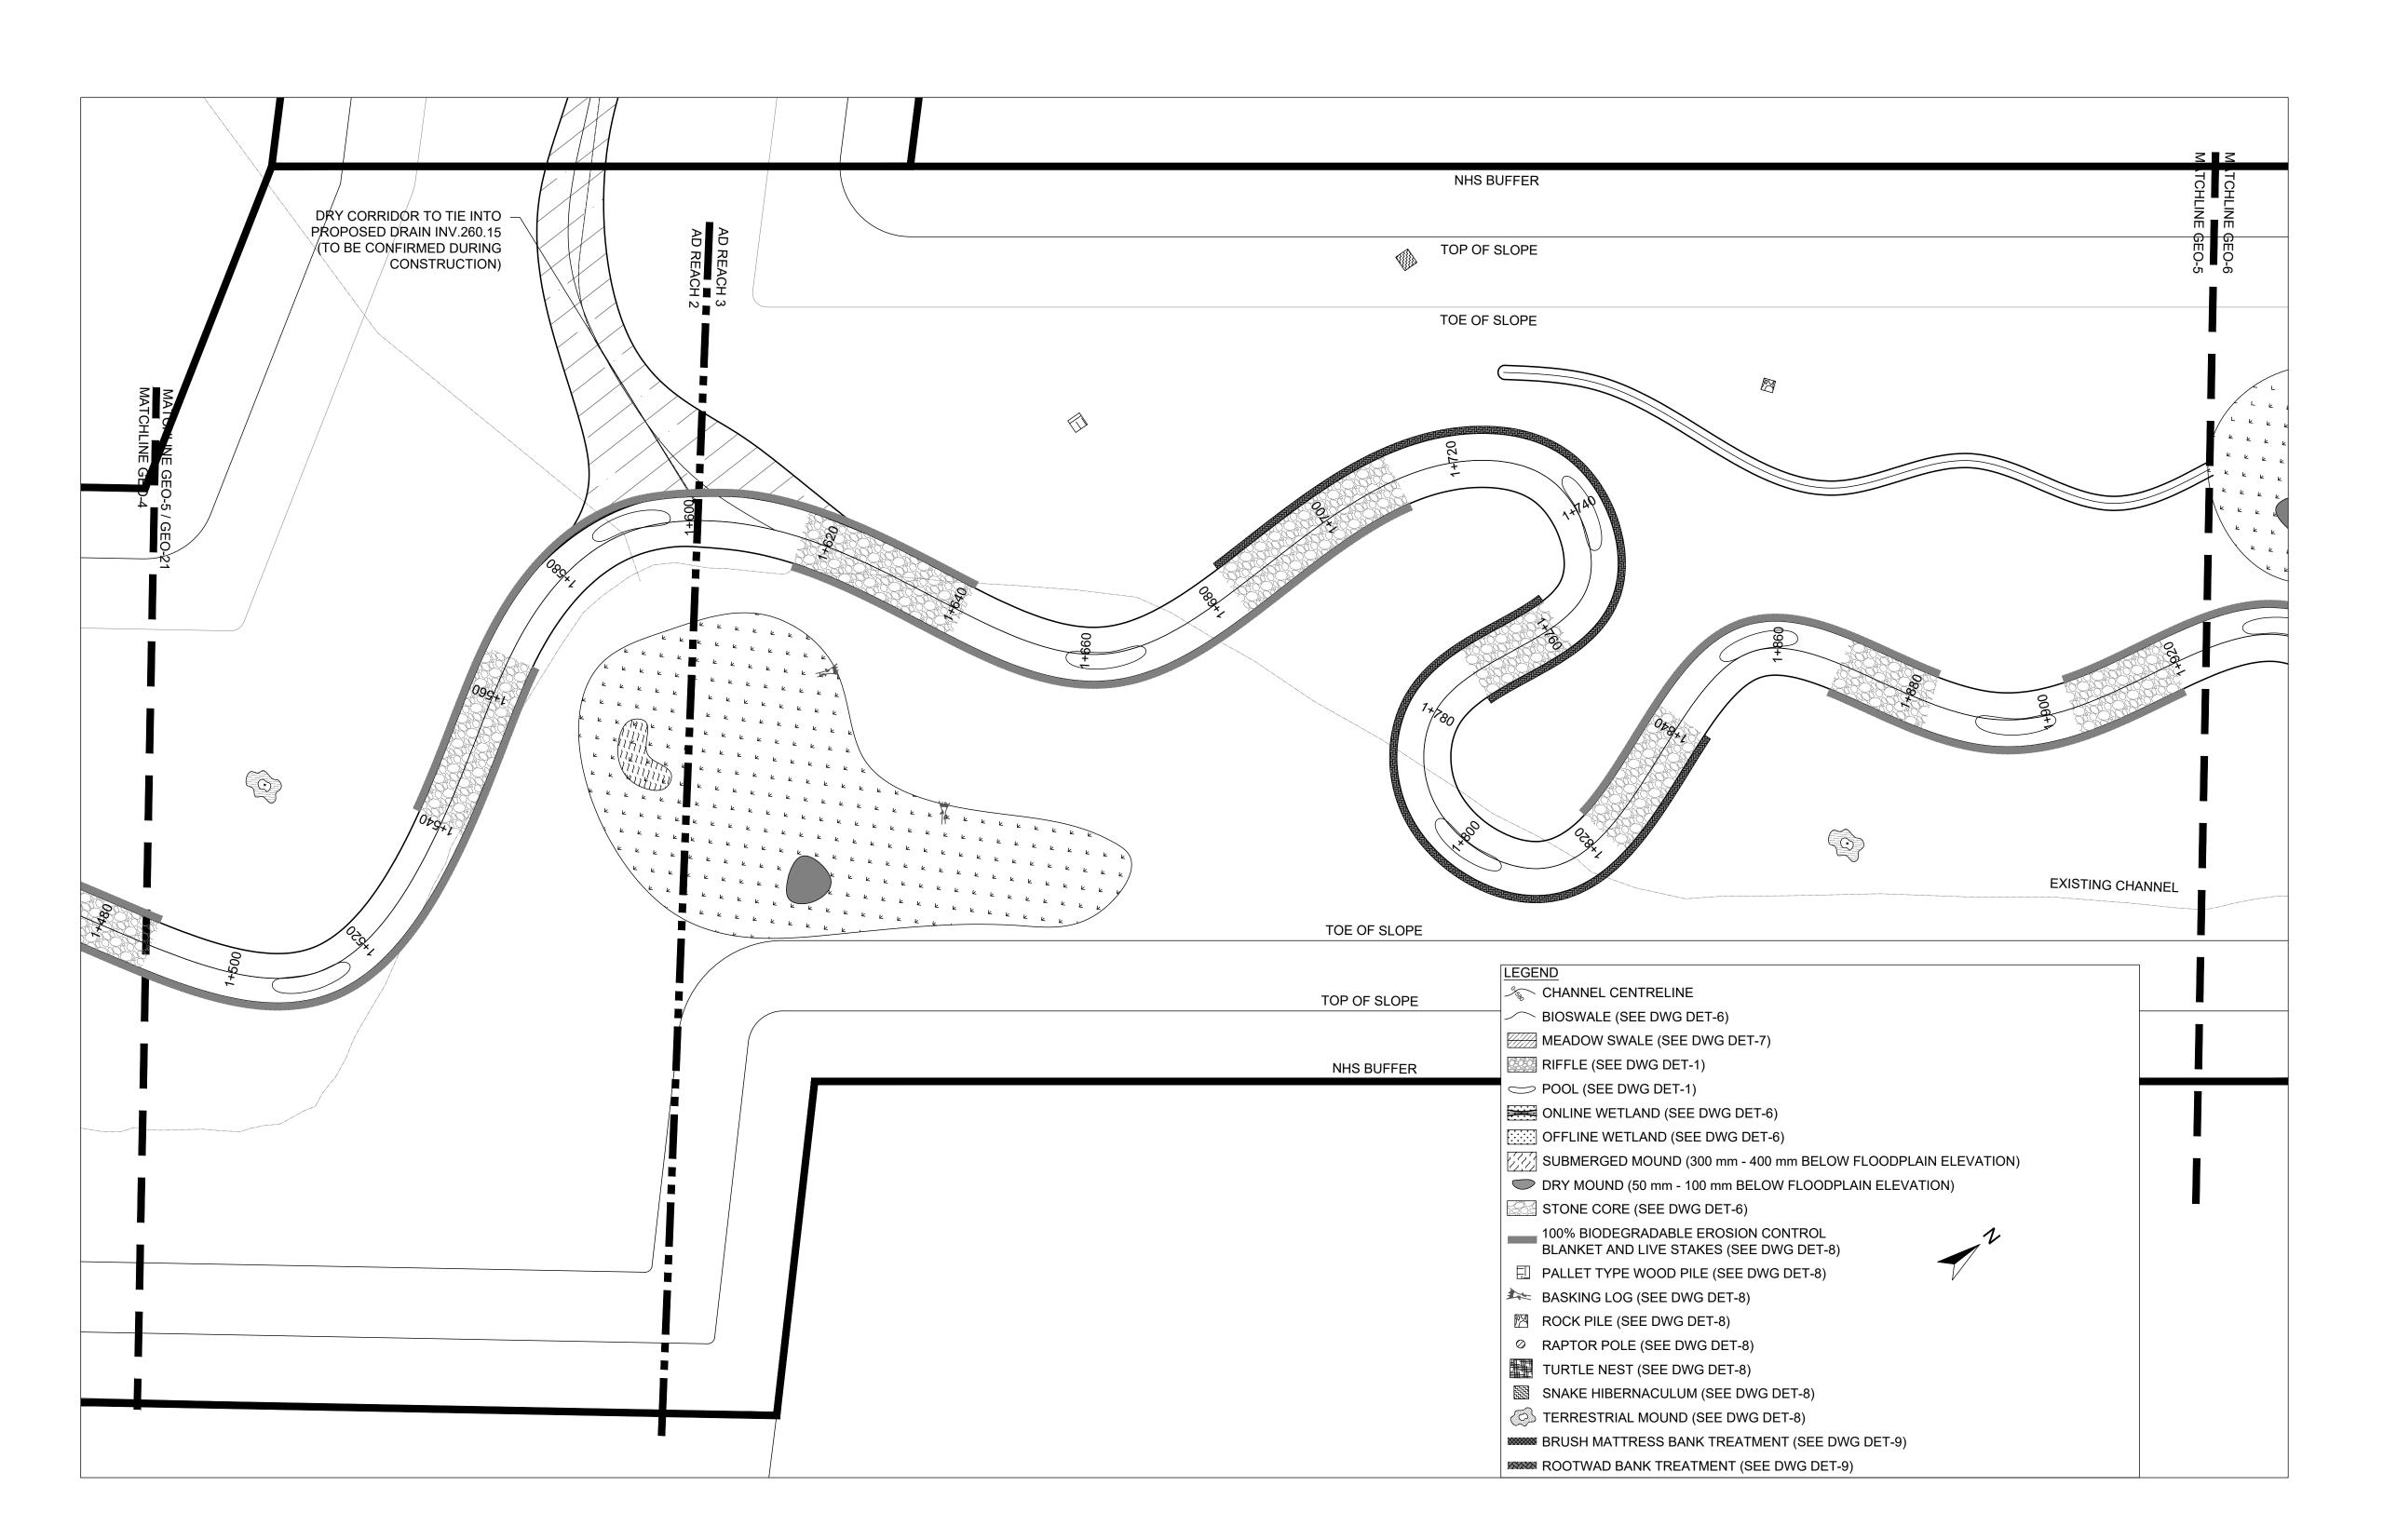

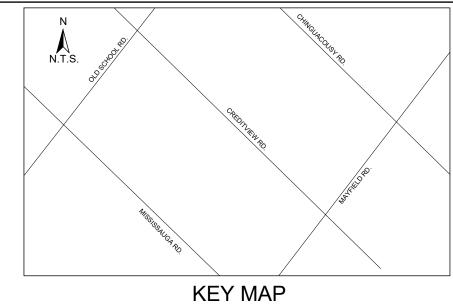

- 1. THE ACCOMPANYING CHANNEL REALIGNMENT TECHNICAL DESIGN BRIEF PREPARED BY GEO MORPHIX LTD. (2023) PROVIDES ADDITIONAL DESIGN DETAILS AND DIRECTION FOR IMPLEMENTATION AND IS TO BE REVIEWED IN CONJUNCTION WITH THIS DRAWING SET.
- 2. ALL CONTRACT DRAWINGS, SPECIFICATIONS AND APPLICABLE PERMITS MUST BE KEPT ON SITE DURING
- CONSTRUCTION FOR REFERENCE.

 3. THE CONTRACTOR MUST NOTIFY THE DESIGNER AND CONTRACT ADMINISTRATOR OF THE INTENT TO COMMENCE WORK AT LEAST 48 HOURS IN ADVANCE.
- 4. THE CONTRACTOR IS RESPONSIBLE FOR ALL UTILITY LOCATES.
 5. LAYOUT MUST BE REVIEWED AND APPROVED BY THE DESIGNER / DESIGNER REPRESENTATIVE, DESIGNATED
- ENGINEER, AND THE CONTRACT ADMINISTRATOR. CONSTRUCTION OBSERVATION IS TO BE PERFORMED BY A CERTIFIED FLUVIAL GEOMORPHOLOGIST OR EXPERIENCED ENVIRONMENTAL INSPECTOR UNDER DIRECTION FROM THE DESIGNER.
- 7. ON-SITE SUPPORT FROM PROJECT ENGINEER (E.G., GEOTECHNICAL, HYDROGEOLOGICAL, AND/OR WATER
- RESOURCES ENGINEER) REQUIRED TO ASSESS AND ENSURE FAVOURABLE SURFICIAL AND SUBSURFACE CONDITIONS TO SUPPORT CHANNEL REALIGNMENT CONSTRUCTION. 8. BE ADVISED THAT THE LOCAL REGULATORY BODY MAY, AT ANY TIME, WITHDRAW THIS PERMISSION, IF, IN THE
- OPINION OF THE AUTHORITY. THE CONDITIONS OF THE PERMIT ARE NOT BEING COMPLIED WITH. THIS APPROVAL DOES NOT EXEMPT THE PROPERTY OWNER/APPLICANT/AGENT FROM THE PROVISIONS OF ANY OTHER FEDERAL, PROVINCIAL OR MUNICIPAL STATUTES, REGULATIONS OR BY-LAWS, OR ANY RIGHTS UNDER COMMON LAW.

TIMING OF WORKS

- 1. WORKS SHALL BE COMPLETED DURING THE DESIGNATED IN-WATER WORKS WINDOW SET OUT BY MNRF/DFO. 2. TREE CLEARING IS TO BE COMPLETED OUTSIDE THE BIRD NESTING SEASON (APRIL 1ST TO AUGUST 1ST) TO COMPLY WITH THE FEDERAL MIGRATORY BIRDS CONVENTION ACT. ANY TREES THAT REQUIRE REMOVAL OUTSIDE
- OF THIS TIMING WINDOW MUST FIRST BE INSPECTED BY A QUALIFIED BIOLOGIST TO DETERMINE THE PRESENCE OF 3. THE WEATHER FORECAST SHOULD BE CONTINUALLY MONITORED TO ENSURE THAT WORKS ARE UNDERTAKEN
- ONLY DURING FAVOURABLE WEATHER CONDITIONS 4. COMPLETE THE WORKS WITH MINIMAL AVOIDABLE INTERRUPTIONS ONCE THEY COMMENCE.

SITE AND MATERIAL MANAGEMENT

- 1. ALL CONSTRUCTION EQUIPMENT AND MATERIALS (IMPORTED OR EXCAVATED) MUST BE STORED AT LEAST 30 m
- AWAY FROM ANY WATERBODY IN A STABLE AREA ABOVE THE ACTIVE FLOODPLAIN, OR IN A DESIGNATED
- 2. IN THE EVENT OF AN UNEXPECTED STORM, ALL UNFIXED ITEMS THAT HAVE THE POTENTIAL TO CAUSE A SPILL OR AN OBSTRUCTION TO FLOW MUST BE MOVED A STABLE AREA ABOVE ACTIVE FLOODPLAIN. 3. STOCKPILES MUST BE LOCATED OUTSIDE THE ISOLATED WORK AREAS.
- 4. STABILIZE, TEMPORARILY OR PERMANENTLY, ANY DISTURBED AREAS AS WORK PROGRESSES, OR SOON AS CONDITIONS ALLOW.
- 5. MINIMIZE THE AREA OF DISTURBANCE TO THE EXTENT POSSIBLE. ALL DISTURBED GROUND LEFT INACTIVE FOR MORE THAN 30 DAYS SHALL BE STABILIZED USING APPROPRIATE EROSION CONTROL MEASURES AND AN
- APPROPRIATE SEED MIX AS NOTED WITHIN THE FINAL APPROVED RESTORATION PLAN. 6. ALL VEGETATION, ADJACENT TO THE WORK AREA, MUST BE PROTECTED AND DELINEATED WITH CONSTRUCTION
- FENCING OR TREE PROTECTION BARRIERS. 7. ALL GRADES IN THE AREA REGULATED BY THE CONSERVATION AUTHORITY MUST BE MAINTAINED OR MATCHED,
- UNLESS OTHERWISE AUTHORIZED IN THE APPLICABLE PERMIT.

 8. AN AFTER-HOURS CONTACT NUMBER IS TO BE VISIBLY POSTED ONSITE FOR EMERGENCIES. ALL THE PLANS SHOULD HAVE NAME AND CONTACT INFO OF THE PERSON RESPONSIBLE FOR ESC MEASURES.

EROSION AND SEDIMENT CONTROL

- ALL TEMPORARY EROSION AND SEDIMENT CONTROL MEASURES MUST BE INSTALLED PRIOR TO START OF WORKS.
 FOLLOWING INSTALLATION OF THE PROPOSED ESC MEASURES, A QUALIFIED AGENT OF THE PROPONENT (E.G. CAN-CISEC CERTIFIED MONITOR) WILL CONDUCT REGULAR SITÉ VISITS TO MONITOR ALL WORKS, PARTICULARLY THE CONDITION OF THE ESC MEASURES, DEWATERING, AND IN- OR NEAR-WATER WORKS. SHOULD CONCERNS ARISE; THE ENVIRONMENTAL MONITOR WILL CONTACT THE PROPONENT, THE CONSERVATION AUTHORITY, AND
- ANY OTHER APPROPRIATE PARTIES. 3. EROSION AND SEDIMENT CONTROLS MUST BE MAINTAINED DURING CONSTRUCTION, AND ANY REQUIRED REPAIRS OR REPLACEMENTS MUST BE COMPLETED WITHIN 24 HOURS AFTER THEY HAVE BEEN IDENTIFIED DURING THE
- 4. EROSION AND SEDIMENT CONTROLS MAY REQUIRE PERIODIC ADJUSTMENTS TO REFLECT CHANGING SITE CONDITIONS. THE CONTRACTOR WILL BE RESPONSIBLE FOR THESE ADJUSTMENTS TO ENSURE PROPER
- 5. ANY CHANGES TO THE EROSION AND SEDIMENT CONTROL PLAN BEYOND MINOR ADJUSTMENTS MUST BE APPROVED BY THE CONTRACT ADMINISTRATOR.
- 6. ADDITIONAL EROSION AND SEDIMENT CONTROL SUPPLIES MUST BE KEPT ON SITE IN ORDER TO FACILITATE IMMEDIATE REPAIRS AND/OR UPGRADES AS NEEDED.
- 7. ALL TEMPORARY SEDIMENT CONTROLS MUST BE REMOVED AFTER THE CONTRACT ADMINISTRATOR DEEMS THE 8. THE PROJECT PROPONENT OR THEIR REPRESENTATIVE IS ULTIMATELY RESPONSIBLE FOR CONTROLLING
- SEDIMENT AND EROSION WITHIN THE CONSTRUCTION SITE FOR THE TOTAL PERIOD OF THE CONSTRUCTION. 9. IF EXCESSIVE SILTATION RESULTS FROM THE CONSTRUCTION ACTIVITIES, THE ONSITE SUPERVISOR/INSPECTOR AND/OR THE LOCAL REGULATORY BODY RESERVE THE RIGHT TO REQUEST ADDITIONAL ESC MEASURES WHICH WOULD BE INSTALLED PRIOR TO FURTHER CONSTRUCTION ACTIVITIES.

DELETERIOUS SUBSTANCE CONTROL/SPILL MANAGEMENT

- PREVENT THE RELEASE OF SEDIMENT, SEDIMENT-LADEN WATER, RAW CONCRETE, CONCRETE LEACHATE OR ANY OTHER DELETERIOUS SUBSTANCES INTO ANY WATERBODY, RAVINE OR STORM SEWER SYSTEM. 2. ENSURE EQUIPMENT AND MACHINERY ARE IN GOOD OPERATING CONDITION (POWER WASHED), FREE OF LEAKS, EXCESS OIL, AND GREASE.

 3. NO EQUIPMENT REFUELLING OR SERVICING SHOULD BE UNDERTAKEN WITHIN 30 m OF ANY WATERCOURSE OR
- SURFACE WATER DRAINAGE.
- A SPILL CONTAINMENT KIT MUST BE READILY ACCESSIBLE ON SITE IN THE EVENT OF A RELEASE OF A DELETERIOUS SUBSTANCE TO THE ENVIRONMENT. ONSITE STAFF MUST BE TRAINED IN ITS USE.
- 5. THE CONTRACT ADMINISTRATOR MUST BE NOTIFIED IMMEDIATELY IN THE EVENT OF A SPILL OF DELETERIOUS SUBSTANCE. ANY SEDIMENT SPILL FROM THE SITE SHOULD BE REPORTED TO MINISTRY OF ENVIRONMENT (SPILL ACTION CENTER) AT 1-800-268-6060.

WORK AREA ISOLATION

- 1. ALL WORK IN ISOLATED WORK AREAS MUST BE COMPLETED IN THE DRY. AN ADEQUATE NUMBER OF PUMPS MUST BE USED FOR UNWATERING.
 2. CROSSING AN ACTIVE WATERCOURSE OR WETLAND BY EQUIPMENT, VEHICLES, PERSONNEL, ETC. IS NOT
- PERMITTED UNLESS APPROVED BY THE CONSERVATION AUTHORITY. ALL ACCESS TO WORK SITES SHALL BE FROM EITHER SIDES OF THE WATERCOURSE OR WETLAND.
- 3. THE UNWATERING DISCHARGE LOCATION MUST BE LOCATED AT LEAST 30 M FROM ANY WATERCOURSE OR WETLAND IN AN AREA WITH DENSE VEGETATIVE GROUNDCOVER, AND WHERE THE DISCHARGE CAN RETURN TO THE WATERBODY DOWNSTREAM OF THE WORK AREA OVER THE GROUNDCOVER.
- 4. FISH MUST BE REMOVED FROM THE WORK AREA ONCE ISOLATED. FISH SALVAGE MUST BE COMPLETED BY A QUALIFIED TECHNICIAN WITH A LICENSE FROM THE ONTARIO MINISTRY OF NATURAL RESOURCES AND FORESTRY

DATE BY **REVISIONS** CHECKED BY: PV DESIGNED BY: LD/AS DRAWN BY: AL/CP/SC DATE: JUNE 2024

DRAFT FOR **INTERNAL**

DISCUSSION

NOT FOR CONSTRUCTION

 $M O R P H I X^{\mathsf{m}}$ 36 Main St N., P.O. Box 205 Campbellville, Ontario L0P 1B0 T: 416.920.0926 www.geomorphix.com


ALLOA SPA **TOWN OF CALEDON**

ETOBICOKE CREEK - ALLOA DRAIN CONCEPTUAL CHANNEL DESIGN CHANNEL PLANFORM


PROJECT No.: PN24009 DRAWING No.: GEO-5

SCALED FOR PLOT ON 'ARCH D' | SCALE: AS NOTED

SHEET 6 OF 35

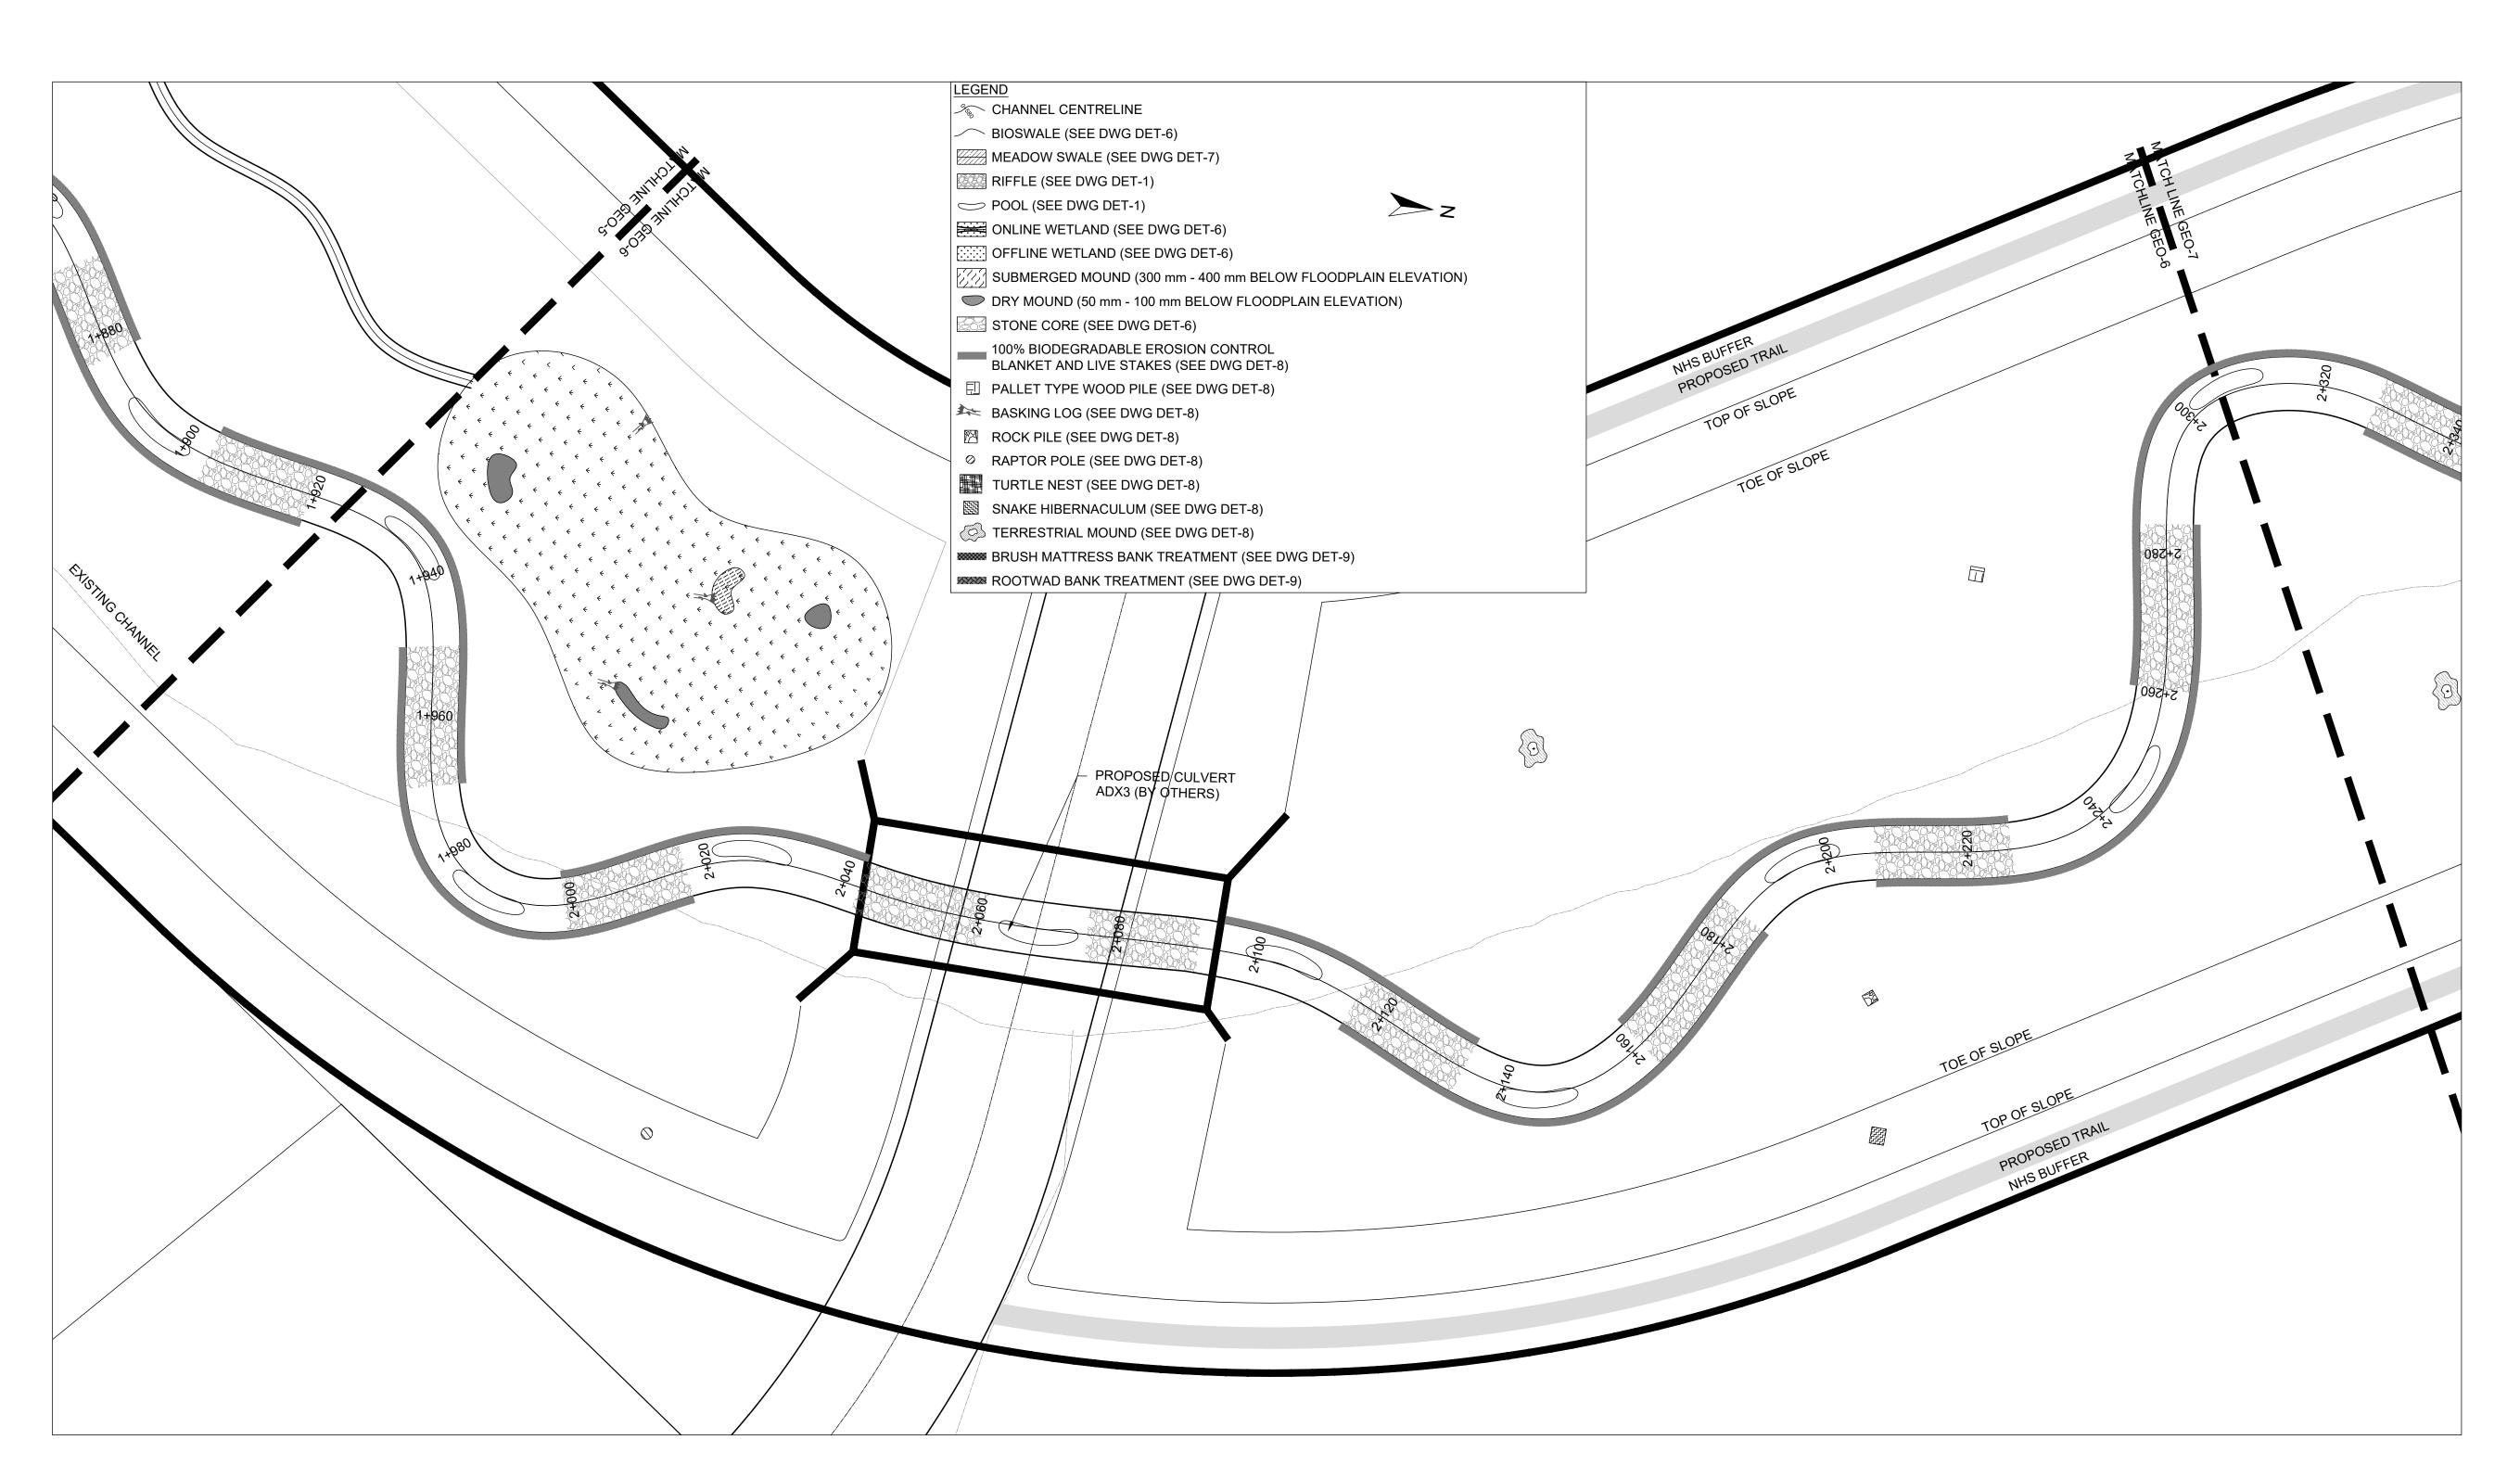

PLANFORM 1:500

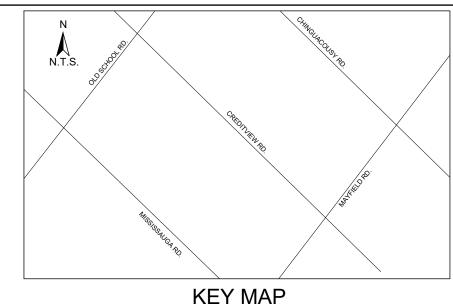

- 1. THE ACCOMPANYING CHANNEL REALIGNMENT TECHNICAL DESIGN BRIEF PREPARED BY GEO MORPHIX LTD. (2023) PROVIDES ADDITIONAL DESIGN DETAILS AND DIRECTION FOR IMPLEMENTATION AND IS TO BE REVIEWED IN CONJUNCTION WITH THIS DRAWING SET.
- 2. ALL CONTRACT DRAWINGS, SPECIFICATIONS AND APPLICABLE PERMITS MUST BE KEPT ON SITE DURING
- CONSTRUCTION FOR REFERENCE.

 3. THE CONTRACTOR MUST NOTIFY THE DESIGNER AND CONTRACT ADMINISTRATOR OF THE INTENT TO COMMENCE WORK AT LEAST 48 HOURS IN ADVANCE.
- 4. THE CONTRACTOR IS RESPONSIBLE FOR ALL UTILITY LOCATES.
 5. LAYOUT MUST BE REVIEWED AND APPROVED BY THE DESIGNER / DESIGNER REPRESENTATIVE, DESIGNATED

RESOURCES ENGINEER) REQUIRED TO ASSESS AND ENSURE FAVOURABLE SURFICIAL AND SUBSURFACE

- ENGINEER, AND THE CONTRACT ADMINISTRATOR. CONSTRUCTION OBSERVATION IS TO BE PERFORMED BY A CERTIFIED FLUVIAL GEOMORPHOLOGIST OR EXPERIENCED ENVIRONMENTAL INSPECTOR UNDER DIRECTION FROM THE DESIGNER.
- 7. ON-SITE SUPPORT FROM PROJECT ENGINEER (E.G., GEOTECHNICAL, HYDROGEOLOGICAL, AND/OR WATER
- CONDITIONS TO SUPPORT CHANNEL REALIGNMENT CONSTRUCTION. 8. BE ADVISED THAT THE LOCAL REGULATORY BODY MAY, AT ANY TIME, WITHDRAW THIS PERMISSION, IF, IN THE
- OPINION OF THE AUTHORITY, THE CONDITIONS OF THE PERMIT ARE NOT BEING COMPLIED WITH. THIS APPROVAL DOES NOT EXEMPT THE PROPERTY OWNER/APPLICANT/AGENT FROM THE PROVISIONS OF ANY OTHER FEDERAL, PROVINCIAL OR MUNICIPAL STATUTES, REGULATIONS OR BY-LAWS, OR ANY RIGHTS UNDER COMMON LAW.

- 1. WORKS SHALL BE COMPLETED DURING THE DESIGNATED IN-WATER WORKS WINDOW SET OUT BY MNRF/DFO. 2. TREE CLEARING IS TO BE COMPLETED OUTSIDE THE BIRD NESTING SEASON (APRIL 1ST TO AUGUST 1ST) TO COMPLY WITH THE FEDERAL MIGRATORY BIRDS CONVENTION ACT. ANY TREES THAT REQUIRE REMOVAL OUTSIDE OF THIS TIMING WINDOW MUST FIRST BE INSPECTED BY A QUALIFIED BIOLOGIST TO DETERMINE THE PRESENCE OF
- 3. THE WEATHER FORECAST SHOULD BE CONTINUALLY MONITORED TO ENSURE THAT WORKS ARE UNDERTAKEN
- ONLY DURING FAVOURABLE WEATHER CONDITIONS. 4. COMPLETE THE WORKS WITH MINIMAL AVOIDABLE INTERRUPTIONS ONCE THEY COMMENCE.

SITE AND MATERIAL MANAGEMENT

- 1. ALL CONSTRUCTION EQUIPMENT AND MATERIALS (IMPORTED OR EXCAVATED) MUST BE STORED AT LEAST 30 m
- AWAY FROM ANY WATERBODY IN A STABLE AREA ABOVE THE ACTIVE FLOODPLAIN, OR IN A DESIGNATED
- 2. IN THE EVENT OF AN UNEXPECTED STORM, ALL UNFIXED ITEMS THAT HAVE THE POTENTIAL TO CAUSE A SPILL OR AN OBSTRUCTION TO FLOW MUST BE MOVED A STABLE AREA ABOVE ACTIVE FLOODPLAIN. 3. STOCKPILES MUST BE LOCATED OUTSIDE THE ISOLATED WORK AREAS.
- 4. STABILIZE, TEMPORARILY OR PERMANENTLY, ANY DISTURBED AREAS AS WORK PROGRESSES, OR SOON AS CONDITIONS ALLOW.
- 5. MINIMIZE THE AREA OF DISTURBANCE TO THE EXTENT POSSIBLE. ALL DISTURBED GROUND LEFT INACTIVE FOR MORE THAN 30 DAYS SHALL BE STABILIZED USING APPROPRIATE EROSION CONTROL MEASURES AND AN
- APPROPRIATE SEED MIX AS NOTED WITHIN THE FINAL APPROVED RESTORATION PLAN. 6. ALL VEGETATION, ADJACENT TO THE WORK AREA, MUST BE PROTECTED AND DELINEATED WITH CONSTRUCTION FFNCING OR TREE PROTECTION BARRIERS.
- 7. ALL GRADES IN THE AREA REGULATED BY THE CONSERVATION AUTHORITY MUST BE MAINTAINED OR MATCHED,
- UNLESS OTHERWISE AUTHORIZED IN THE APPLICABLE PERMIT.

 8. AN AFTER-HOURS CONTACT NUMBER IS TO BE VISIBLY POSTED ONSITE FOR EMERGENCIES. ALL THE PLANS SHOULD HAVE NAME AND CONTACT INFO OF THE PERSON RESPONSIBLE FOR ESC MEASURES.

EROSION AND SEDIMENT CONTROL

- 1. ALL TEMPORARY EROSION AND SEDIMENT CONTROL MEASURES MUST BE INSTALLED PRIOR TO START OF WORKS.
 2. FOLLOWING INSTALLATION OF THE PROPOSED ESC MEASURES, A QUALIFIED AGENT OF THE PROPONENT (E.G. CAN-CISEC CERTIFIED MONITOR) WILL CONDUCT REGULAR SITÉ VISITS TO MONITOR ALL WORKS, PARTICULARLY THE CONDITION OF THE ESC MEASURES, DEWATERING, AND IN- OR NEAR-WATER WORKS. SHOULD CONCERNS ARISE; THE ENVIRONMENTAL MONITOR WILL CONTACT THE PROPONENT, THE CONSERVATION AUTHORITY, AND
- 3. EROSION AND SEDIMENT CONTROLS MUST BE MAINTAINED DURING CONSTRUCTION, AND ANY REQUIRED REPAIRS OR REPLACEMENTS MUST BE COMPLETED WITHIN 24 HOURS AFTER THEY HAVE BEEN IDENTIFIED DURING THE
- 4. EROSION AND SEDIMENT CONTROLS MAY REQUIRE PERIODIC ADJUSTMENTS TO REFLECT CHANGING SITE CONDITIONS. THE CONTRACTOR WILL BE RESPONSIBLE FOR THESE ADJUSTMENTS TO ENSURE PROPER
- ANY CHANGES TO THE EROSION AND SEDIMENT CONTROL PLAN BEYOND MINOR ADJUSTMENTS MUST BE APPROVED BY THE CONTRACT ADMINISTRATOR.
- 6. ADDITIONAL EROSION AND SEDIMENT CONTROL SUPPLIES MUST BE KEPT ON SITE IN ORDER TO FACILITATE IMMEDIATE REPAIRS AND/OR UPGRADES AS NEEDED.

 7. ALL TEMPORARY SEDIMENT CONTROLS MUST BE REMOVED AFTER THE CONTRACT ADMINISTRATOR DEEMS THE
- 8. THE PROJECT PROPONENT OR THEIR REPRESENTATIVE IS ULTIMATELY RESPONSIBLE FOR CONTROLLING
- SEDIMENT AND EROSION WITHIN THE CONSTRUCTION SITE FOR THE TOTAL PERIOD OF THE CONSTRUCTION. 9. IF EXCESSIVE SILTATION RESULTS FROM THE CONSTRUCTION ACTIVITIES, THE ONSITE SUPERVISOR/INSPECTOR
- AND/OR THE LOCAL REGULATORY BODY RESERVE THE RIGHT TO REQUEST ADDITIONAL ESC MEASURES WHICH WOULD BE INSTALLED PRIOR TO FURTHER CONSTRUCTION ACTIVITIES.

DELETERIOUS SUBSTANCE CONTROL/SPILL MANAGEMENT

- PREVENT THE RELEASE OF SEDIMENT, SEDIMENT-LADEN WATER, RAW CONCRETE, CONCRETE LEACHATE OR ANY OTHER DELETERIOUS SUBSTANCES INTO ANY WATERBODY, RAVINE OR STORM SEWER SYSTEM. 2. ENSURE EQUIPMENT AND MACHINERY ARE IN GOOD OPERATING CONDITION (POWER WASHED), FREE OF LEAKS, EXCESS OIL, AND GREASE.

 3. NO EQUIPMENT REFUELLING OR SERVICING SHOULD BE UNDERTAKEN WITHIN 30 m OF ANY WATERCOURSE OR
- SURFACE WATER DRAINAGE. A SPILL CONTAINMENT KIT MUST BE READILY ACCESSIBLE ON SITE IN THE EVENT OF A RELEASE OF A
 DELETERIOUS SUBSTANCE TO THE ENVIRONMENT. ONSITE STAFF MUST BE TRAINED IN ITS USE.
- 5. THE CONTRACT ADMINISTRATOR MUST BE NOTIFIED IMMEDIATELY IN THE EVENT OF A SPILL OF DELETERIOUS SUBSTANCE. ANY SEDIMENT SPILL FROM THE SITE SHOULD BE REPORTED TO MINISTRY OF ENVIRONMENT (SPILL ACTION CENTER) AT 1-800-268-6060.

WORK AREA ISOLATION

- 1. ALL WORK IN ISOLATED WORK AREAS MUST BE COMPLETED IN THE DRY. AN ADEQUATE NUMBER OF PUMPS MUST BE USED FOR UNWATERING.

 CROSSING AN ACTIVE WATERCOURSE OR WETLAND BY EQUIPMENT, VEHICLES, PERSONNEL, ETC. IS NOT
- PERMITTED UNLESS APPROVED BY THE CONSERVATION AUTHORITY. ALL ACCESS TO WORK SITES SHALL BE FROM
- EITHER SIDES OF THE WATERCOURSE OR WETLAND.

 3. THE UNWATERING DISCHARGE LOCATION MUST BE LOCATED AT LEAST 30 M FROM ANY WATERCOURSE OR WETLAND IN AN AREA WITH DENSE VEGETATIVE GROUNDCOVER, AND WHERE THE DISCHARGE CAN RETURN TO THE WATERBODY DOWNSTREAM OF THE WORK AREA OVER THE GROUNDCOVER.
- 4. FISH MUST BE REMOVED FROM THE WORK AREA ONCE ISOLATED. FISH SALVAGE MUST BE COMPLETED BY A QUALIFIED TECHNICIAN WITH A LICENSE FROM THE ONTARIO MINISTRY OF NATURAL RESOURCES AND FORESTRY

	DATE BY		REVISIONS	
DESIGNED BY: LD/AS			CHECKED BY: PV	
DRAW	/N BY: AL/CP/S	SC	DATE: JUNE 2024	

DRAFT FOR **INTERNAL** DISCUSSION


NOT FOR CONSTRUCTION


 $M O R P H I X^{\mathsf{m}}$ 36 Main St N., P.O. Box 205 Campbellville, Ontario L0P 1B0 T: 416.920.0926 www.geomorphix.com

ALLOA SPA **TOWN OF CALEDON**

ETOBICOKE CREEK - ALLOA DRAIN CONCEPTUAL CHANNEL DESIGN CHANNEL PLANFORM

PROJECT No.: PN24009 DRAWING No.: GEO-6 SHEET 7 OF 35

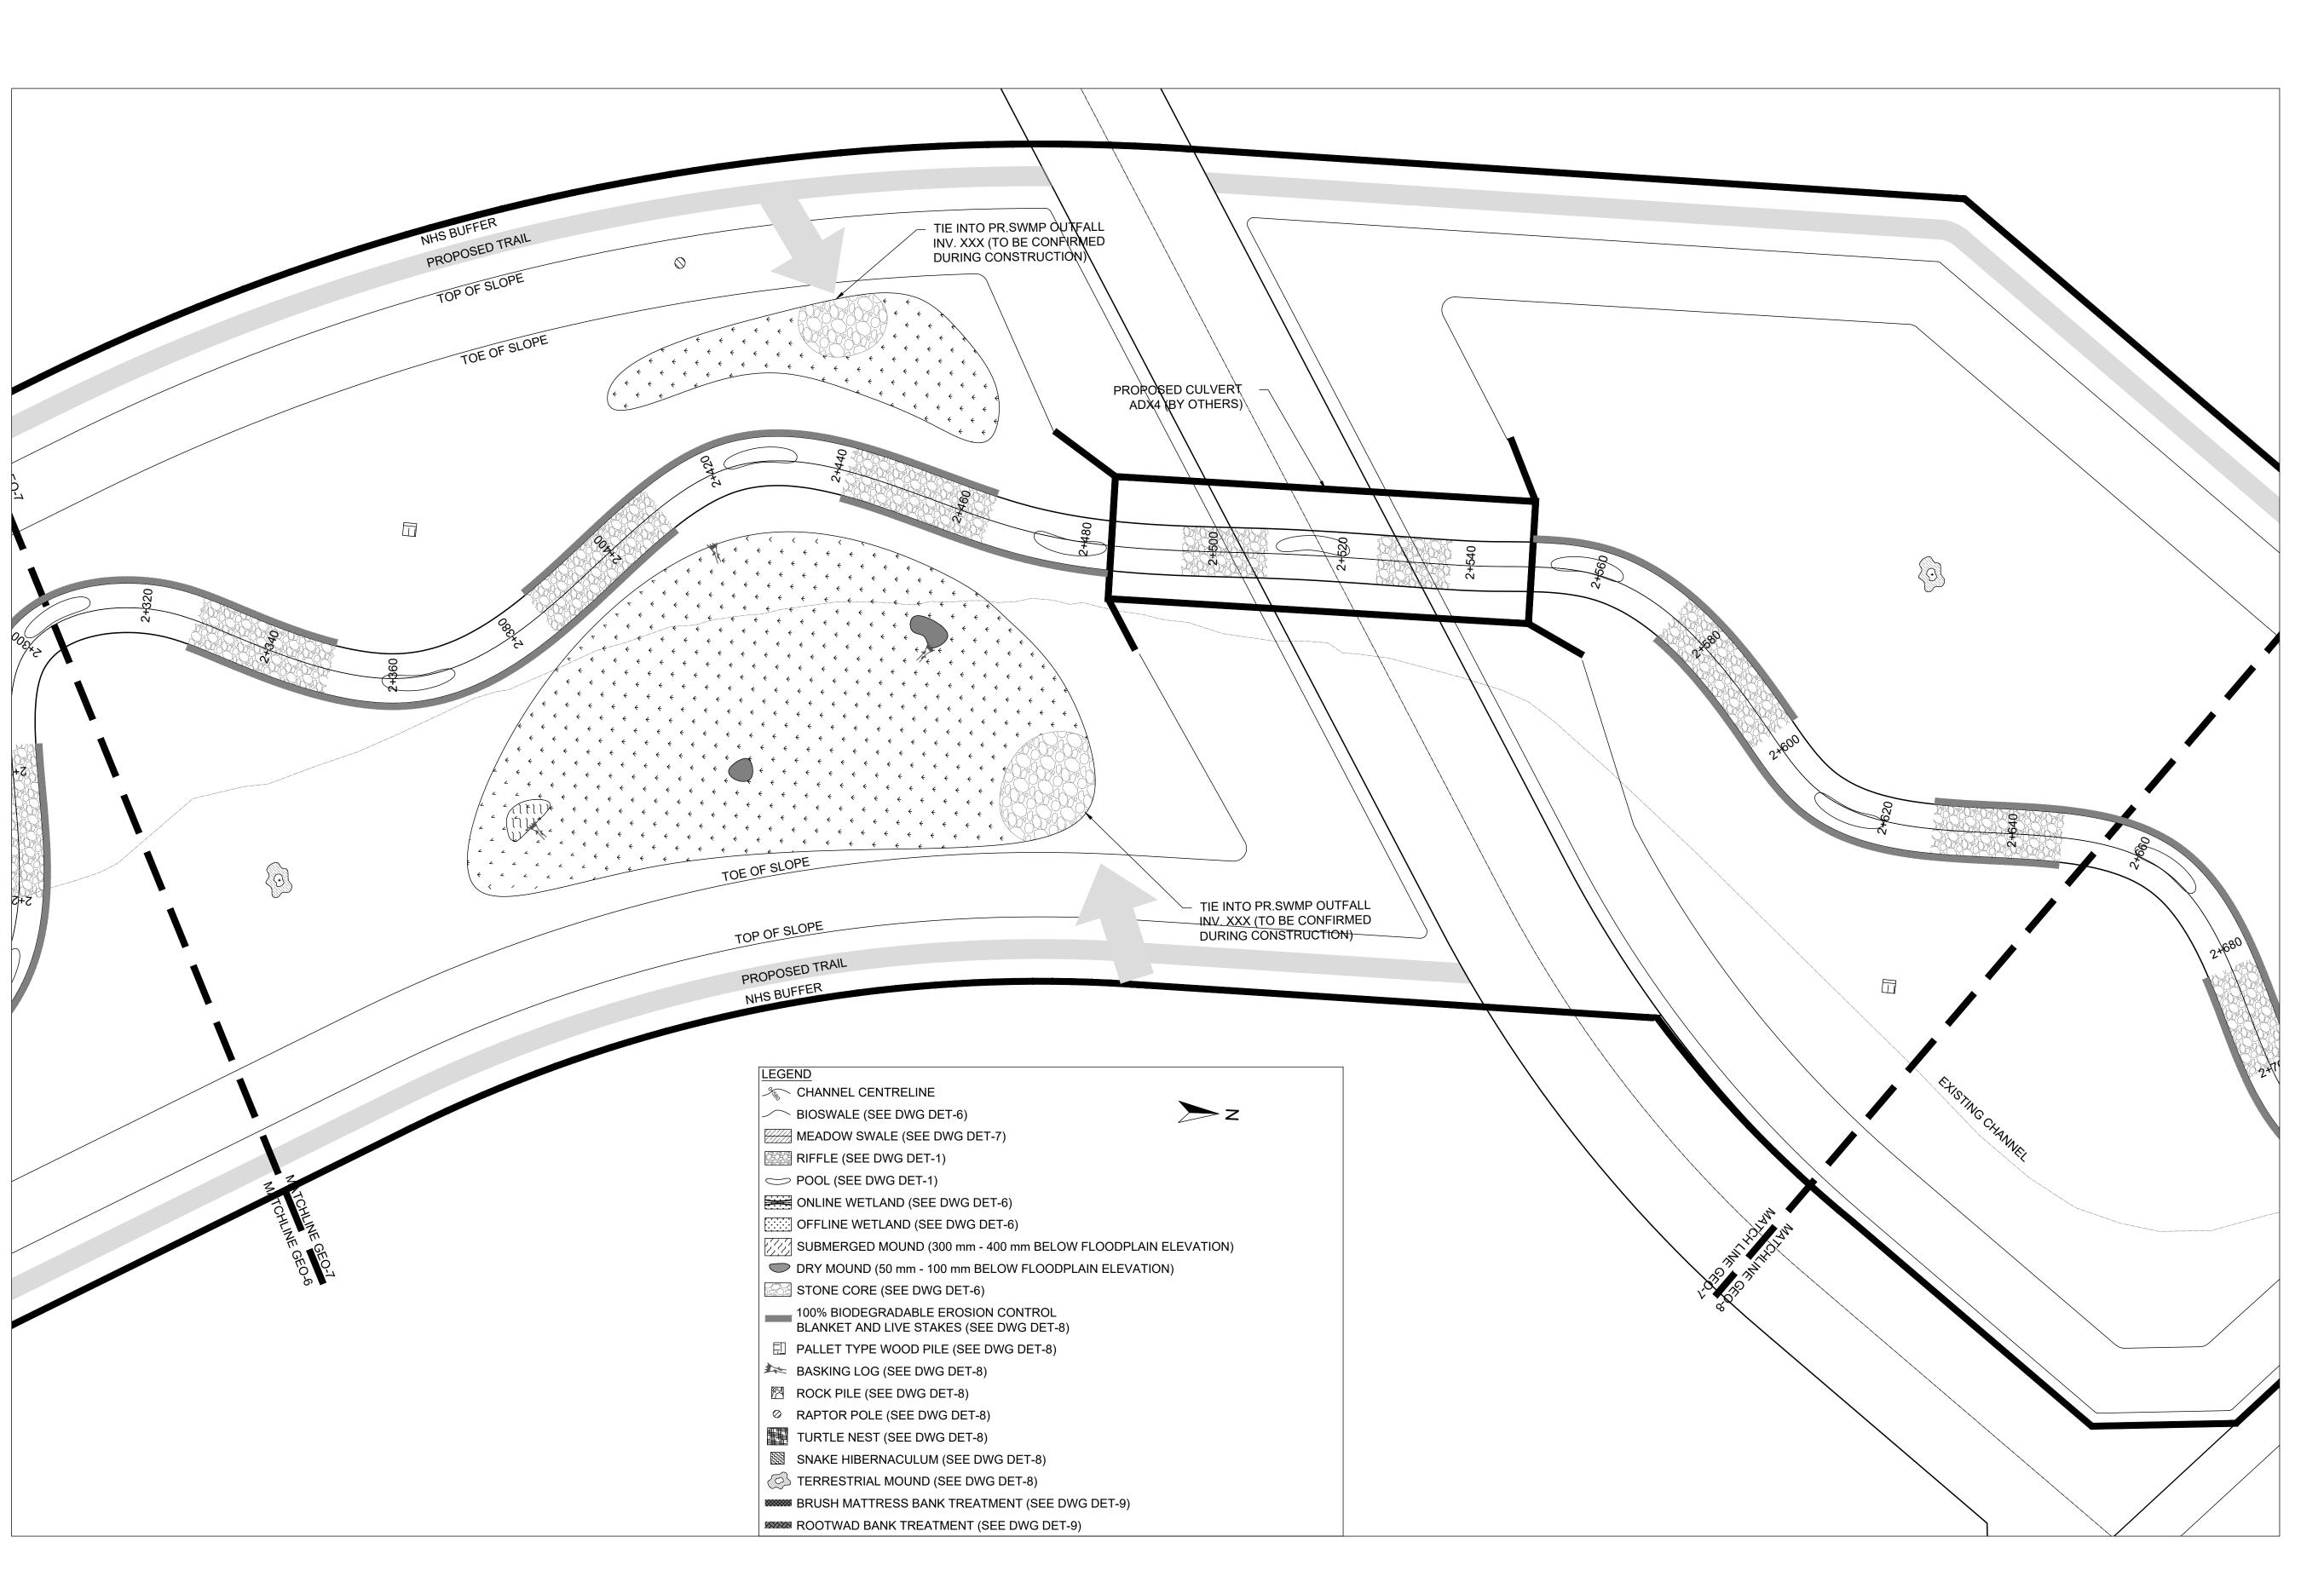

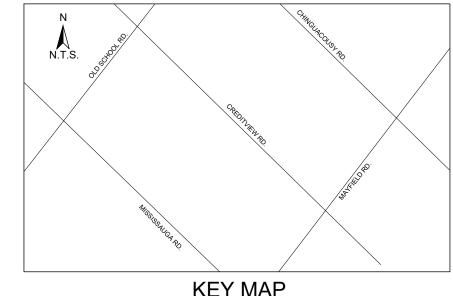

- 1. THE ACCOMPANYING CHANNEL REALIGNMENT TECHNICAL DESIGN BRIEF PREPARED BY GEO MORPHIX LTD. (2023) PROVIDES ADDITIONAL DESIGN DETAILS AND DIRECTION FOR IMPLEMENTATION AND IS TO BE REVIEWED IN
- 2. ALL CONTRACT DRAWINGS, SPECIFICATIONS AND APPLICABLE PERMITS MUST BE KEPT ON SITE DURING CONSTRUCTION FOR REFERENCE.
- 3. THE CONTRACTOR MUST NOTIFY THE DESIGNER AND CONTRACT ADMINISTRATOR OF THE INTENT TO COMMENCE WORK AT LEAST 48 HOURS IN ADVANCE. 4. THE CONTRACTOR IS RESPONSIBLE FOR ALL UTILITY LOCATES.
- 5. LAYOUT MUST BE REVIEWED AND APPROVED BY THE DESIGNER / DESIGNER REPRESENTATIVE, DESIGNATED ENGINEER, AND THE CONTRACT ADMINISTRATOR.
- 6. CONSTRUCTION OBSERVATION IS TO BE PERFORMED BY A CERTIFIED FLUVIAL GEOMORPHOLOGIST OR EXPERIENCED ENVIRONMENTAL INSPECTOR UNDER DIRECTION FROM THE DESIGNER.
- 7. ON-SITE SUPPORT FROM PROJECT ENGINEER (E.G., GEOTECHNICAL, HYDROGEOLOGICAL, AND/OR WATER RESOURCES ENGINEER) REQUIRED TO ASSESS AND ENSURE FAVOURABLE SURFICIAL AND SUBSURFACE
- CONDITIONS TO SUPPORT CHANNEL REALIGNMENT CONSTRUCTION. 8. BE ADVISED THAT THE LOCAL REGULATORY BODY MAY, AT ANY TIME, WITHDRAW THIS PERMISSION, IF, IN THE OPINION OF THE AUTHORITY. THE CONDITIONS OF THE PERMIT ARE NOT BEING COMPLIED WITH. THIS APPROVAL DOES NOT EXEMPT THE PROPERTY OWNER/APPLICANT/AGENT FROM THE PROVISIONS OF ANY OTHER FEDERAL.

PROVINCIAL OR MUNICIPAL STATUTES, REGULATIONS OR BY-LAWS, OR ANY RIGHTS UNDER COMMON LAW. TIMING OF WORKS

4. COMPLETE THE WORKS WITH MINIMAL AVOIDABLE INTERRUPTIONS ONCE THEY COMMENCE.

- 1. WORKS SHALL BE COMPLETED DURING THE DESIGNATED IN-WATER WORKS WINDOW SET OUT BY MNRF/DFO. TREE CLEARING IS TO BE COMPLETED OUTSIDE THE BIRD NESTING SEASON (APRIL 1ST TO AUGUST 1ST) TO COMPLY WITH THE FEDERAL MIGRATORY BIRDS CONVENTION ACT. ANY TREES THAT REQUIRE REMOVAL OUTSIDE OF THIS TIMING WINDOW MUST FIRST BE INSPECTED BY A QUALIFIED BIOLOGIST TO DETERMINE THE PRESENCE OF
- 3. THE WEATHER FORECAST SHOULD BE CONTINUALLY MONITORED TO ENSURE THAT WORKS ARE UNDERTAKEN ONLY DURING FAVOURABLE WEATHER CONDITIONS.

SITE AND MATERIAL MANAGEMENT

CONJUNCTION WITH THIS DRAWING SET.

- 1. ALL CONSTRUCTION EQUIPMENT AND MATERIALS (IMPORTED OR EXCAVATED) MUST BE STORED AT LEAST 30 m
- AWAY FROM ANY WATERBODY IN A STABLE AREA ABOVE THE ACTIVE FLOODPLAIN, OR IN A DESIGNATED
- 2. IN THE EVENT OF AN UNEXPECTED STORM, ALL UNFIXED ITEMS THAT HAVE THE POTENTIAL TO CAUSE A SPILL OR AN OBSTRUCTION TO FLOW MUST BE MOVED A STABLE AREA ABOVE ACTIVE FLOODPLAIN.
- 3. STOCKPILES MUST BE LOCATED OUTSIDE THE ISOLATED WORK AREAS. 4. STABILIZE, TEMPORARILY OR PERMANENTLY, ANY DISTURBED AREAS AS WORK PROGRESSES, OR SOON AS CONDITIONS ALLOW.
- 5. MINIMIZE THE AREA OF DISTURBANCE TO THE EXTENT POSSIBLE. ALL DISTURBED GROUND LEFT INACTIVE FOR MORE THAN 30 DAYS SHALL BE STABILIZED USING APPROPRIATE EROSION CONTROL MEASURES AND AN
- APPROPRIATE SEED MIX AS NOTED WITHIN THE FINAL APPROVED RESTORATION PLAN. 6. ALL VEGETATION, ADJACENT TO THE WORK AREA, MUST BE PROTECTED AND DELINEATED WITH CONSTRUCTION
- FENCING OR TREE PROTECTION BARRIERS. 7. ALL GRADES IN THE AREA REGULATED BY THE CONSERVATION AUTHORITY MUST BE MAINTAINED OR MATCHED,
- UNLESS OTHERWISE AUTHORIZED IN THE APPLICABLE PERMIT.

 8. AN AFTER-HOURS CONTACT NUMBER IS TO BE VISIBLY POSTED ONSITE FOR EMERGENCIES. ALL THE PLANS SHOULD HAVE NAME AND CONTACT INFO OF THE PERSON RESPONSIBLE FOR ESC MEASURES.

EROSION AND SEDIMENT CONTROL

- 1. ALL TEMPORARY EROSION AND SEDIMENT CONTROL MEASURES MUST BE INSTALLED PRIOR TO START OF WORKS. 2. FOLLOWING INSTALLATION OF THE PROPOSED ESC MEASURES, A QUALIFIED AGENT OF THE PROPONENT (E.G. CAN-CISEC CERTIFIED MONITOR) WILL CONDUCT REGULAR SITÉ VISITS TO MONITOR ALL WORKS, PARTICULARLY THE CONDITION OF THE ESC MEASURES, DEWATERING, AND IN- OR NEAR-WATER WORKS. SHOULD CONCERNS ARISE; THE ENVIRONMENTAL MONITOR WILL CONTACT THE PROPONENT, THE CONSERVATION AUTHORITY, AND
- 3 FROSION AND SEDIMENT CONTROLS MUST BE MAINTAINED DURING CONSTRUCTION, AND ANY REQUIRED REPAIRS OR REPLACEMENTS MUST BE COMPLETED WITHIN 24 HOURS AFTER THEY HAVE BEEN IDENTIFIED DURING THE
- 4. EROSION AND SEDIMENT CONTROLS MAY REQUIRE PERIODIC ADJUSTMENTS TO REFLECT CHANGING SITE CONDITIONS. THE CONTRACTOR WILL BE RESPONSIBLE FOR THESE ADJUSTMENTS TO ENSURE PROPER
- 5. ANY CHANGES TO THE EROSION AND SEDIMENT CONTROL PLAN BEYOND MINOR ADJUSTMENTS MUST BE APPROVED BY THE CONTRACT ADMINISTRATOR.
- 6. ADDITIONAL EROSION AND SEDIMENT CONTROL SUPPLIES MUST BE KEPT ON SITE IN ORDER TO FACILITATE IMMEDIATE REPAIRS AND/OR UPGRADES AS NEEDED.
- 7. ALL TEMPORARY SEDIMENT CONTROLS MUST BE REMOVED AFTER THE CONTRACT ADMINISTRATOR DEEMS THE 8. THE PROJECT PROPONENT OR THEIR REPRESENTATIVE IS ULTIMATELY RESPONSIBLE FOR CONTROLLING
- SEDIMENT AND EROSION WITHIN THE CONSTRUCTION SITE FOR THE TOTAL PERIOD OF THE CONSTRUCTION. 9. IF EXCESSIVE SILTATION RESULTS FROM THE CONSTRUCTION ACTIVITIES, THE ONSITE SUPERVISOR/INSPECTOR AND/OR THE LOCAL REGULATORY BODY RESERVE THE RIGHT TO REQUEST ADDITIONAL ESC MEASURES WHICH WOULD BE INSTALLED PRIOR TO FURTHER CONSTRUCTION ACTIVITIES.

DELETERIOUS SUBSTANCE CONTROL/SPILL MANAGEMENT

EITHER SIDES OF THE WATERCOURSE OR WETLAND.

- 1. PREVENT THE RELEASE OF SEDIMENT, SEDIMENT-LADEN WATER, RAW CONCRETE, CONCRETE LEACHATE OR ANY OTHER DELETERIOUS SUBSTANCES INTO ANY WATERBODY, RAVINE OR STORM SEWER SYSTEM. 2. ENSURE EQUIPMENT AND MACHINERY ARE IN GOOD OPERATING CONDITION (POWER WASHED), FREE OF LEAKS, EXCESS OIL, AND GREASE.

 3. NO EQUIPMENT REFUELLING OR SERVICING SHOULD BE UNDERTAKEN WITHIN 30 m OF ANY WATERCOURSE OR
- SURFACE WATER DRAINAGE. 4. A SPILL CONTAINMENT KIT MUST BE READILY ACCESSIBLE ON SITE IN THE EVENT OF A RELEASE OF A DELETERIOUS SUBSTANCE TO THE ENVIRONMENT. ONSITE STAFF MUST BE TRAINED IN ITS USE.
- 5. THE CONTRACT ADMINISTRATOR MUST BE NOTIFIED IMMEDIATELY IN THE EVENT OF A SPILL OF DELETERIOUS SUBSTANCE. ANY SEDIMENT SPILL FROM THE SITE SHOULD BE REPORTED TO MINISTRY OF ENVIRONMENT (SPILL ACTION CENTER) AT 1-800-268-6060.

WORK AREA ISOLATION

- 1. ALL WORK IN ISOLATED WORK AREAS MUST BE COMPLETED IN THE DRY. AN ADEQUATE NUMBER OF PUMPS MUST BE USED FOR UNWATERING.
 2. CROSSING AN ACTIVE WATERCOURSE OR WETLAND BY EQUIPMENT, VEHICLES, PERSONNEL, ETC. IS NOT
- PERMITTED UNLESS APPROVED BY THE CONSERVATION AUTHORITY. ALL ACCESS TO WORK SITES SHALL BE FROM
- 3. THE UNWATERING DISCHARGE LOCATION MUST BE LOCATED AT LEAST 30 M FROM ANY WATERCOURSE OR WETLAND IN AN AREA WITH DENSE VEGETATIVE GROUNDCOVER, AND WHERE THE DISCHARGE CAN RETURN TO THE WATERBODY DOWNSTREAM OF THE WORK AREA OVER THE GROUNDCOVER
- 4. FISH MUST BE REMOVED FROM THE WORK AREA ONCE ISOLATED. FISH SALVAGE MUST BE COMPLETED BY A QUALIFIED TECHNICIAN WITH A LICENSE FROM THE ONTARIO MINISTRY OF NATURAL RESOURCES AND FORESTRY

	DATE	BY		REVISIONS
DESIGNED BY: LD/AS				CHECKED BY: PV

DRAFT FOR **INTERNAL**

DISCUSSION

DRAWN BY: AL/CP/SC

DATE: JUNE 2024

NOT FOR CONSTRUCTION


 $M O R P H I X^{\mathsf{m}}$ 36 Main St N., P.O. Box 205 Campbellville, Ontario L0P 1B0 T: 416.920.0926 www.geomorphix.com


ALLOA SPA **TOWN OF CALEDON**

ETOBICOKE CREEK - ALLOA DRAIN CONCEPTUAL CHANNEL DESIGN CHANNEL PLANFORM

PROJECT No.: PN24009 DRAWING No.: GEO-7 SCALED FOR PLOT ON 'ARCH D' | SCALE: AS NOTED SHEET 8 OF 35

PLANFORM 1:500

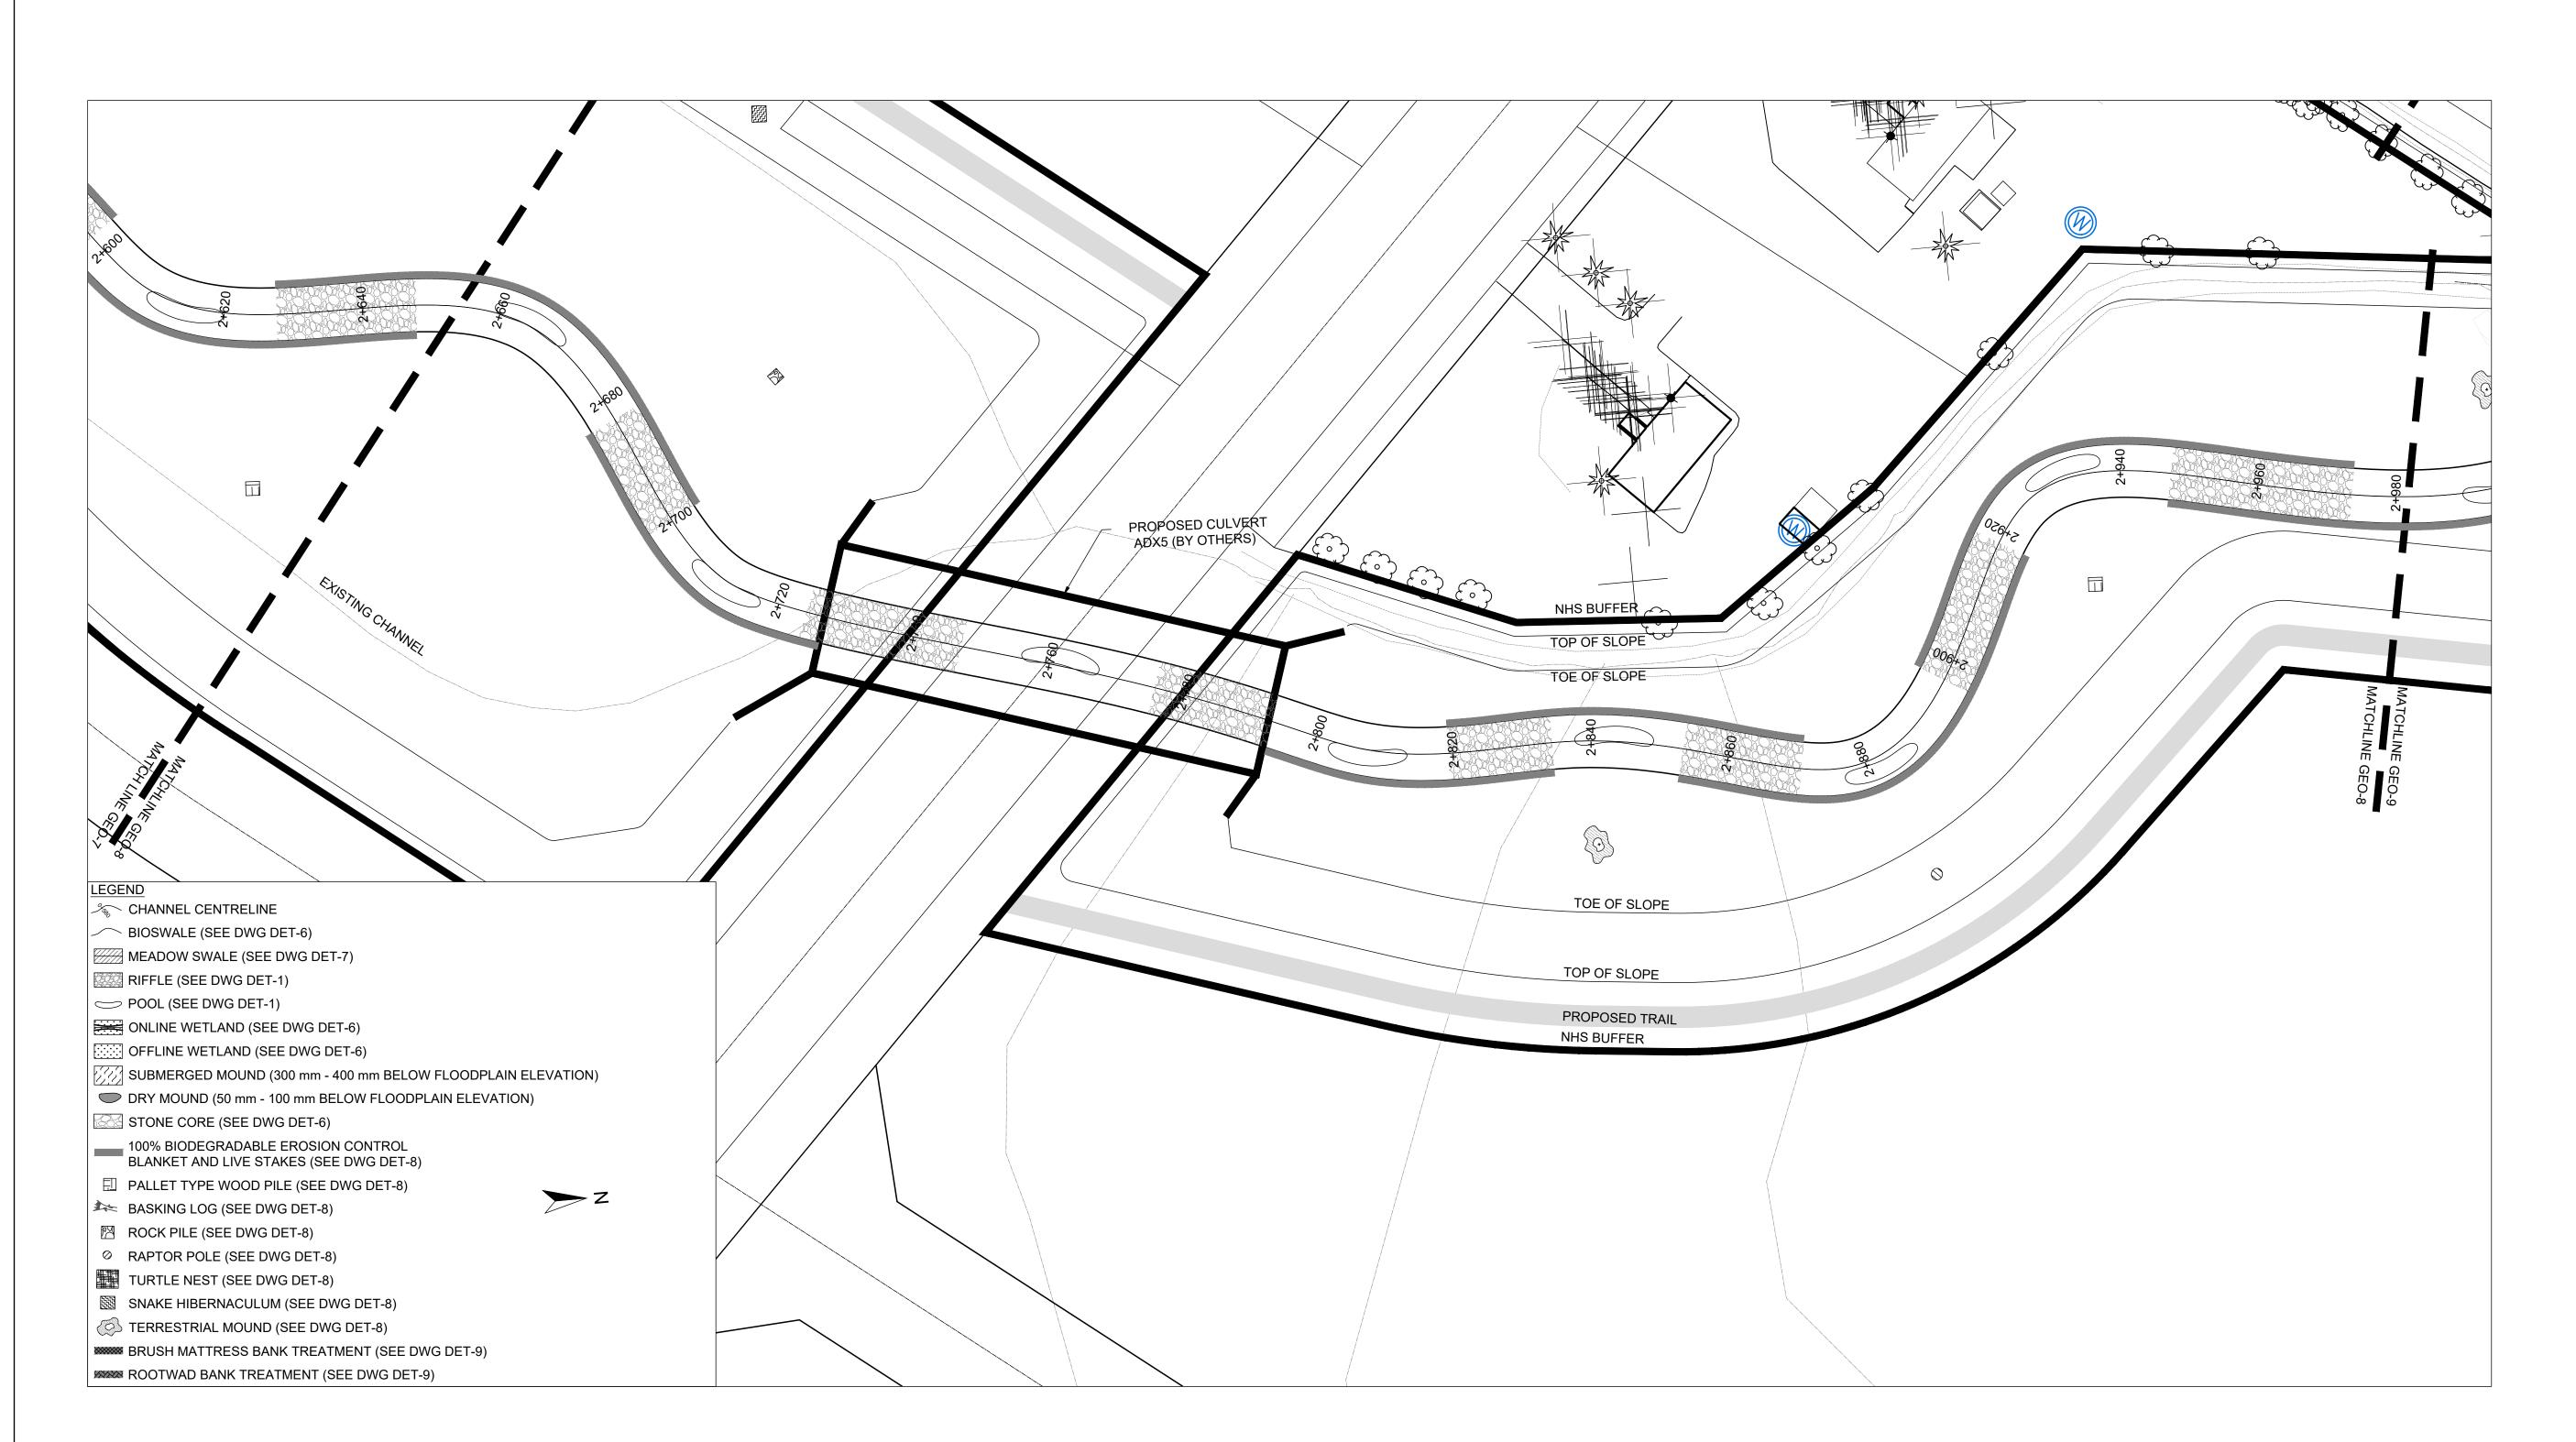

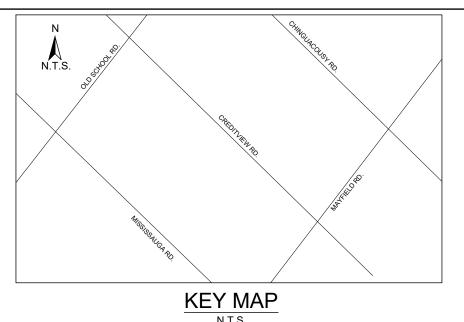

- 1. THE ACCOMPANYING CHANNEL REALIGNMENT TECHNICAL DESIGN BRIEF PREPARED BY GEO MORPHIX LTD. (2023) PROVIDES ADDITIONAL DESIGN DETAILS AND DIRECTION FOR IMPLEMENTATION AND IS TO BE REVIEWED IN CONJUNCTION WITH THIS DRAWING SET.
- 2. ALL CONTRACT DRAWINGS, SPECIFICATIONS AND APPLICABLE PERMITS MUST BE KEPT ON SITE DURING CONSTRUCTION FOR REFERENCE.

 3. THE CONTRACTOR MUST NOTIFY THE DESIGNER AND CONTRACT ADMINISTRATOR OF THE INTENT TO COMMENCE
- WORK AT LEAST 48 HOURS IN ADVANCE.
- 4. THE CONTRACTOR IS RESPONSIBLE FOR ALL UTILITY LOCATES.
 5. LAYOUT MUST BE REVIEWED AND APPROVED BY THE DESIGNER / DESIGNER REPRESENTATIVE, DESIGNATED ENGINEER, AND THE CONTRACT ADMINISTRATOR.
- CONSTRUCTION OBSERVATION IS TO BE PERFORMED BY A CERTIFIED FLUVIAL GEOMORPHOLOGIST OR EXPERIENCED ENVIRONMENTAL INSPECTOR UNDER DIRECTION FROM THE DESIGNER.
- 7. ON-SITE SUPPORT FROM PROJECT ENGINEER (E.G., GEOTECHNICAL, HYDROGEOLOGICAL, AND/OR WATER RESOURCES ENGINEER) REQUIRED TO ASSESS AND ENSURE FAVOURABLE SURFICIAL AND SUBSURFACE CONDITIONS TO SUPPORT CHANNEL REALIGNMENT CONSTRUCTION.
- 8. BE ADVISED THAT THE LOCAL REGULATORY BODY MAY, AT ANY TIME, WITHDRAW THIS PERMISSION, IF, IN THE OPINION OF THE AUTHORITY. THE CONDITIONS OF THE PERMIT ARE NOT BEING COMPLIED WITH. THIS APPROVAL DOES NOT EXEMPT THE PROPERTY OWNER/APPLICANT/AGENT FROM THE PROVISIONS OF ANY OTHER FEDERAL, PROVINCIAL OR MUNICIPAL STATUTES, REGULATIONS OR BY-LAWS, OR ANY RIGHTS UNDER COMMON LAW.

- 1. WORKS SHALL BE COMPLETED DURING THE DESIGNATED IN-WATER WORKS WINDOW SET OUT BY MNRF/DFO. TREE CLEARING IS TO BE COMPLETED OUTSIDE THE BIRD NESTING SEASON (APRIL 1ST TO AUGUST 1ST) TO COMPLY WITH THE FEDERAL MIGRATORY BIRDS CONVENTION ACT. ANY TREES THAT REQUIRE REMOVAL OUTSIDE
- OF THIS TIMING WINDOW MUST FIRST BE INSPECTED BY A QUALIFIED BIOLOGIST TO DETERMINE THE PRESENCE OF 3. THE WEATHER FORECAST SHOULD BE CONTINUALLY MONITORED TO ENSURE THAT WORKS ARE UNDERTAKEN
- ONLY DURING FAVOURABLE WEATHER CONDITIONS. 4. COMPLETE THE WORKS WITH MINIMAL AVOIDABLE INTERRUPTIONS ONCE THEY COMMENCE.

SITE AND MATERIAL MANAGEMENT

- 1. ALL CONSTRUCTION EQUIPMENT AND MATERIALS (IMPORTED OR EXCAVATED) MUST BE STORED AT LEAST 30 m
- AWAY FROM ANY WATERBODY IN A STABLE AREA ABOVE THE ACTIVE FLOODPLAIN, OR IN A DESIGNATED
- 2. IN THE EVENT OF AN UNEXPECTED STORM, ALL UNFIXED ITEMS THAT HAVE THE POTENTIAL TO CAUSE A SPILL OR AN OBSTRUCTION TO FLOW MUST BE MOVED A STABLE AREA ABOVE ACTIVE FLOODPLAIN. 3. STOCKPILES MUST BE LOCATED OUTSIDE THE ISOLATED WORK AREAS.
- 4. STABILIZE, TEMPORARILY OR PERMANENTLY, ANY DISTURBED AREAS AS WORK PROGRESSES, OR SOON AS CONDITIONS ALLOW. 5. MINIMIZE THE AREA OF DISTURBANCE TO THE EXTENT POSSIBLE. ALL DISTURBED GROUND LEFT INACTIVE FOR
- MORE THAN 30 DAYS SHALL BE STABILIZED USING APPROPRIATE EROSION CONTROL MEASURES AND AN APPROPRIATE SEED MIX AS NOTED WITHIN THE FINAL APPROVED RESTORATION PLAN.
- 6. ALL VEGETATION, ADJACENT TO THE WORK AREA, MUST BE PROTECTED AND DELINEATED WITH CONSTRUCTION FENCING OR TREE PROTECTION BARRIERS.
- 7. ALL GRADES IN THE AREA REGULATED BY THE CONSERVATION AUTHORITY MUST BE MAINTAINED OR MATCHED,
- UNLESS OTHERWISE AUTHORIZED IN THE APPLICABLE PERMIT.

 8. AN AFTER-HOURS CONTACT NUMBER IS TO BE VISIBLY POSTED ONSITE FOR EMERGENCIES. ALL THE PLANS SHOULD HAVE NAME AND CONTACT INFO OF THE PERSON RESPONSIBLE FOR ESC MEASURES.

EROSION AND SEDIMENT CONTROL

- ALL TEMPORARY EROSION AND SEDIMENT CONTROL MEASURES MUST BE INSTALLED PRIOR TO START OF WORKS.
 FOLLOWING INSTALLATION OF THE PROPOSED ESC MEASURES, A QUALIFIED AGENT OF THE PROPONENT (E.G. CAN-CISEC CERTIFIED MONITOR) WILL CONDUCT REGULAR SITÉ VISITS TO MONITOR ALL WORKS, PARTICULARLY THE CONDITION OF THE ESC MEASURES, DEWATERING, AND IN- OR NEAR-WATER WORKS. SHOULD CONCERNS ARISE; THE ENVIRONMENTAL MONITOR WILL CONTACT THE PROPONENT, THE CONSERVATION AUTHORITY, AND
- ANY OTHER APPROPRIATE PARTIES. 3. EROSION AND SEDIMENT CONTROLS MUST BE MAINTAINED DURING CONSTRUCTION, AND ANY REQUIRED REPAIRS OR REPLACEMENTS MUST BE COMPLETED WITHIN 24 HOURS AFTER THEY HAVE BEEN IDENTIFIED DURING THE
- 4 FROSION AND SEDIMENT CONTROLS MAY REQUIRE PERIODIC ADJUSTMENTS TO REFLECT CHANGING SITE CONDITIONS. THE CONTRACTOR WILL BE RESPONSIBLE FOR THESE ADJUSTMENTS TO ENSURE PROPER
- 5. ANY CHANGES TO THE EROSION AND SEDIMENT CONTROL PLAN BEYOND MINOR ADJUSTMENTS MUST BE
- APPROVED BY THE CONTRACT ADMINISTRATOR. 6. ADDITIONAL EROSION AND SEDIMENT CONTROL SUPPLIES MUST BE KEPT ON SITE IN ORDER TO FACILITATE
- IMMEDIATE REPAIRS AND/OR UPGRADES AS NEEDED. 7. ALL TEMPORARY SEDIMENT CONTROLS MUST BE REMOVED AFTER THE CONTRACT ADMINISTRATOR DEEMS THE
- 8. THE PROJECT PROPONENT OR THEIR REPRESENTATIVE IS ULTIMATELY RESPONSIBLE FOR CONTROLLING SEDIMENT AND EROSION WITHIN THE CONSTRUCTION SITE FOR THE TOTAL PERIOD OF THE CONSTRUCTION. 9. IF EXCESSIVE SILTATION RESULTS FROM THE CONSTRUCTION ACTIVITIES, THE ONSITE SUPERVISOR/INSPECTOR AND/OR THE LOCAL REGULATORY BODY RESERVE THE RIGHT TO REQUEST ADDITIONAL ESC MEASURES WHICH

WOULD BE INSTALLED PRIOR TO FURTHER CONSTRUCTION ACTIVITIES.

DELETERIOUS SUBSTANCE CONTROL/SPILL MANAGEMENT

- PREVENT THE RELEASE OF SEDIMENT, SEDIMENT-LADEN WATER, RAW CONCRETE, CONCRETE LEACHATE OR ANY OTHER DELETERIOUS SUBSTANCES INTO ANY WATERBODY, RAVINE OR STORM SEWER SYSTEM. 2. ENSURE EQUIPMENT AND MACHINERY ARE IN GOOD OPERATING CONDITION (POWER WASHED), FREE OF LEAKS, EXCESS OIL, AND GREASE.

 3. NO EQUIPMENT REFUELLING OR SERVICING SHOULD BE UNDERTAKEN WITHIN 30 m OF ANY WATERCOURSE OR
- SURFACE WATER DRAINAGE. A SPILL CONTAINMENT KIT MUST BE READILY ACCESSIBLE ON SITE IN THE EVENT OF A RELEASE OF A DELETERIOUS SUBSTANCE TO THE ENVIRONMENT. ONSITE STAFF MUST BE TRAINED IN ITS USE.
- 5. THE CONTRACT ADMINISTRATOR MUST BE NOTIFIED IMMEDIATELY IN THE EVENT OF A SPILL OF DELETERIOUS SUBSTANCE. ANY SEDIMENT SPILL FROM THE SITE SHOULD BE REPORTED TO MINISTRY OF ENVIRONMENT (SPILL ACTION CENTER) AT 1-800-268-6060.

WORK AREA ISOLATION

- 1. ALL WORK IN ISOLATED WORK AREAS MUST BE COMPLETED IN THE DRY. AN ADEQUATE NUMBER OF PUMPS MUST BE USED FOR UNWATERING.

 CROSSING AN ACTIVE WATERCOURSE OR WETLAND BY EQUIPMENT, VEHICLES, PERSONNEL, ETC. IS NOT
- PERMITTED UNLESS APPROVED BY THE CONSERVATION AUTHORITY. ALL ACCESS TO WORK SITES SHALL BE FROM
- EITHER SIDES OF THE WATERCOURSE OR WETLAND. 3. THE UNWATERING DISCHARGE LOCATION MUST BE LOCATED AT LEAST 30 M FROM ANY WATERCOURSE OR WETLAND IN AN AREA WITH DENSE VEGETATIVE GROUNDCOVER, AND WHERE THE DISCHARGE CAN RETURN TO
- THE WATERBODY DOWNSTREAM OF THE WORK AREA OVER THE GROUNDCOVER. 4. FISH MUST BE REMOVED FROM THE WORK AREA ONCE ISOLATED. FISH SALVAGE MUST BE COMPLETED BY A
- QUALIFIED TECHNICIAN WITH A LICENSE FROM THE ONTARIO MINISTRY OF NATURAL RESOURCES AND FORESTRY

	DATE	BY		REVISIONS	
DESIGNED BY: LD/AS				CHECKED BY: PV	
DRAWN BY: AL/CP/SC				DATE: JUNE 2024	

DRAFT FOR **INTERNAL** DISCUSSION $M O R P H I X^{\mathsf{m}}$


NOT FOR CONSTRUCTION


36 Main St N., P.O. Box 205 Campbellville, Ontario L0P 1B0 T: 416.920.0926 www.geomorphix.com

ALLOA SPA TOWN OF CALEDON

ETOBICOKE CREEK - ALLOA DRAIN CONCEPTUAL CHANNEL DESIGN CHANNEL PLANFORM

PROJECT No.: PN24009 DRAWING No.: GEO-8 SHEET 9 OF 35

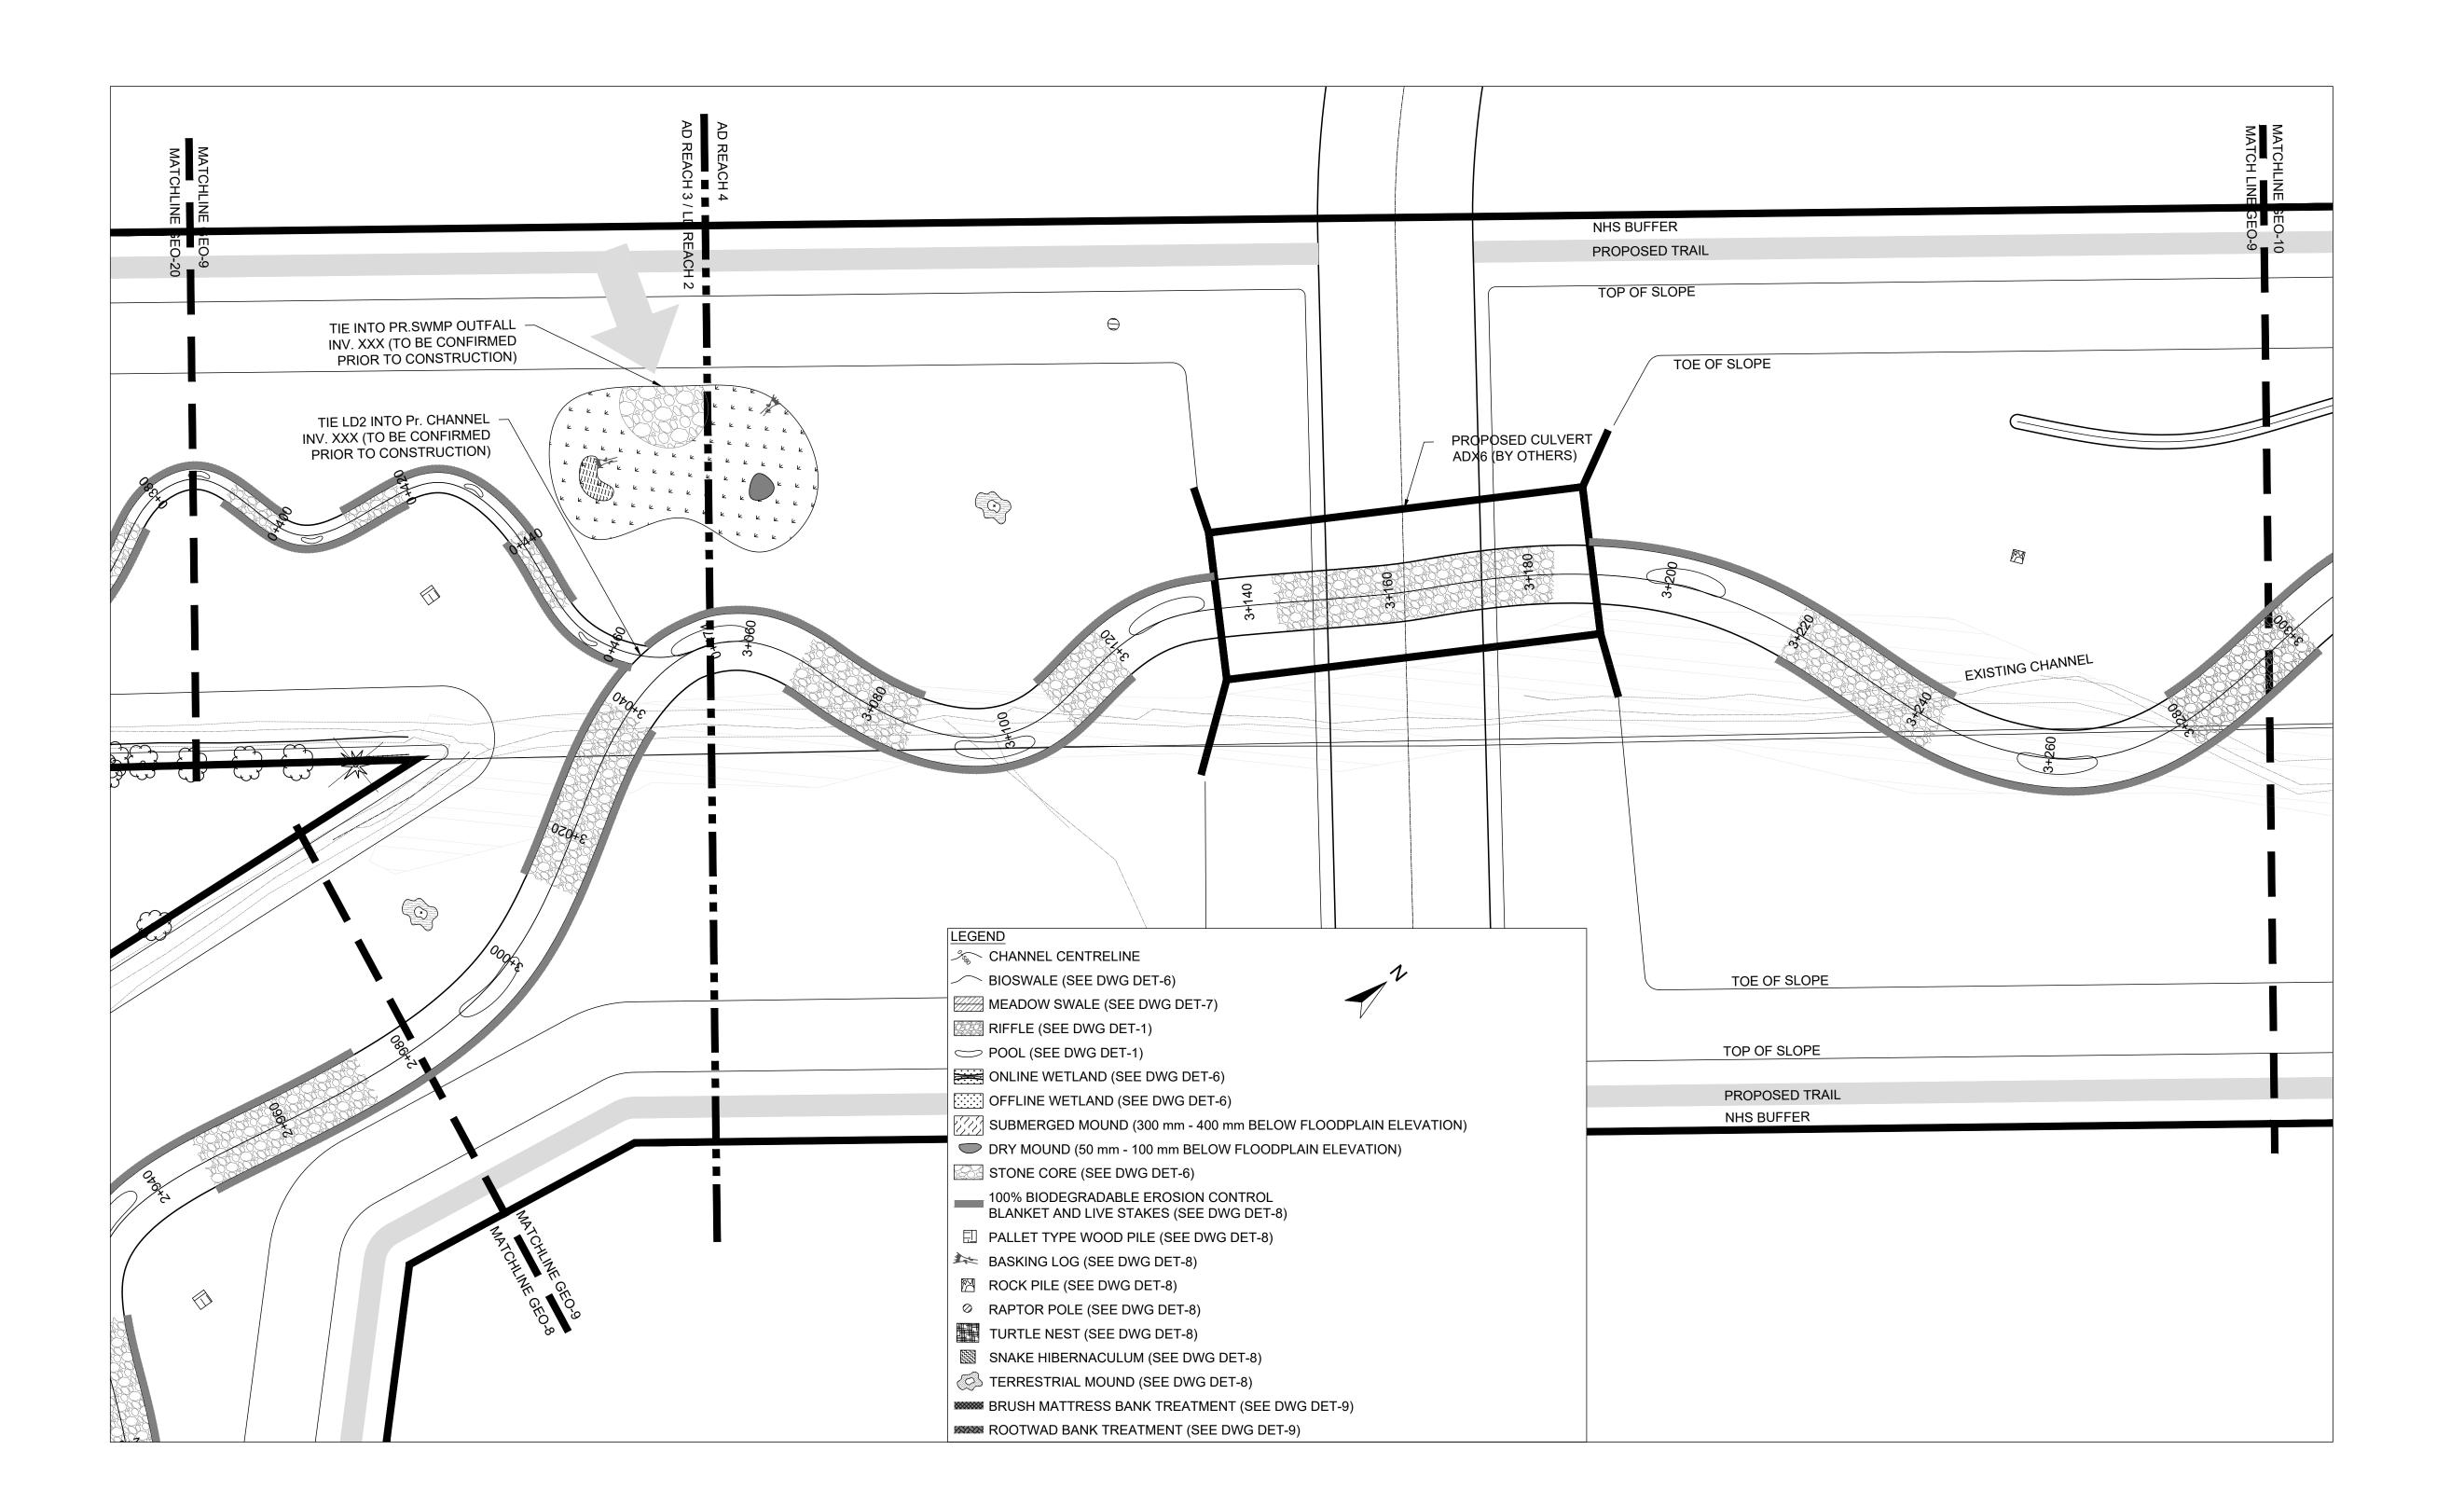

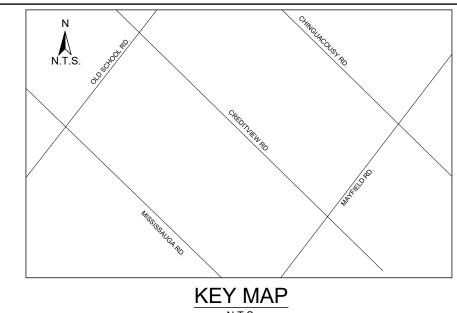

- 1. THE ACCOMPANYING CHANNEL REALIGNMENT TECHNICAL DESIGN BRIEF PREPARED BY GEO MORPHIX LTD. (2023) PROVIDES ADDITIONAL DESIGN DETAILS AND DIRECTION FOR IMPLEMENTATION AND IS TO BE REVIEWED IN CONJUNCTION WITH THIS DRAWING SET.
- 2. ALL CONTRACT DRAWINGS, SPECIFICATIONS AND APPLICABLE PERMITS MUST BE KEPT ON SITE DURING CONSTRUCTION FOR REFERENCE.

 3. THE CONTRACTOR MUST NOTIFY THE DESIGNER AND CONTRACT ADMINISTRATOR OF THE INTENT TO COMMENCE
- WORK AT LEAST 48 HOURS IN ADVANCE.
- 4. THE CONTRACTOR IS RESPONSIBLE FOR ALL UTILITY LOCATES.
 5. LAYOUT MUST BE REVIEWED AND APPROVED BY THE DESIGNER / DESIGNER REPRESENTATIVE, DESIGNATED
- ENGINEER, AND THE CONTRACT ADMINISTRATOR.
- CONSTRUCTION OBSERVATION IS TO BE PERFORMED BY A CERTIFIED FLUVIAL GEOMORPHOLOGIST OR EXPERIENCED ENVIRONMENTAL INSPECTOR UNDER DIRECTION FROM THE DESIGNER.
- 7. ON-SITE SUPPORT FROM PROJECT ENGINEER (E.G., GEOTECHNICAL, HYDROGEOLOGICAL, AND/OR WATER RESOURCES ENGINEER) REQUIRED TO ASSESS AND ENSURE FAVOURABLE SURFICIAL AND SUBSURFACE
- CONDITIONS TO SUPPORT CHANNEL REALIGNMENT CONSTRUCTION. 8. BE ADVISED THAT THE LOCAL REGULATORY BODY MAY, AT ANY TIME, WITHDRAW THIS PERMISSION, IF, IN THE OPINION OF THE AUTHORITY. THE CONDITIONS OF THE PERMIT ARE NOT BEING COMPLIED WITH, THIS APPROVAL DOES NOT EXEMPT THE PROPERTY OWNER/APPLICANT/AGENT FROM THE PROVISIONS OF ANY OTHER FEDERAL,

TIMING OF WORKS

- 1. WORKS SHALL BE COMPLETED DURING THE DESIGNATED IN-WATER WORKS WINDOW SET OUT BY MNRF/DFO. 2. TREE CLEARING IS TO BE COMPLETED OUTSIDE THE BIRD NESTING SEASON (APRIL 1ST TO AUGUST 1ST) TO COMPLY WITH THE FEDERAL MIGRATORY BIRDS CONVENTION ACT. ANY TREES THAT REQUIRE REMOVAL OUTSIDE
- OF THIS TIMING WINDOW MUST FIRST BE INSPECTED BY A QUALIFIED BIOLOGIST TO DETERMINE THE PRESENCE OF

PROVINCIAL OR MUNICIPAL STATUTES, REGULATIONS OR BY-LAWS, OR ANY RIGHTS UNDER COMMON LAW.

3. THE WEATHER FORECAST SHOULD BE CONTINUALLY MONITORED TO ENSURE THAT WORKS ARE UNDERTAKEN ONLY DURING FAVOURABLE WEATHER CONDITIONS. 4. COMPLETE THE WORKS WITH MINIMAL AVOIDABLE INTERRUPTIONS ONCE THEY COMMENCE.

SITE AND MATERIAL MANAGEMENT

- 1. ALL CONSTRUCTION EQUIPMENT AND MATERIALS (IMPORTED OR EXCAVATED) MUST BE STORED AT LEAST 30 m
- AWAY FROM ANY WATERBODY IN A STABLE AREA ABOVE THE ACTIVE FLOODPLAIN, OR IN A DESIGNATED 2. IN THE EVENT OF AN UNEXPECTED STORM, ALL UNFIXED ITEMS THAT HAVE THE POTENTIAL TO CAUSE A SPILL OR AN OBSTRUCTION TO FLOW MUST BE MOVED A STABLE AREA ABOVE ACTIVE FLOODPLAIN.
- 3. STOCKPILES MUST BE LOCATED OUTSIDE THE ISOLATED WORK AREAS.
- 4. STABILIZE, TEMPORARILY OR PERMANENTLY, ANY DISTURBED AREAS AS WORK PROGRESSES, OR SOON AS CONDITIONS ALLOW. 5. MINIMIZE THE AREA OF DISTURBANCE TO THE EXTENT POSSIBLE. ALL DISTURBED GROUND LEFT INACTIVE FOR MORE THAN 30 DAYS SHALL BE STABILIZED USING APPROPRIATE EROSION CONTROL MEASURES AND AN
- APPROPRIATE SEED MIX AS NOTED WITHIN THE FINAL APPROVED RESTORATION PLAN. 6. ALL VEGETATION, ADJACENT TO THE WORK AREA, MUST BE PROTECTED AND DELINEATED WITH CONSTRUCTION
- FENCING OR TREE PROTECTION BARRIERS. 7. ALL GRADES IN THE AREA REGULATED BY THE CONSERVATION AUTHORITY MUST BE MAINTAINED OR MATCHED,
- UNLESS OTHERWISE AUTHORIZED IN THE APPLICABLE PERMIT.

 8. AN AFTER-HOURS CONTACT NUMBER IS TO BE VISIBLY POSTED ONSITE FOR EMERGENCIES. ALL THE PLANS SHOULD HAVE NAME AND CONTACT INFO OF THE PERSON RESPONSIBLE FOR ESC MEASURES.

EROSION AND SEDIMENT CONTROL

- ALL TEMPORARY EROSION AND SEDIMENT CONTROL MEASURES MUST BE INSTALLED PRIOR TO START OF WORKS.
 FOLLOWING INSTALLATION OF THE PROPOSED ESC MEASURES, A QUALIFIED AGENT OF THE PROPONENT (E.G. CAN-CISEC CERTIFIED MONITOR) WILL CONDUCT REGULAR SITÉ VISITS TO MONITOR ALL WORKS, PARTICULARLY THE CONDITION OF THE ESC MEASURES, DEWATERING, AND IN- OR NEAR-WATER WORKS. SHOULD CONCERNS ARISE; THE ENVIRONMENTAL MONITOR WILL CONTACT THE PROPONENT, THE CONSERVATION AUTHORITY, AND
- ANY OTHER APPROPRIATE PARTIES. 3. EROSION AND SEDIMENT CONTROLS MUST BE MAINTAINED DURING CONSTRUCTION, AND ANY REQUIRED REPAIRS OR REPLACEMENTS MUST BE COMPLETED WITHIN 24 HOURS AFTER THEY HAVE BEEN IDENTIFIED DURING THE
- 4. EROSION AND SEDIMENT CONTROLS MAY REQUIRE PERIODIC ADJUSTMENTS TO REFLECT CHANGING SITE CONDITIONS. THE CONTRACTOR WILL BE RESPONSIBLE FOR THESE ADJUSTMENTS TO ENSURE PROPER
- 5. ANY CHANGES TO THE EROSION AND SEDIMENT CONTROL PLAN BEYOND MINOR ADJUSTMENTS MUST BE APPROVED BY THE CONTRACT ADMINISTRATOR.
- 6. ADDITIONAL EROSION AND SEDIMENT CONTROL SUPPLIES MUST BE KEPT ON SITE IN ORDER TO FACILITATE
- IMMEDIATE REPAIRS AND/OR UPGRADES AS NEEDED.

 7. ALL TEMPORARY SEDIMENT CONTROLS MUST BE REMOVED AFTER THE CONTRACT ADMINISTRATOR DEEMS THE 8. THE PROJECT PROPONENT OR THEIR REPRESENTATIVE IS ULTIMATELY RESPONSIBLE FOR CONTROLLING
- SEDIMENT AND EROSION WITHIN THE CONSTRUCTION SITE FOR THE TOTAL PERIOD OF THE CONSTRUCTION.
- 9. IF EXCESSIVE SILTATION RESULTS FROM THE CONSTRUCTION ACTIVITIES, THE ONSITE SUPERVISOR/INSPECTOR AND/OR THE LOCAL REGULATORY BODY RESERVE THE RIGHT TO REQUEST ADDITIONAL ESC MEASURES WHICH WOULD BE INSTALLED PRIOR TO FURTHER CONSTRUCTION ACTIVITIES.

DELETERIOUS SUBSTANCE CONTROL/SPILL MANAGEMENT

- 1. PREVENT THE RELEASE OF SEDIMENT, SEDIMENT-LADEN WATER, RAW CONCRETE, CONCRETE LEACHATE OR ANY OTHER DELETERIOUS SUBSTANCES INTO ANY WATERBODY, RAVINE OR STORM SEWER SYSTEM. 2. ENSURE EQUIPMENT AND MACHINERY ARE IN GOOD OPERATING CONDITION (POWER WASHED), FREE OF LEAKS, EXCESS OIL, AND GREASE.

 3. NO EQUIPMENT REFUELLING OR SERVICING SHOULD BE UNDERTAKEN WITHIN 30 m OF ANY WATERCOURSE OR
- SURFACE WATER DRAINAGE. A SPILL CONTAINMENT KIT MUST BE READILY ACCESSIBLE ON SITE IN THE EVENT OF A RELEASE OF A DELETERIOUS SUBSTANCE TO THE ENVIRONMENT. ONSITE STAFF MUST BE TRAINED IN ITS USE.
- 5. THE CONTRACT ADMINISTRATOR MUST BE NOTIFIED IMMEDIATELY IN THE EVENT OF A SPILL OF DELETERIOUS SUBSTANCE. ANY SEDIMENT SPILL FROM THE SITE SHOULD BE REPORTED TO MINISTRY OF ENVIRONMENT (SPILL ACTION CENTER) AT 1-800-268-6060.

WORK AREA ISOLATION

- 1. ALL WORK IN ISOLATED WORK AREAS MUST BE COMPLETED IN THE DRY. AN ADEQUATE NUMBER OF PUMPS MUST BE USED FOR UNWATERING.

 CROSSING AN ACTIVE WATERCOURSE OR WETLAND BY EQUIPMENT, VEHICLES, PERSONNEL, ETC. IS NOT
- PERMITTED UNLESS APPROVED BY THE CONSERVATION AUTHORITY. ALL ACCESS TO WORK SITES SHALL BE FROM
- EITHER SIDES OF THE WATERCOURSE OR WETLAND. 3. THE UNWATERING DISCHARGE LOCATION MUST BE LOCATED AT LEAST 30 M FROM ANY WATERCOURSE OR WETLAND IN AN AREA WITH DENSE VEGETATIVE GROUNDCOVER, AND WHERE THE DISCHARGE CAN RETURN TO THE WATERBODY DOWNSTREAM OF THE WORK AREA OVER THE GROUNDCOVER.
- 4. FISH MUST BE REMOVED FROM THE WORK AREA ONCE ISOLATED. FISH SALVAGE MUST BE COMPLETED BY A QUALIFIED TECHNICIAN WITH A LICENSE FROM THE ONTARIO MINISTRY OF NATURAL RESOURCES AND FORESTRY

		DATE	BY	REVISIONS
	DESIGNED BY: LD/AS DRAWN BY: AL/CP/SC			CHECKED BY: PV
				DATE: JUNE 2024

DRAFT FOR

INTERNAL DISCUSSION

 $M O R P H I X^{\mathsf{m}}$ 36 Main St N., P.O. Box 205

NOT FOR CONSTRUCTION

T: 416.920.0926 www.geomorphix.com


SHEET 10 OF 35


Campbellville, Ontario L0P 1B0

ALLOA SPA **TOWN OF CALEDON**

ETOBICOKE CREEK - ALLOA DRAIN CONCEPTUAL CHANNEL DESIGN CHANNEL PLANFORM

PROJECT No.: PN24009 DRAWING No.: GEO-9

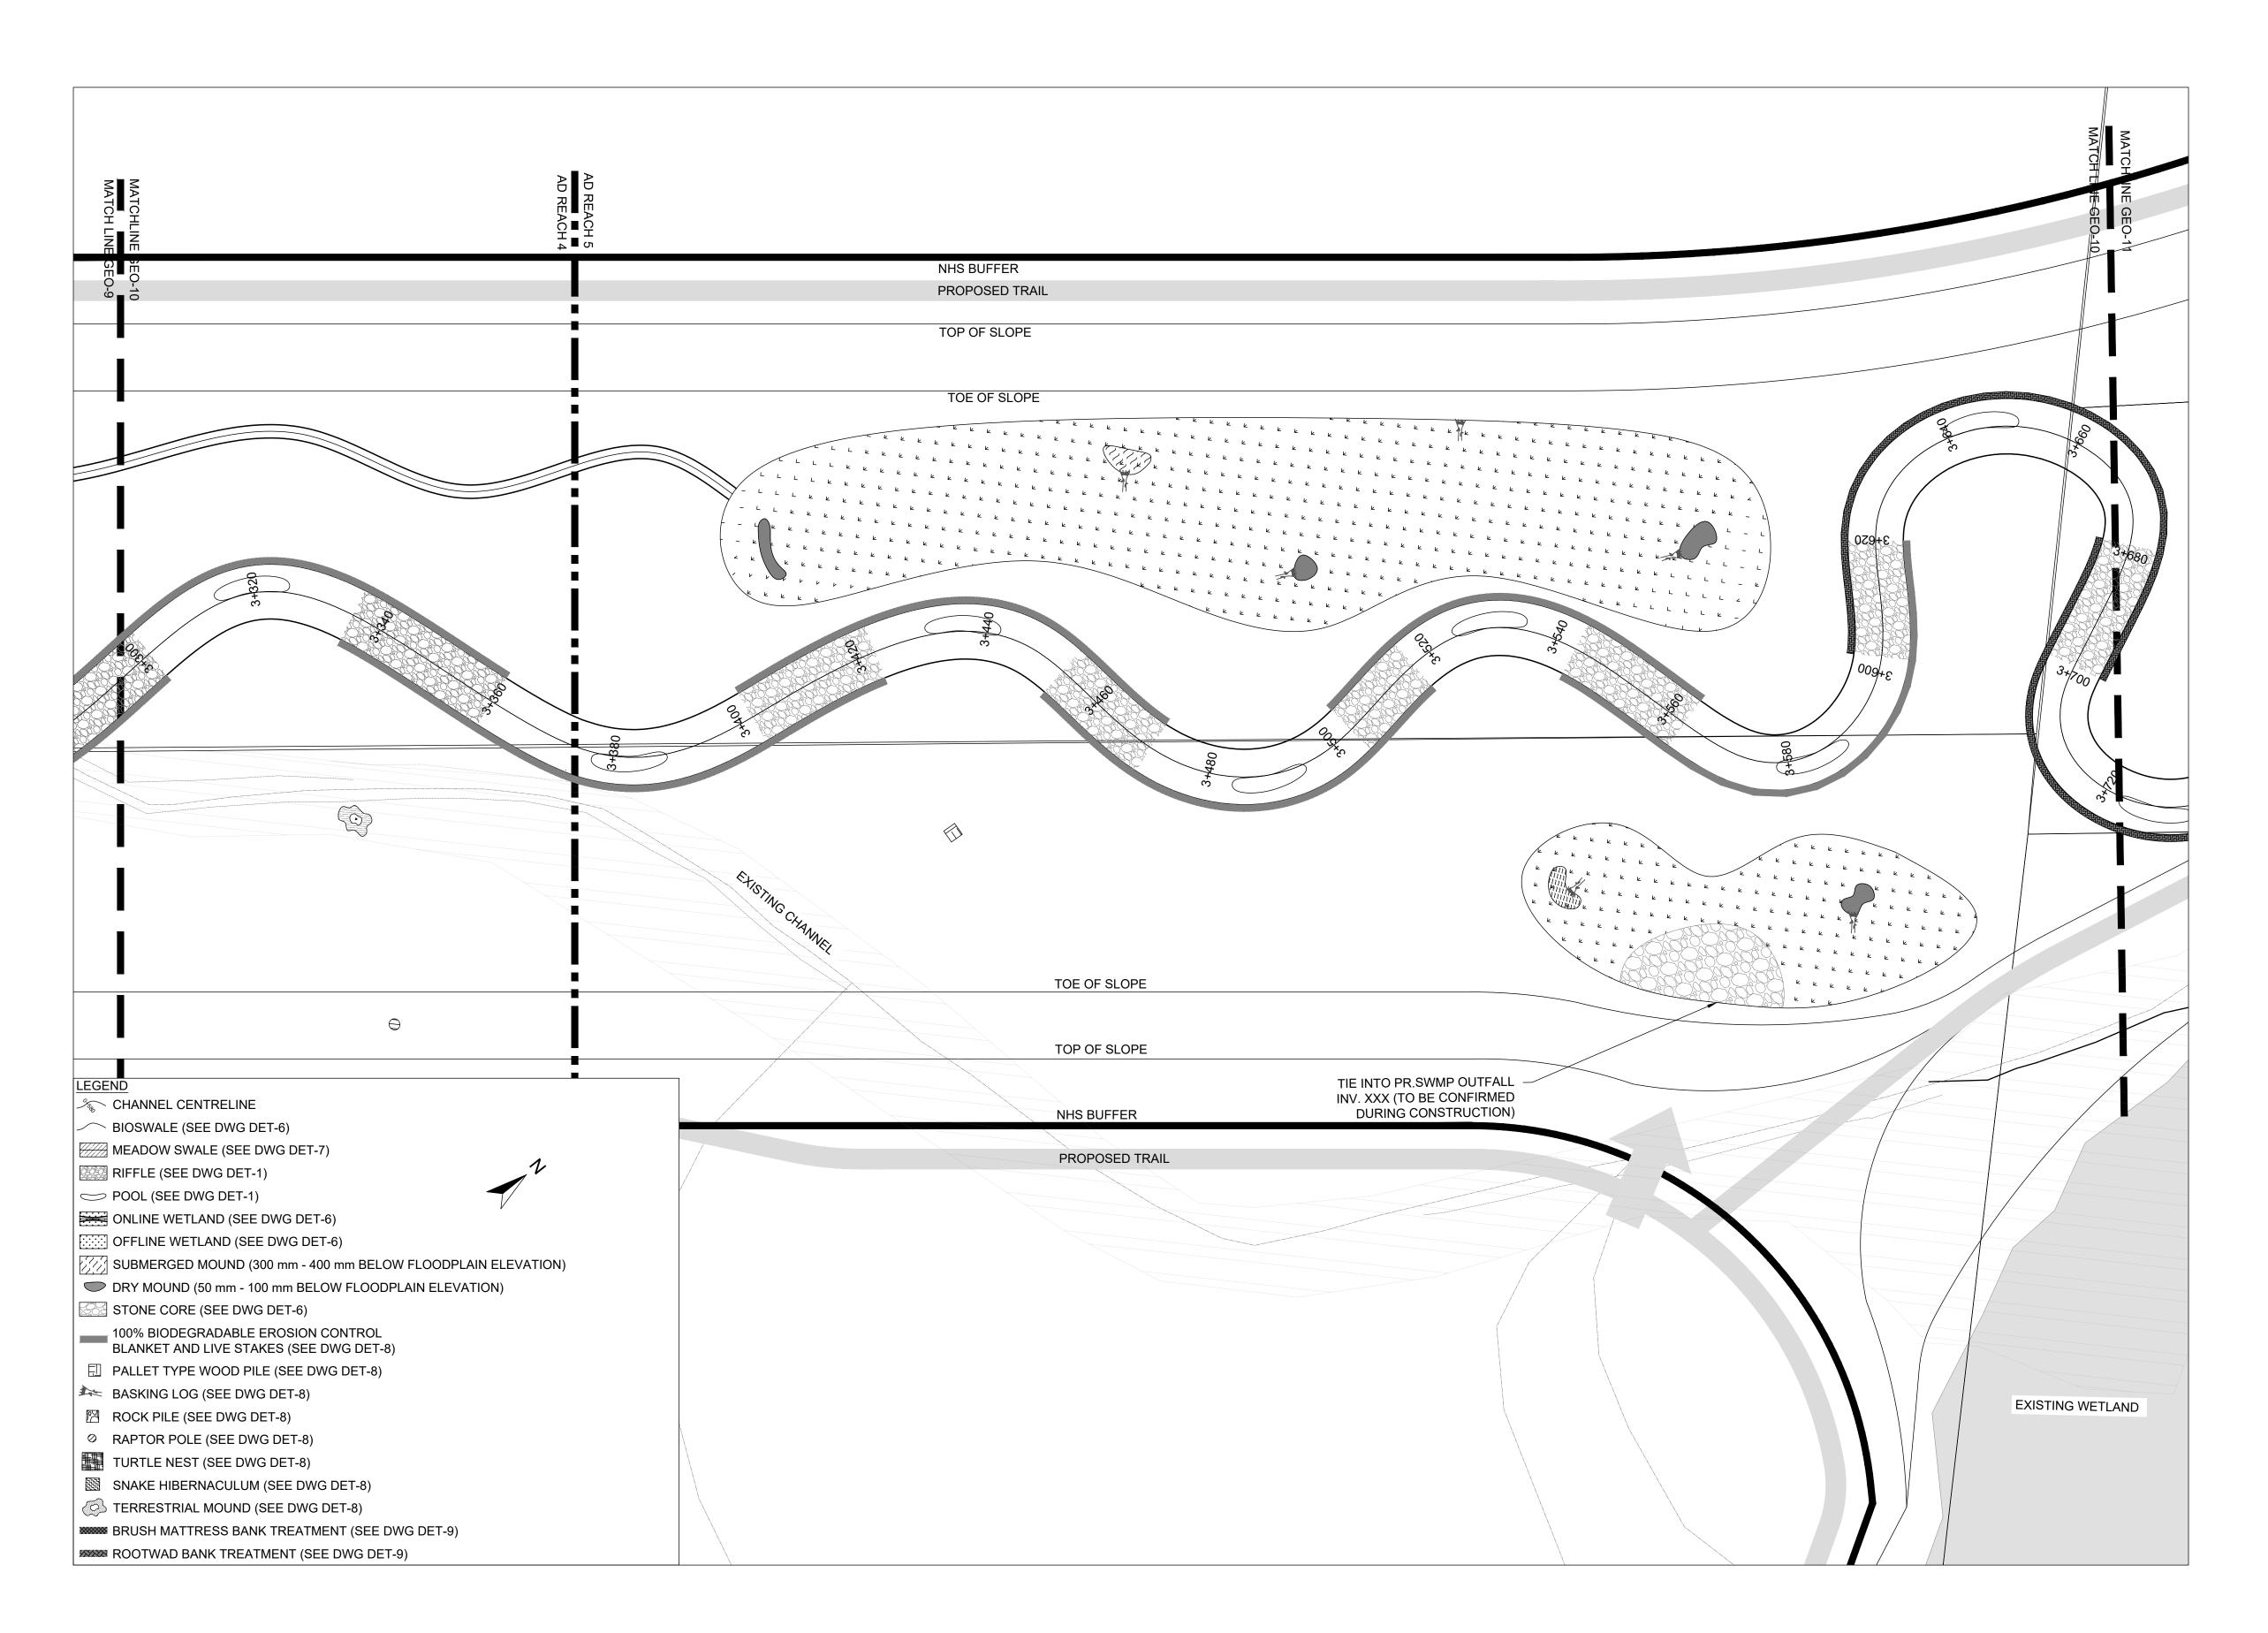

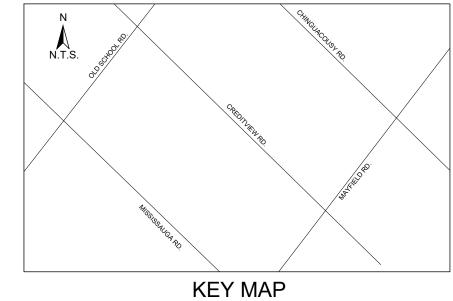

- 1. THE ACCOMPANYING CHANNEL REALIGNMENT TECHNICAL DESIGN BRIEF PREPARED BY GEO MORPHIX LTD. (2023) PROVIDES ADDITIONAL DESIGN DETAILS AND DIRECTION FOR IMPLEMENTATION AND IS TO BE REVIEWED IN CONJUNCTION WITH THIS DRAWING SET.
- 2. ALL CONTRACT DRAWINGS, SPECIFICATIONS AND APPLICABLE PERMITS MUST BE KEPT ON SITE DURING
- CONSTRUCTION FOR REFERENCE.

 3. THE CONTRACTOR MUST NOTIFY THE DESIGNER AND CONTRACT ADMINISTRATOR OF THE INTENT TO COMMENCE WORK AT LEAST 48 HOURS IN ADVANCE.
- 4. THE CONTRACTOR IS RESPONSIBLE FOR ALL UTILITY LOCATES.
 5. LAYOUT MUST BE REVIEWED AND APPROVED BY THE DESIGNER / DESIGNER REPRESENTATIVE, DESIGNATED
- ENGINEER, AND THE CONTRACT ADMINISTRATOR. CONSTRUCTION OBSERVATION IS TO BE PERFORMED BY A CERTIFIED FLUVIAL GEOMORPHOLOGIST OR EXPERIENCED ENVIRONMENTAL INSPECTOR UNDER DIRECTION FROM THE DESIGNER.
- 7. ON-SITE SUPPORT FROM PROJECT ENGINEER (E.G., GEOTECHNICAL, HYDROGEOLOGICAL, AND/OR WATER RESOURCES ENGINEER) REQUIRED TO ASSESS AND ENSURE FAVOURABLE SURFICIAL AND SUBSURFACE CONDITIONS TO SUPPORT CHANNEL REALIGNMENT CONSTRUCTION.
- 8. BE ADVISED THAT THE LOCAL REGULATORY BODY MAY, AT ANY TIME, WITHDRAW THIS PERMISSION, IF, IN THE OPINION OF THE AUTHORITY. THE CONDITIONS OF THE PERMIT ARE NOT BEING COMPLIED WITH. THIS APPROVAL DOES NOT EXEMPT THE PROPERTY OWNER/APPLICANT/AGENT FROM THE PROVISIONS OF ANY OTHER FEDERAL. PROVINCIAL OR MUNICIPAL STATUTES, REGULATIONS OR BY-LAWS, OR ANY RIGHTS UNDER COMMON LAW.

TIMING OF WORKS

- 1. WORKS SHALL BE COMPLETED DURING THE DESIGNATED IN-WATER WORKS WINDOW SET OUT BY MNRF/DFO. TREE CLEARING IS TO BE COMPLETED OUTSIDE THE BIRD NESTING SEASON (APRIL 1ST TO AUGUST 1ST) TO COMPLY WITH THE FEDERAL MIGRATORY BIRDS CONVENTION ACT. ANY TREES THAT REQUIRE REMOVAL OUTSIDE
- OF THIS TIMING WINDOW MUST FIRST BE INSPECTED BY A QUALIFIED BIOLOGIST TO DETERMINE THE PRESENCE OF 3. THE WEATHER FORECAST SHOULD BE CONTINUALLY MONITORED TO ENSURE THAT WORKS ARE UNDERTAKEN
- ONLY DURING FAVOURABLE WEATHER CONDITIONS 4. COMPLETE THE WORKS WITH MINIMAL AVOIDABLE INTERRUPTIONS ONCE THEY COMMENCE.

SITE AND MATERIAL MANAGEMENT

- 1. ALL CONSTRUCTION EQUIPMENT AND MATERIALS (IMPORTED OR EXCAVATED) MUST BE STORED AT LEAST 30 m
- AWAY FROM ANY WATERBODY IN A STABLE AREA ABOVE THE ACTIVE FLOODPLAIN, OR IN A DESIGNATED
- 2. IN THE EVENT OF AN UNEXPECTED STORM, ALL UNFIXED ITEMS THAT HAVE THE POTENTIAL TO CAUSE A SPILL OR AN OBSTRUCTION TO FLOW MUST BE MOVED A STABLE AREA ABOVE ACTIVE FLOODPLAIN. 3. STOCKPILES MUST BE LOCATED OUTSIDE THE ISOLATED WORK AREAS.
- 4. STABILIZE, TEMPORARILY OR PERMANENTLY, ANY DISTURBED AREAS AS WORK PROGRESSES, OR SOON AS CONDITIONS ALLOW. 5. MINIMIZE THE AREA OF DISTURBANCE TO THE EXTENT POSSIBLE. ALL DISTURBED GROUND LEFT INACTIVE FOR
- MORE THAN 30 DAYS SHALL BE STABILIZED USING APPROPRIATE EROSION CONTROL MEASURES AND AN APPROPRIATE SEED MIX AS NOTED WITHIN THE FINAL APPROVED RESTORATION PLAN.
- 6. ALL VEGETATION, ADJACENT TO THE WORK AREA, MUST BE PROTECTED AND DELINEATED WITH CONSTRUCTION FENCING OR TREE PROTECTION BARRIERS.
- 7. ALL GRADES IN THE AREA REGULATED BY THE CONSERVATION AUTHORITY MUST BE MAINTAINED OR MATCHED,
- UNLESS OTHERWISE AUTHORIZED IN THE APPLICABLE PERMIT.

 8. AN AFTER-HOURS CONTACT NUMBER IS TO BE VISIBLY POSTED ONSITE FOR EMERGENCIES. ALL THE PLANS SHOULD HAVE NAME AND CONTACT INFO OF THE PERSON RESPONSIBLE FOR ESC MEASURES.

EROSION AND SEDIMENT CONTROL

- 1. ALL TEMPORARY EROSION AND SEDIMENT CONTROL MEASURES MUST BE INSTALLED PRIOR TO START OF WORKS. 2. FOLLOWING INSTALLATION OF THE PROPOSED ESC MEASURES, A QUALIFIED AGENT OF THE PROPONENT (E.G. CAN-CISEC CERTIFIED MONITOR) WILL CONDUCT REGULAR SITÉ VISITS TO MONITOR ALL WORKS, PARTICULARLY THE CONDITION OF THE ESC MEASURES, DEWATERING, AND IN- OR NEAR-WATER WORKS. SHOULD CONCERNS ARISE; THE ENVIRONMENTAL MONITOR WILL CONTACT THE PROPONENT, THE CONSERVATION AUTHORITY, AND
- ANY OTHER APPROPRIATE PARTIES. 3. EROSION AND SEDIMENT CONTROLS MUST BE MAINTAINED DURING CONSTRUCTION, AND ANY REQUIRED REPAIRS OR REPLACEMENTS MUST BE COMPLETED WITHIN 24 HOURS AFTER THEY HAVE BEEN IDENTIFIED DURING THE
- 4. EROSION AND SEDIMENT CONTROLS MAY REQUIRE PERIODIC ADJUSTMENTS TO REFLECT CHANGING SITE CONDITIONS. THE CONTRACTOR WILL BE RESPONSIBLE FOR THESE ADJUSTMENTS TO ENSURE PROPER
- 5. ANY CHANGES TO THE EROSION AND SEDIMENT CONTROL PLAN BEYOND MINOR ADJUSTMENTS MUST BE APPROVED BY THE CONTRACT ADMINISTRATOR.
- 6. ADDITIONAL EROSION AND SEDIMENT CONTROL SUPPLIES MUST BE KEPT ON SITE IN ORDER TO FACILITATE IMMEDIATE REPAIRS AND/OR UPGRADES AS NEEDED.
- 7. ALL TEMPORARY SEDIMENT CONTROLS MUST BE REMOVED AFTER THE CONTRACT ADMINISTRATOR DEEMS THE 8. THE PROJECT PROPONENT OR THEIR REPRESENTATIVE IS ULTIMATELY RESPONSIBLE FOR CONTROLLING
- SEDIMENT AND EROSION WITHIN THE CONSTRUCTION SITE FOR THE TOTAL PERIOD OF THE CONSTRUCTION.
- 9. IF EXCESSIVE SILTATION RESULTS FROM THE CONSTRUCTION ACTIVITIES, THE ONSITE SUPERVISOR/INSPECTOR AND/OR THE LOCAL REGULATORY BODY RESERVE THE RIGHT TO REQUEST ADDITIONAL ESC MEASURES WHICH WOULD BE INSTALLED PRIOR TO FURTHER CONSTRUCTION ACTIVITIES.

DELETERIOUS SUBSTANCE CONTROL/SPILL MANAGEMENT

- 1. PREVENT THE RELEASE OF SEDIMENT, SEDIMENT-LADEN WATER, RAW CONCRETE, CONCRETE LEACHATE OR ANY OTHER DELETERIOUS SUBSTANCES INTO ANY WATERBODY, RAVINE OR STORM SEWER SYSTEM. 2. ENSURE EQUIPMENT AND MACHINERY ARE IN GOOD OPERATING CONDITION (POWER WASHED), FREE OF LEAKS, EXCESS OIL, AND GREASE.

 3. NO EQUIPMENT REFUELLING OR SERVICING SHOULD BE UNDERTAKEN WITHIN 30 m OF ANY WATERCOURSE OR
- SURFACE WATER DRAINAGE. 4. A SPILL CONTAINMENT KIT MUST BE READILY ACCESSIBLE ON SITE IN THE EVENT OF A RELEASE OF A DELETERIOUS SUBSTANCE TO THE ENVIRONMENT. ONSITE STAFF MUST BE TRAINED IN ITS USE.
- 5. THE CONTRACT ADMINISTRATOR MUST BE NOTIFIED IMMEDIATELY IN THE EVENT OF A SPILL OF DELETERIOUS SUBSTANCE. ANY SEDIMENT SPILL FROM THE SITE SHOULD BE REPORTED TO MINISTRY OF ENVIRONMENT (SPILL ACTION CENTER) AT 1-800-268-6060.

WORK AREA ISOLATION

- 1. ALL WORK IN ISOLATED WORK AREAS MUST BE COMPLETED IN THE DRY. AN ADEQUATE NUMBER OF PUMPS MUST BE USED FOR UNWATERING.
 2. CROSSING AN ACTIVE WATERCOURSE OR WETLAND BY EQUIPMENT, VEHICLES, PERSONNEL, ETC. IS NOT
- PERMITTED UNLESS APPROVED BY THE CONSERVATION AUTHORITY. ALL ACCESS TO WORK SITES SHALL BE FROM EITHER SIDES OF THE WATERCOURSE OR WETLAND.
- 3. THE UNWATERING DISCHARGE LOCATION MUST BE LOCATED AT LEAST 30 M FROM ANY WATERCOURSE OR WETLAND IN AN AREA WITH DENSE VEGETATIVE GROUNDCOVER, AND WHERE THE DISCHARGE CAN RETURN TO THE WATERBODY DOWNSTREAM OF THE WORK AREA OVER THE GROUNDCOVER.
- 4. FISH MUST BE REMOVED FROM THE WORK AREA ONCE ISOLATED. FISH SALVAGE MUST BE COMPLETED BY A QUALIFIED TECHNICIAN WITH A LICENSE FROM THE ONTARIO MINISTRY OF NATURAL RESOURCES AND FORESTRY

	DATE	BY	REVISIONS
DESIG	GNED BY: LD/A	\S	CHECKED BY: PV

DRAWN BY: AL/CP/SC DATE: JUNE 2024

DRAFT FOR **INTERNAL** DISCUSSION $M O R P H I X^{\mathsf{m}}$

NOT FOR CONSTRUCTION


36 Main St N., P.O. Box 205 Campbellville, Ontario L0P 1B0 T: 416.920.0926 www.geomorphix.com


ALLOA SPA **TOWN OF CALEDON**

ETOBICOKE CREEK - ALLOA DRAIN

CONCEPTUAL CHANNEL DESIGN CHANNEL PLANFORM

PROJECT No.: PN24009 DRAWING No.:GEO-10 SCALE: AS NOTED SHEET 11 OF 35

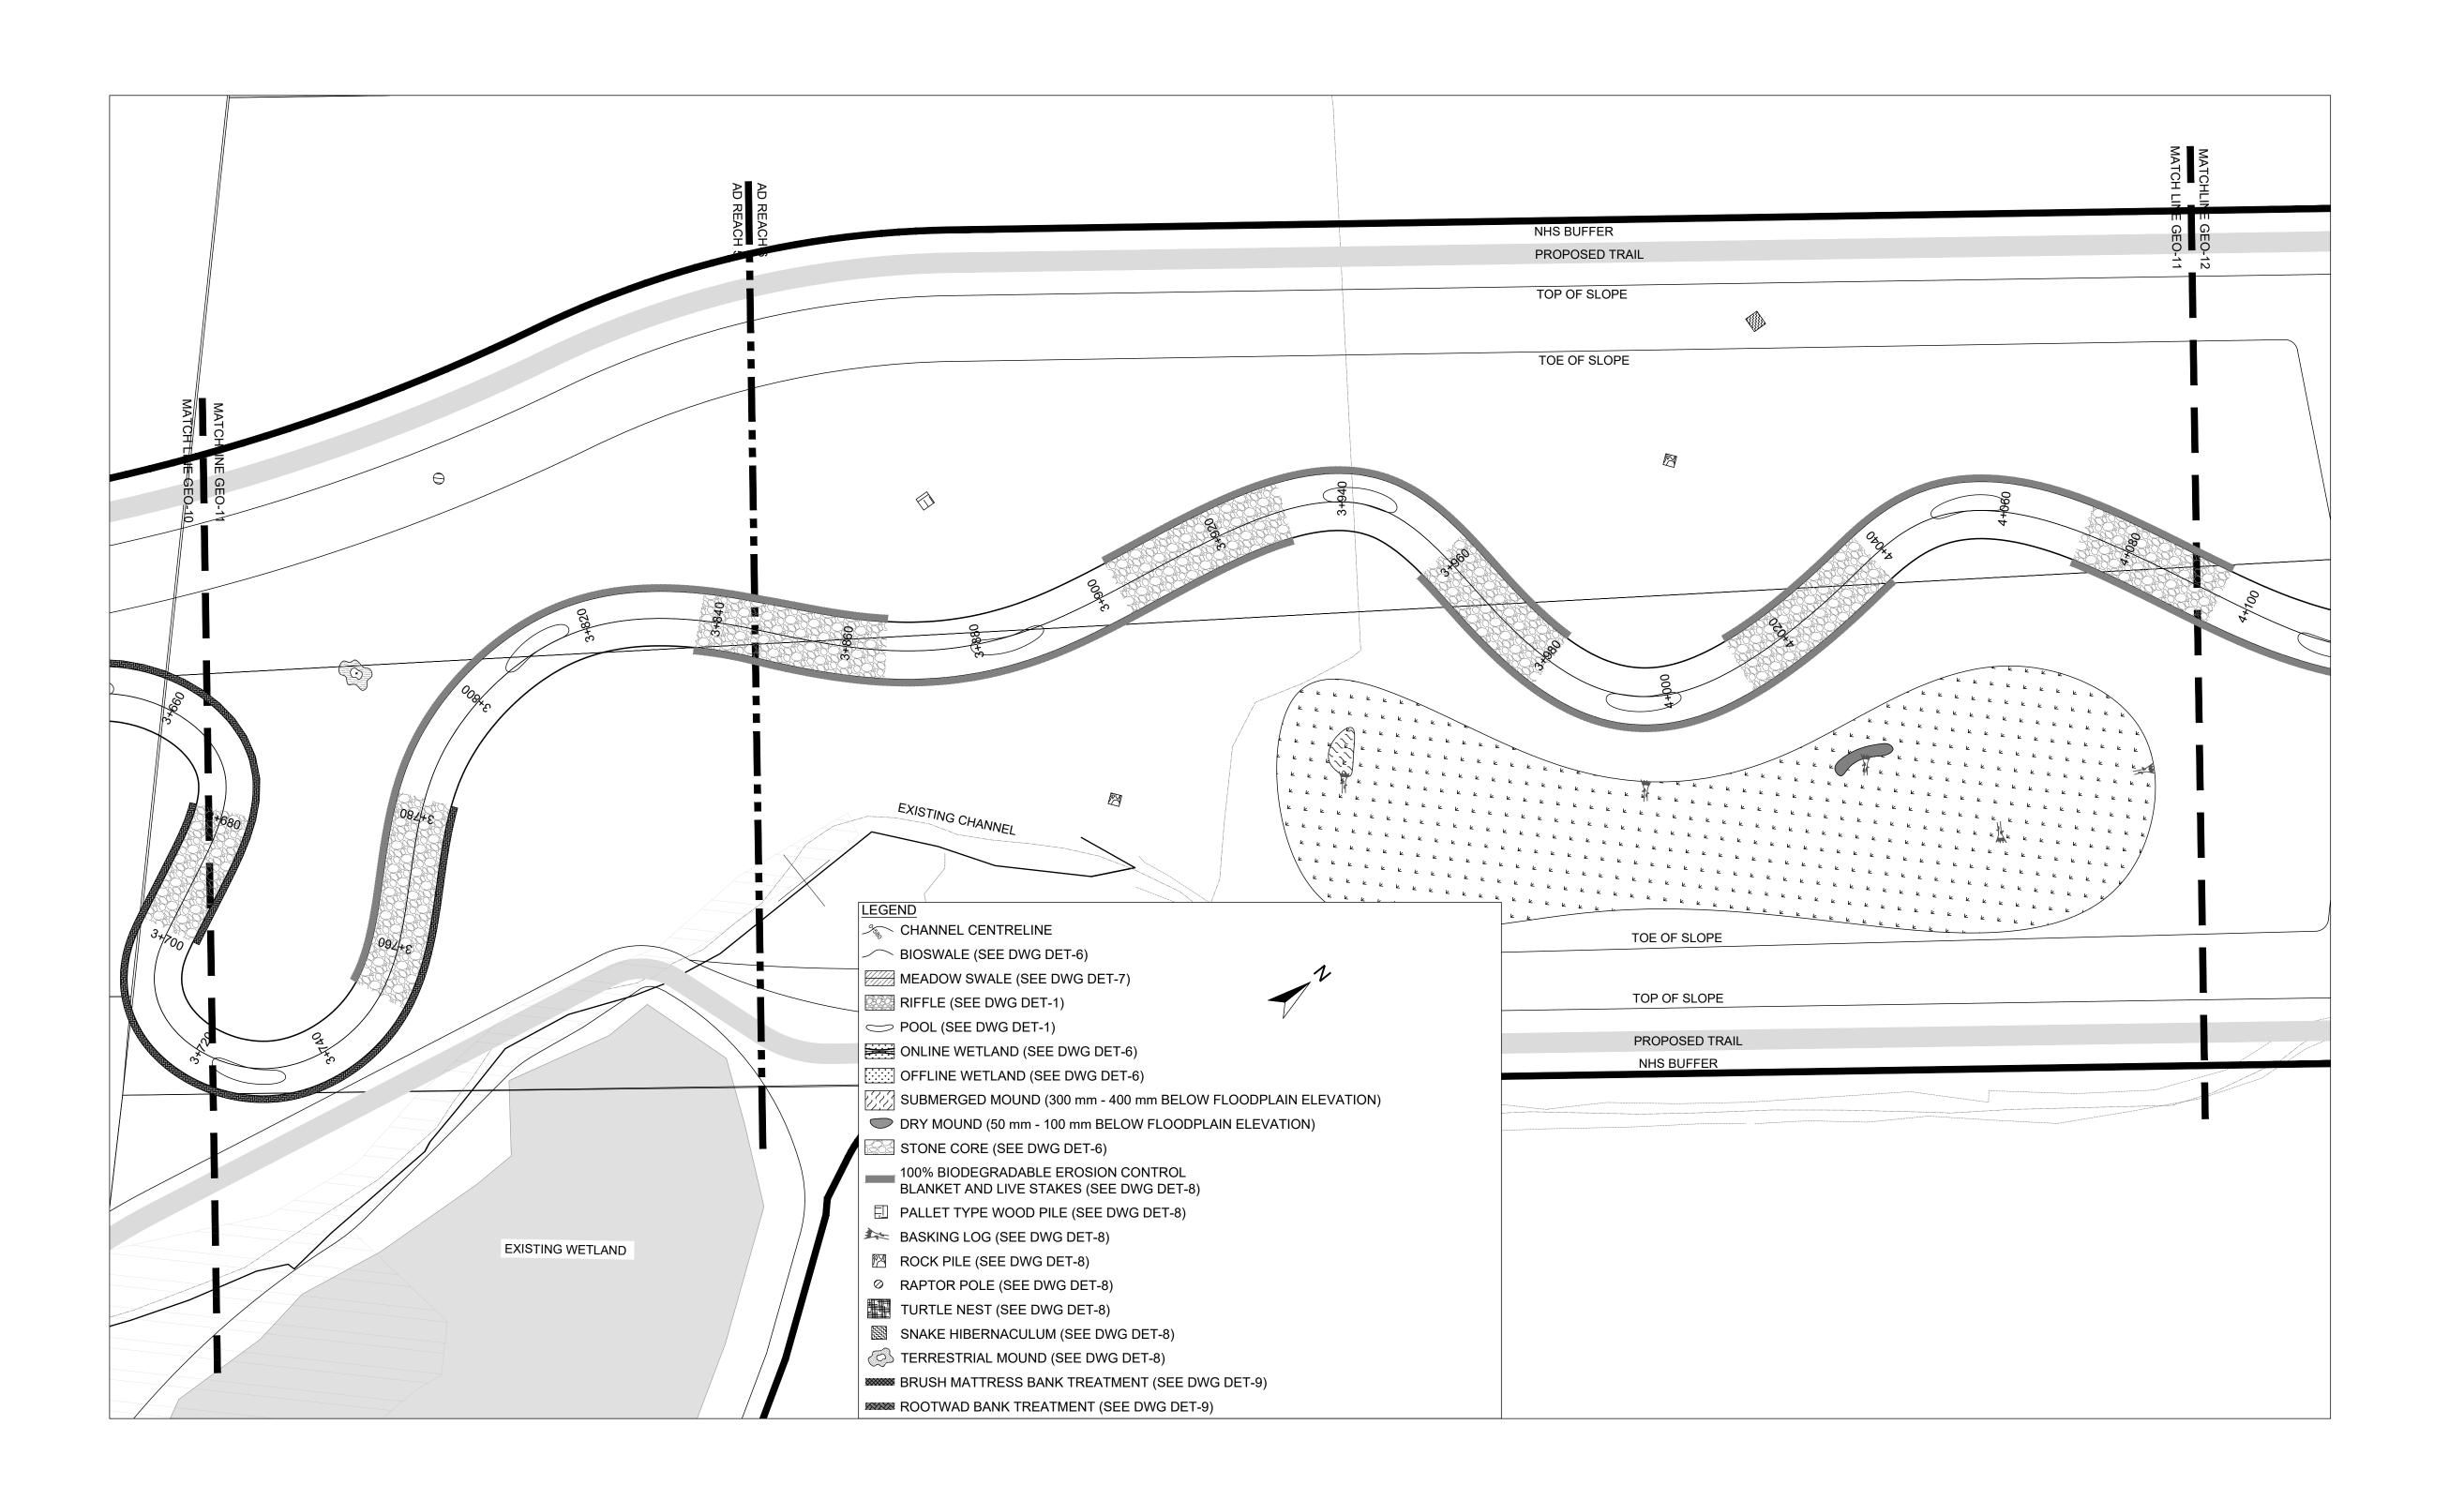

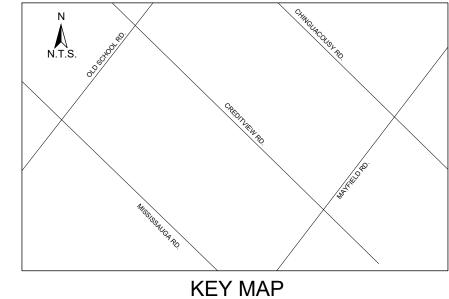

1. THE ACCOMPANYING CHANNEL REALIGNMENT TECHNICAL DESIGN BRIEF PREPARED BY GEO MORPHIX LTD. (2023)

PROVIDES ADDITIONAL DESIGN DETAILS AND DIRECTION FOR IMPLEMENTATION AND IS TO BE REVIEWED IN CONJUNCTION WITH THIS DRAWING SET. 2. ALL CONTRACT DRAWINGS, SPECIFICATIONS AND APPLICABLE PERMITS MUST BE KEPT ON SITE DURING

CONSTRUCTION FOR REFERENCE.

3. THE CONTRACTOR MUST NOTIFY THE DESIGNER AND CONTRACT ADMINISTRATOR OF THE INTENT TO COMMENCE WORK AT LEAST 48 HOURS IN ADVANCE.

4. THE CONTRACTOR IS RESPONSIBLE FOR ALL UTILITY LOCATES.
5. LAYOUT MUST BE REVIEWED AND APPROVED BY THE DESIGNER / DESIGNER REPRESENTATIVE, DESIGNATED

ENGINEER, AND THE CONTRACT ADMINISTRATOR.

 CONSTRUCTION OBSERVATION IS TO BE PERFORMED BY A CERTIFIED FLUVIAL GEOMORPHOLOGIST OR EXPERIENCED ENVIRONMENTAL INSPECTOR UNDER DIRECTION FROM THE DESIGNER. 7. ON-SITE SUPPORT FROM PROJECT ENGINEER (E.G., GEOTECHNICAL, HYDROGEOLOGICAL, AND/OR WATER

RESOURCES ENGINEER) REQUIRED TO ASSESS AND ENSURE FAVOURABLE SURFICIAL AND SUBSURFACE CONDITIONS TO SUPPORT CHANNEL REALIGNMENT CONSTRUCTION. 8. BE ADVISED THAT THE LOCAL REGULATORY BODY MAY, AT ANY TIME, WITHDRAW THIS PERMISSION, IF, IN THE

OPINION OF THE AUTHORITY. THE CONDITIONS OF THE PERMIT ARE NOT BEING COMPLIED WITH. THIS APPROVAL DOES NOT EXEMPT THE PROPERTY OWNER/APPLICANT/AGENT FROM THE PROVISIONS OF ANY OTHER FEDERAL, PROVINCIAL OR MUNICIPAL STATUTES, REGULATIONS OR BY-LAWS, OR ANY RIGHTS UNDER COMMON LAW.

TIMING OF WORKS

1. WORKS SHALL BE COMPLETED DURING THE DESIGNATED IN-WATER WORKS WINDOW SET OUT BY MNRF/DFO. TREE CLEARING IS TO BE COMPLETED OUTSIDE THE BIRD NESTING SEASON (APRIL 1ST TO AUGUST 1ST) TO COMPLY WITH THE FEDERAL MIGRATORY BIRDS CONVENTION ACT. ANY TREES THAT REQUIRE REMOVAL OUTSIDE OF THIS TIMING WINDOW MUST FIRST BE INSPECTED BY A QUALIFIED BIOLOGIST TO DETERMINE THE PRESENCE OF

3. THE WEATHER FORECAST SHOULD BE CONTINUALLY MONITORED TO ENSURE THAT WORKS ARE UNDERTAKEN

ONLY DURING FAVOURABLE WEATHER CONDITIONS 4. COMPLETE THE WORKS WITH MINIMAL AVOIDABLE INTERRUPTIONS ONCE THEY COMMENCE.

SITE AND MATERIAL MANAGEMENT

1. ALL CONSTRUCTION EQUIPMENT AND MATERIALS (IMPORTED OR EXCAVATED) MUST BE STORED AT LEAST 30 m AWAY FROM ANY WATERBODY IN A STABLE AREA ABOVE THE ACTIVE FLOODPLAIN, OR IN A DESIGNATED

2. IN THE EVENT OF AN UNEXPECTED STORM, ALL UNFIXED ITEMS THAT HAVE THE POTENTIAL TO CAUSE A SPILL OR AN OBSTRUCTION TO FLOW MUST BE MOVED A STABLE AREA ABOVE ACTIVE FLOODPLAIN.

3. STOCKPILES MUST BE LOCATED OUTSIDE THE ISOLATED WORK AREAS. 4. STABILIZE, TEMPORARILY OR PERMANENTLY, ANY DISTURBED AREAS AS WORK PROGRESSES, OR SOON AS

CONDITIONS ALLOW. 5. MINIMIZE THE AREA OF DISTURBANCE TO THE EXTENT POSSIBLE. ALL DISTURBED GROUND LEFT INACTIVE FOR MORE THAN 30 DAYS SHALL BE STABILIZED USING APPROPRIATE EROSION CONTROL MEASURES AND AN

APPROPRIATE SEED MIX AS NOTED WITHIN THE FINAL APPROVED RESTORATION PLAN. 6. ALL VEGETATION, ADJACENT TO THE WORK AREA, MUST BE PROTECTED AND DELINEATED WITH CONSTRUCTION

FENCING OR TREE PROTECTION BARRIERS. 7. ALL GRADES IN THE AREA REGULATED BY THE CONSERVATION AUTHORITY MUST BE MAINTAINED OR MATCHED,

UNLESS OTHERWISE AUTHORIZED IN THE APPLICABLE PERMIT.

8. AN AFTER-HOURS CONTACT NUMBER IS TO BE VISIBLY POSTED ONSITE FOR EMERGENCIES. ALL THE PLANS SHOULD HAVE NAME AND CONTACT INFO OF THE PERSON RESPONSIBLE FOR ESC MEASURES.

EROSION AND SEDIMENT CONTROL

 ALL TEMPORARY EROSION AND SEDIMENT CONTROL MEASURES MUST BE INSTALLED PRIOR TO START OF WORKS.
 FOLLOWING INSTALLATION OF THE PROPOSED ESC MEASURES, A QUALIFIED AGENT OF THE PROPONENT (E.G. CAN-CISEC CERTIFIED MONITOR) WILL CONDUCT REGULAR SITÉ VISITS TO MONITOR ALL WORKS, PARTICULARLY THE CONDITION OF THE ESC MEASURES, DEWATERING, AND IN- OR NEAR-WATER WORKS. SHOULD CONCERNS ARISE; THE ENVIRONMENTAL MONITOR WILL CONTACT THE PROPONENT, THE CONSERVATION AUTHORITY, AND

3. EROSION AND SEDIMENT CONTROLS MUST BE MAINTAINED DURING CONSTRUCTION, AND ANY REQUIRED REPAIRS OR REPLACEMENTS MUST BE COMPLETED WITHIN 24 HOURS AFTER THEY HAVE BEEN IDENTIFIED DURING THE

4. EROSION AND SEDIMENT CONTROLS MAY REQUIRE PERIODIC ADJUSTMENTS TO REFLECT CHANGING SITE CONDITIONS. THE CONTRACTOR WILL BE RESPONSIBLE FOR THESE ADJUSTMENTS TO ENSURE PROPER

5. ANY CHANGES TO THE EROSION AND SEDIMENT CONTROL PLAN BEYOND MINOR ADJUSTMENTS MUST BE APPROVED BY THE CONTRACT ADMINISTRATOR.

6. ADDITIONAL EROSION AND SEDIMENT CONTROL SUPPLIES MUST BE KEPT ON SITE IN ORDER TO FACILITATE IMMEDIATE REPAIRS AND/OR UPGRADES AS NEEDED.

7. ALL TEMPORARY SEDIMENT CONTROLS MUST BE REMOVED AFTER THE CONTRACT ADMINISTRATOR DEEMS THE 8. THE PROJECT PROPONENT OR THEIR REPRESENTATIVE IS ULTIMATELY RESPONSIBLE FOR CONTROLLING

SEDIMENT AND EROSION WITHIN THE CONSTRUCTION SITE FOR THE TOTAL PERIOD OF THE CONSTRUCTION. 9. IF EXCESSIVE SILTATION RESULTS FROM THE CONSTRUCTION ACTIVITIES, THE ONSITE SUPERVISOR/INSPECTOR AND/OR THE LOCAL REGULATORY BODY RESERVE THE RIGHT TO REQUEST ADDITIONAL ESC MEASURES WHICH WOULD BE INSTALLED PRIOR TO FURTHER CONSTRUCTION ACTIVITIES.

DELETERIOUS SUBSTANCE CONTROL/SPILL MANAGEMENT

 PREVENT THE RELEASE OF SEDIMENT, SEDIMENT-LADEN WATER, RAW CONCRETE, CONCRETE LEACHATE OR ANY OTHER DELETERIOUS SUBSTANCES INTO ANY WATERBODY, RAVINE OR STORM SEWER SYSTEM. 2. ENSURE EQUIPMENT AND MACHINERY ARE IN GOOD OPERATING CONDITION (POWER WASHED), FREE OF LEAKS, EXCESS OIL, AND GREASE.

3. NO EQUIPMENT REFUELLING OR SERVICING SHOULD BE UNDERTAKEN WITHIN 30 m OF ANY WATERCOURSE OR

SURFACE WATER DRAINAGE. A SPILL CONTAINMENT KIT MUST BE READILY ACCESSIBLE ON SITE IN THE EVENT OF A RELEASE OF A DELETERIOUS SUBSTANCE TO THE ENVIRONMENT. ONSITE STAFF MUST BE TRAINED IN ITS USE.

5. THE CONTRACT ADMINISTRATOR MUST BE NOTIFIED IMMEDIATELY IN THE EVENT OF A SPILL OF DELETERIOUS SUBSTANCE. ANY SEDIMENT SPILL FROM THE SITE SHOULD BE REPORTED TO MINISTRY OF ENVIRONMENT (SPILL ACTION CENTER) AT 1-800-268-6060.

WORK AREA ISOLATION

1. ALL WORK IN ISOLATED WORK AREAS MUST BE COMPLETED IN THE DRY. AN ADEQUATE NUMBER OF PUMPS MUST BE USED FOR UNWATERING.
2. CROSSING AN ACTIVE WATERCOURSE OR WETLAND BY EQUIPMENT, VEHICLES, PERSONNEL, ETC. IS NOT

PERMITTED UNLESS APPROVED BY THE CONSERVATION AUTHORITY. ALL ACCESS TO WORK SITES SHALL BE FROM

EITHER SIDES OF THE WATERCOURSE OR WETLAND. 3. THE UNWATERING DISCHARGE LOCATION MUST BE LOCATED AT LEAST 30 M FROM ANY WATERCOURSE OR WETLAND IN AN AREA WITH DENSE VEGETATIVE GROUNDCOVER, AND WHERE THE DISCHARGE CAN RETURN TO

THE WATERBODY DOWNSTREAM OF THE WORK AREA OVER THE GROUNDCOVER. 4. FISH MUST BE REMOVED FROM THE WORK AREA ONCE ISOLATED. FISH SALVAGE MUST BE COMPLETED BY A QUALIFIED TECHNICIAN WITH A LICENSE FROM THE ONTARIO MINISTRY OF NATURAL RESOURCES AND FORESTRY

DATE BY **REVISIONS** CHECKED BY: PV DESIGNED BY: LD/AS

DRAFT FOR INTERNAL DISCUSSION

DRAWN BY: AL/CP/SC

 $M O R P H I X^{\mathsf{m}}$

DATE: JUNE 2024


NOT FOR CONSTRUCTION


36 Main St N., P.O. Box 205 Campbellville, Ontario L0P 1B0 T: 416.920.0926 www.geomorphix.com

ALLOA SPA TOWN OF CALEDON

ETOBICOKE CREEK - ALLOA DRAIN CONCEPTUAL CHANNEL DESIGN CHANNEL PLANFORM

PROJECT No.: PN24009 DRAWING No.:GEO-11 SHEET 12 OF 35

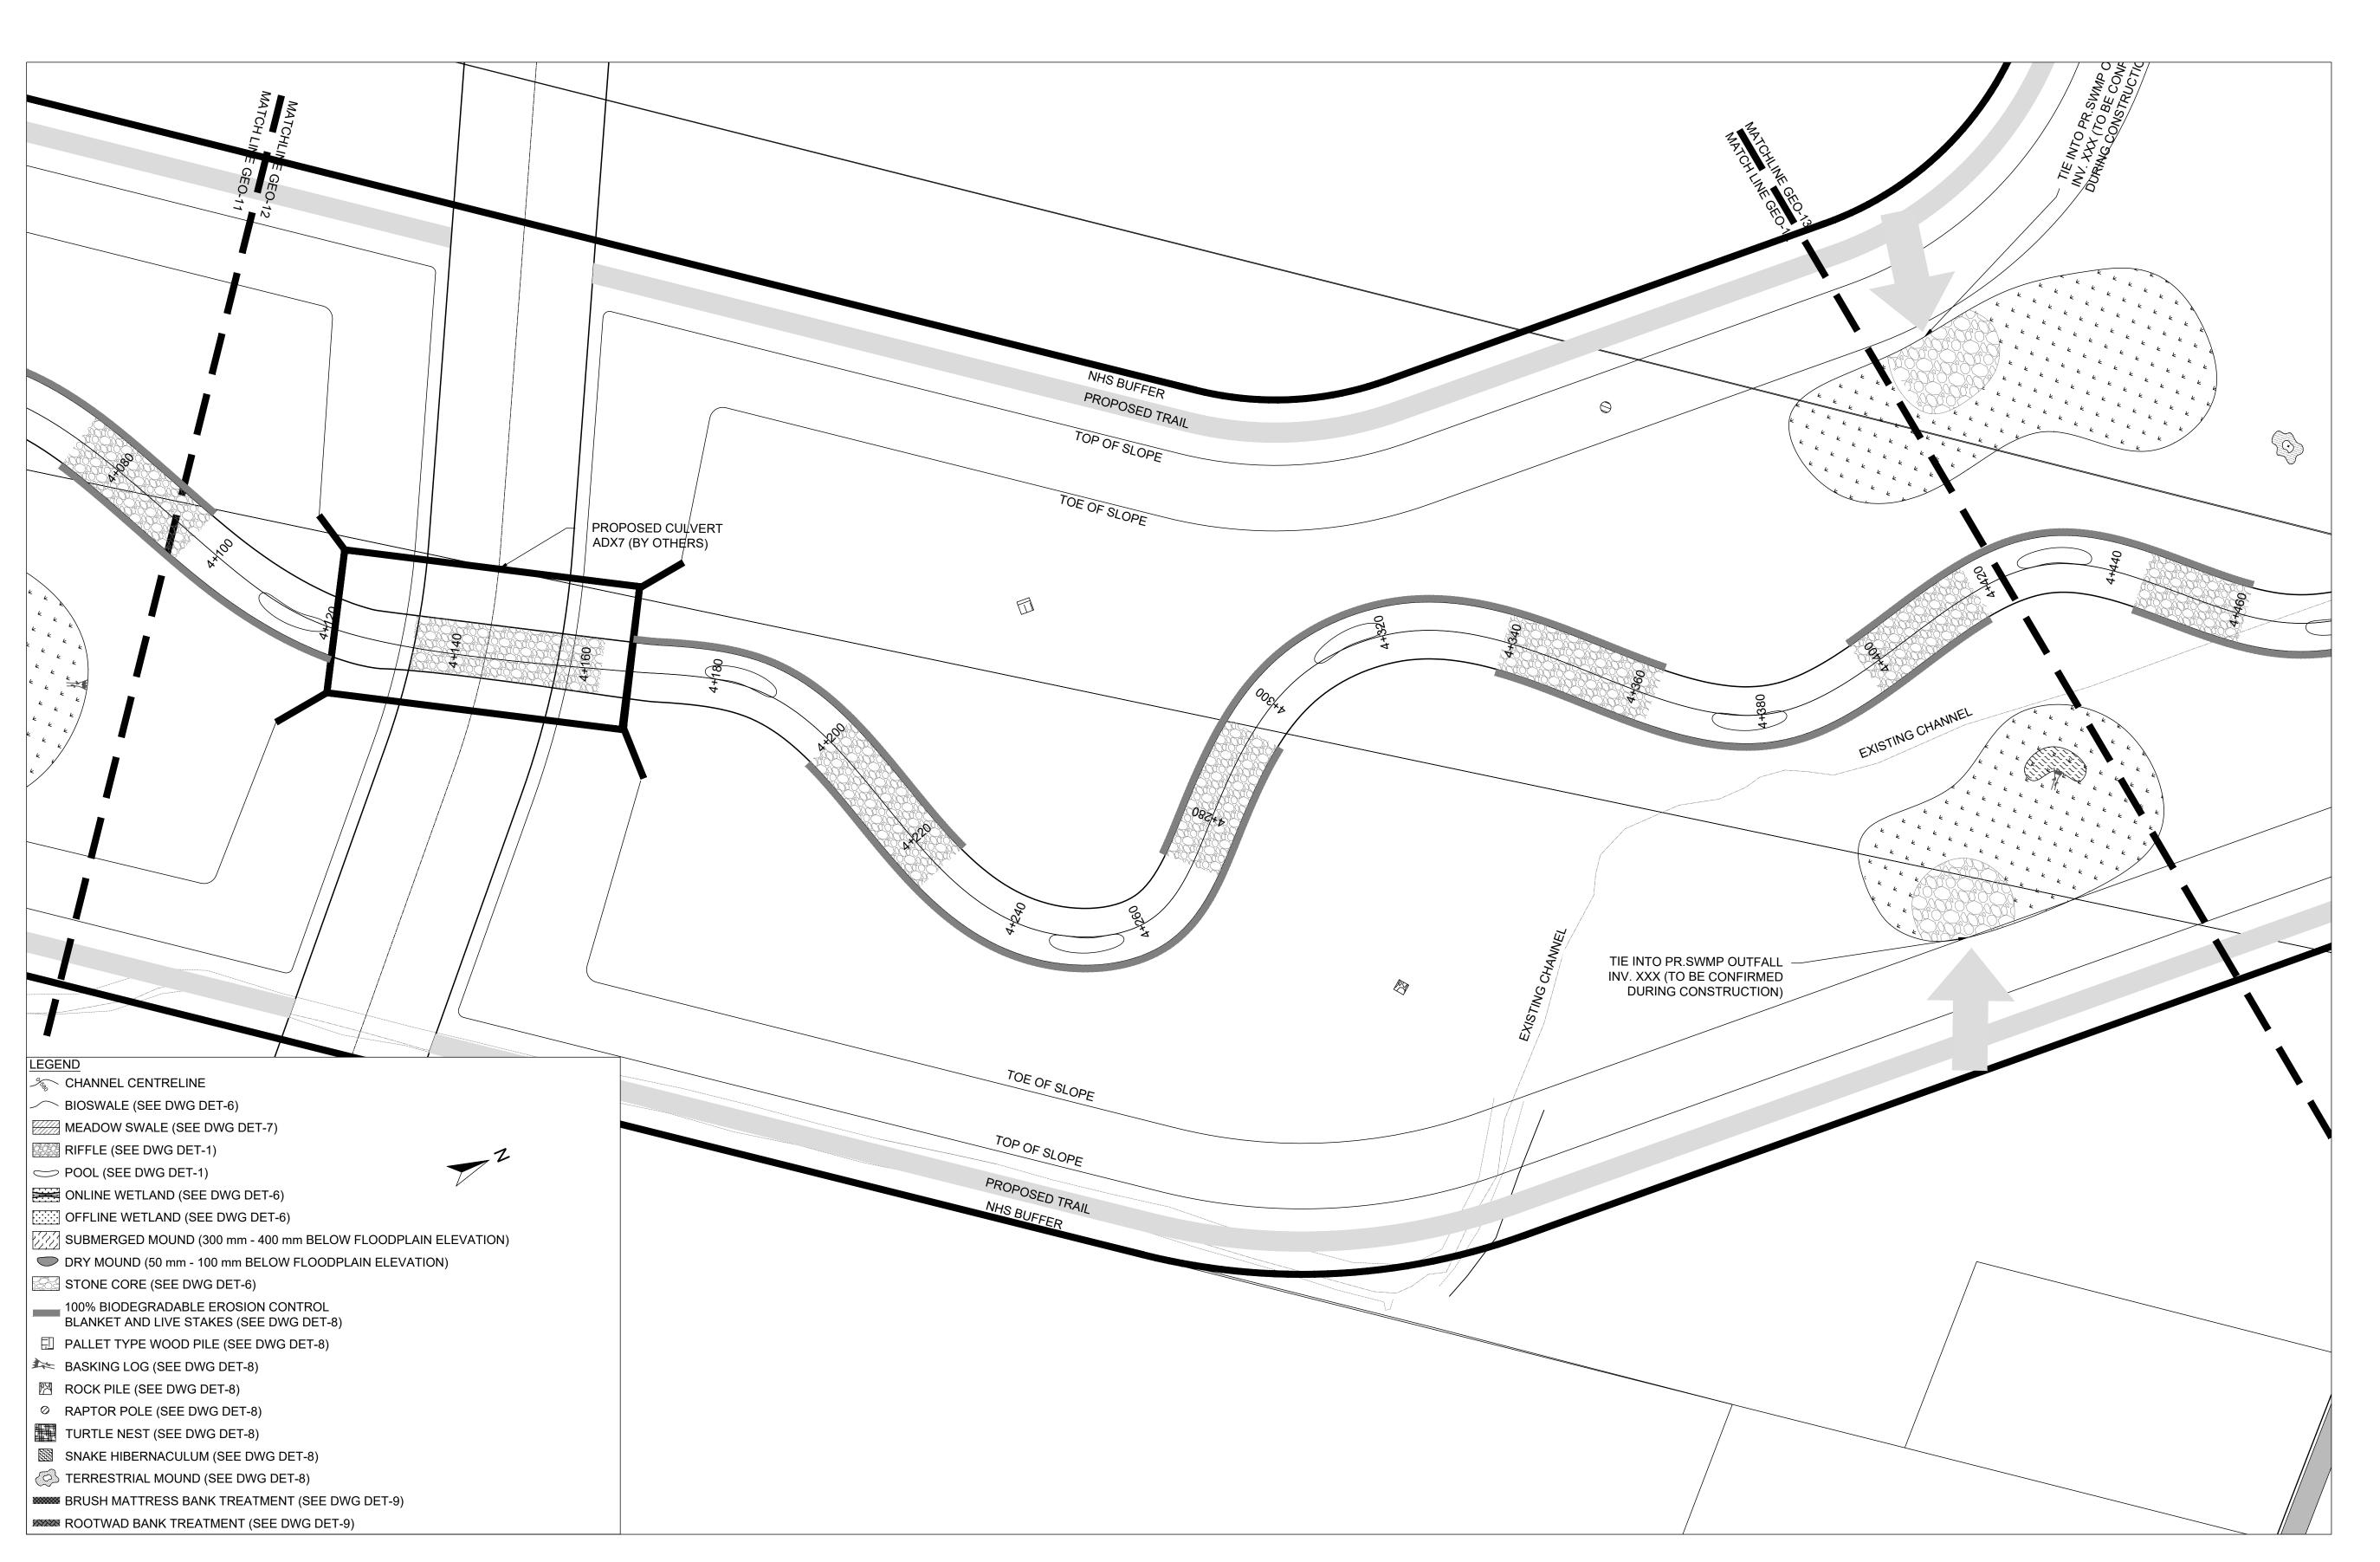

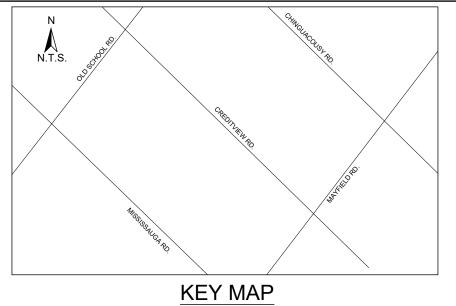

- 1. THE ACCOMPANYING CHANNEL REALIGNMENT TECHNICAL DESIGN BRIEF PREPARED BY GEO MORPHIX LTD. (2023) PROVIDES ADDITIONAL DESIGN DETAILS AND DIRECTION FOR IMPLEMENTATION AND IS TO BE REVIEWED IN CONJUNCTION WITH THIS DRAWING SET.
- 2. ALL CONTRACT DRAWINGS, SPECIFICATIONS AND APPLICABLE PERMITS MUST BE KEPT ON SITE DURING CONSTRUCTION FOR REFERENCE.

 3. THE CONTRACTOR MUST NOTIFY THE DESIGNER AND CONTRACT ADMINISTRATOR OF THE INTENT TO COMMENCE
- WORK AT LEAST 48 HOURS IN ADVANCE.
- 4. THE CONTRACTOR IS RESPONSIBLE FOR ALL UTILITY LOCATES.
 5. LAYOUT MUST BE REVIEWED AND APPROVED BY THE DESIGNER / DESIGNER REPRESENTATIVE, DESIGNATED
- ENGINEER, AND THE CONTRACT ADMINISTRATOR. CONSTRUCTION OBSERVATION IS TO BE PERFORMED BY A CERTIFIED FLUVIAL GEOMORPHOLOGIST OR EXPERIENCED ENVIRONMENTAL INSPECTOR UNDER DIRECTION FROM THE DESIGNER.
- 7. ON-SITE SUPPORT FROM PROJECT ENGINEER (E.G., GEOTECHNICAL, HYDROGEOLOGICAL, AND/OR WATER
- RESOURCES ENGINEER) REQUIRED TO ASSESS AND ENSURE FAVOURABLE SURFICIAL AND SUBSURFACE CONDITIONS TO SUPPORT CHANNEL REALIGNMENT CONSTRUCTION. 8. BE ADVISED THAT THE LOCAL REGULATORY BODY MAY, AT ANY TIME, WITHDRAW THIS PERMISSION, IF, IN THE OPINION OF THE AUTHORITY. THE CONDITIONS OF THE PERMIT ARE NOT BEING COMPLIED WITH, THIS APPROVAL

DOES NOT EXEMPT THE PROPERTY OWNER/APPLICANT/AGENT FROM THE PROVISIONS OF ANY OTHER FEDERAL, PROVINCIAL OR MUNICIPAL STATUTES, REGULATIONS OR BY-LAWS, OR ANY RIGHTS UNDER COMMON LAW.

- 1. WORKS SHALL BE COMPLETED DURING THE DESIGNATED IN-WATER WORKS WINDOW SET OUT BY MNRF/DFO. TREE CLEARING IS TO BE COMPLETED OUTSIDE THE BIRD NESTING SEASON (APRIL 1ST TO AUGUST 1ST) TO COMPLY WITH THE FEDERAL MIGRATORY BIRDS CONVENTION ACT. ANY TREES THAT REQUIRE REMOVAL OUTSIDE OF THIS TIMING WINDOW MUST FIRST BE INSPECTED BY A QUALIFIED BIOLOGIST TO DETERMINE THE PRESENCE OF
- 3. THE WEATHER FORECAST SHOULD BE CONTINUALLY MONITORED TO ENSURE THAT WORKS ARE UNDERTAKEN ONLY DURING FAVOURABLE WEATHER CONDITIONS. 4. COMPLETE THE WORKS WITH MINIMAL AVOIDABLE INTERRUPTIONS ONCE THEY COMMENCE.

SITE AND MATERIAL MANAGEMENT

- 1. ALL CONSTRUCTION EQUIPMENT AND MATERIALS (IMPORTED OR EXCAVATED) MUST BE STORED AT LEAST 30 m AWAY FROM ANY WATERBODY IN A STABLE AREA ABOVE THE ACTIVE FLOODPLAIN, OR IN A DESIGNATED
- 2. IN THE EVENT OF AN UNEXPECTED STORM, ALL UNFIXED ITEMS THAT HAVE THE POTENTIAL TO CAUSE A SPILL OR AN OBSTRUCTION TO FLOW MUST BE MOVED A STABLE AREA ABOVE ACTIVE FLOODPLAIN. 3. STOCKPILES MUST BE LOCATED OUTSIDE THE ISOLATED WORK AREAS.
- 4. STABILIZE, TEMPORARILY OR PERMANENTLY, ANY DISTURBED AREAS AS WORK PROGRESSES, OR SOON AS CONDITIONS ALLOW. 5. MINIMIZE THE AREA OF DISTURBANCE TO THE EXTENT POSSIBLE. ALL DISTURBED GROUND LEFT INACTIVE FOR MORE THAN 30 DAYS SHALL BE STABILIZED USING APPROPRIATE EROSION CONTROL MEASURES AND AN
- APPROPRIATE SEED MIX AS NOTED WITHIN THE FINAL APPROVED RESTORATION PLAN. 6. ALL VEGETATION, ADJACENT TO THE WORK AREA, MUST BE PROTECTED AND DELINEATED WITH CONSTRUCTION
- FENCING OR TREE PROTECTION BARRIERS. 7. ALL GRADES IN THE AREA REGULATED BY THE CONSERVATION AUTHORITY MUST BE MAINTAINED OR MATCHED,
- UNLESS OTHERWISE AUTHORIZED IN THE APPLICABLE PERMIT.

 8. AN AFTER-HOURS CONTACT NUMBER IS TO BE VISIBLY POSTED ONSITE FOR EMERGENCIES. ALL THE PLANS
- SHOULD HAVE NAME AND CONTACT INFO OF THE PERSON RESPONSIBLE FOR ESC MEASURES.

EROSION AND SEDIMENT CONTROL

- 1. ALL TEMPORARY EROSION AND SEDIMENT CONTROL MEASURES MUST BE INSTALLED PRIOR TO START OF WORKS. 2. FOLLOWING INSTALLATION OF THE PROPOSED ESC MEASURES, A QUALIFIED AGENT OF THE PROPONENT (E.G. CAN-CISEC CERTIFIED MONITOR) WILL CONDUCT REGULAR SITÉ VISITS TO MONITOR ALL WORKS, PARTICULARLY THE CONDITION OF THE ESC MEASURES, DEWATERING, AND IN- OR NEAR-WATER WORKS. SHOULD CONCERNS ARISE; THE ENVIRONMENTAL MONITOR WILL CONTACT THE PROPONENT, THE CONSERVATION AUTHORITY, AND
- 3. EROSION AND SEDIMENT CONTROLS MUST BE MAINTAINED DURING CONSTRUCTION, AND ANY REQUIRED REPAIRS OR REPLACEMENTS MUST BE COMPLETED WITHIN 24 HOURS AFTER THEY HAVE BEEN IDENTIFIED DURING THE
- 4. EROSION AND SEDIMENT CONTROLS MAY REQUIRE PERIODIC ADJUSTMENTS TO REFLECT CHANGING SITE CONDITIONS. THE CONTRACTOR WILL BE RESPONSIBLE FOR THESE ADJUSTMENTS TO ENSURE PROPER
- 5. ANY CHANGES TO THE EROSION AND SEDIMENT CONTROL PLAN BEYOND MINOR ADJUSTMENTS MUST BE APPROVED BY THE CONTRACT ADMINISTRATOR.
- 6. ADDITIONAL EROSION AND SEDIMENT CONTROL SUPPLIES MUST BE KEPT ON SITE IN ORDER TO FACILITATE IMMEDIATE REPAIRS AND/OR UPGRADES AS NEEDED.
- 7. ALL TEMPORARY SEDIMENT CONTROLS MUST BE REMOVED AFTER THE CONTRACT ADMINISTRATOR DEEMS THE
- 8. THE PROJECT PROPONENT OR THEIR REPRESENTATIVE IS ULTIMATELY RESPONSIBLE FOR CONTROLLING SEDIMENT AND EROSION WITHIN THE CONSTRUCTION SITE FOR THE TOTAL PERIOD OF THE CONSTRUCTION. 9. IF EXCESSIVE SILTATION RESULTS FROM THE CONSTRUCTION ACTIVITIES, THE ONSITE SUPERVISOR/INSPECTOR
- AND/OR THE LOCAL REGULATORY BODY RESERVE THE RIGHT TO REQUEST ADDITIONAL ESC MEASURES WHICH WOULD BE INSTALLED PRIOR TO FURTHER CONSTRUCTION ACTIVITIES.

DELETERIOUS SUBSTANCE CONTROL/SPILL MANAGEMENT

- PREVENT THE RELEASE OF SEDIMENT, SEDIMENT-LADEN WATER, RAW CONCRETE, CONCRETE LEACHATE OR ANY OTHER DELETERIOUS SUBSTANCES INTO ANY WATERBODY, RAVINE OR STORM SEWER SYSTEM. 2. ENSURE EQUIPMENT AND MACHINERY ARE IN GOOD OPERATING CONDITION (POWER WASHED), FREE OF LEAKS, EXCESS OIL, AND GREASE.

 3. NO EQUIPMENT REFUELLING OR SERVICING SHOULD BE UNDERTAKEN WITHIN 30 m OF ANY WATERCOURSE OR
- 4. A SPILL CONTAINMENT KIT MUST BE READILY ACCESSIBLE ON SITE IN THE EVENT OF A RELEASE OF A DELETERIOUS SUBSTANCE TO THE ENVIRONMENT. ONSITE STAFF MUST BE TRAINED IN ITS USE.
- 5. THE CONTRACT ADMINISTRATOR MUST BE NOTIFIED IMMEDIATELY IN THE EVENT OF A SPILL OF DELETERIOUS SUBSTANCE. ANY SEDIMENT SPILL FROM THE SITE SHOULD BE REPORTED TO MINISTRY OF ENVIRONMENT (SPILL ACTION CENTER) AT 1-800-268-6060.

WORK AREA ISOLATION

SURFACE WATER DRAINAGE.

- 1. ALL WORK IN ISOLATED WORK AREAS MUST BE COMPLETED IN THE DRY. AN ADEQUATE NUMBER OF PUMPS MUST BE USED FOR UNWATERING.
 2. CROSSING AN ACTIVE WATERCOURSE OR WETLAND BY EQUIPMENT, VEHICLES, PERSONNEL, ETC. IS NOT
- PERMITTED UNLESS APPROVED BY THE CONSERVATION AUTHORITY. ALL ACCESS TO WORK SITES SHALL BE FROM
- EITHER SIDES OF THE WATERCOURSE OR WETLAND.

 3. THE UNWATERING DISCHARGE LOCATION MUST BE LOCATED AT LEAST 30 M FROM ANY WATERCOURSE OR WETLAND IN AN AREA WITH DENSE VEGETATIVE GROUNDCOVER, AND WHERE THE DISCHARGE CAN RETURN TO THE WATERBODY DOWNSTREAM OF THE WORK AREA OVER THE GROUNDCOVER.
- 4. FISH MUST BE REMOVED FROM THE WORK AREA ONCE ISOLATED. FISH SALVAGE MUST BE COMPLETED BY A QUALIFIED TECHNICIAN WITH A LICENSE FROM THE ONTARIO MINISTRY OF NATURAL RESOURCES AND FORESTRY

	DATE	BY	REVISIONS	
DESIGNED BY: 1 D/AS			CHECKED BV: DV	

DESIGNED BY: LD/AS CHECKED BY: PV DRAWN BY: AL/CP/SC DATE: JUNE 2024

DRAFT FOR INTERNAL DISCUSSION

NOT FOR CONSTRUCTION


 $M O R P H I X^{\mathsf{m}}$ 36 Main St N., P.O. Box 205 Campbellville, Ontario L0P 1B0 T: 416.920.0926 www.geomorphix.com


ALLOA SPA **TOWN OF CALEDON**

ETOBICOKE CREEK - ALLOA DRAIN CONCEPTUAL CHANNEL DESIGN CHANNEL PLANFORM

SCALED FOR PLOT ON 'ARCH D' | SCALE: AS NOTED

PROJECT No.: PN24009 DRAWING No.:GEO-12 SHEET 13 OF 35

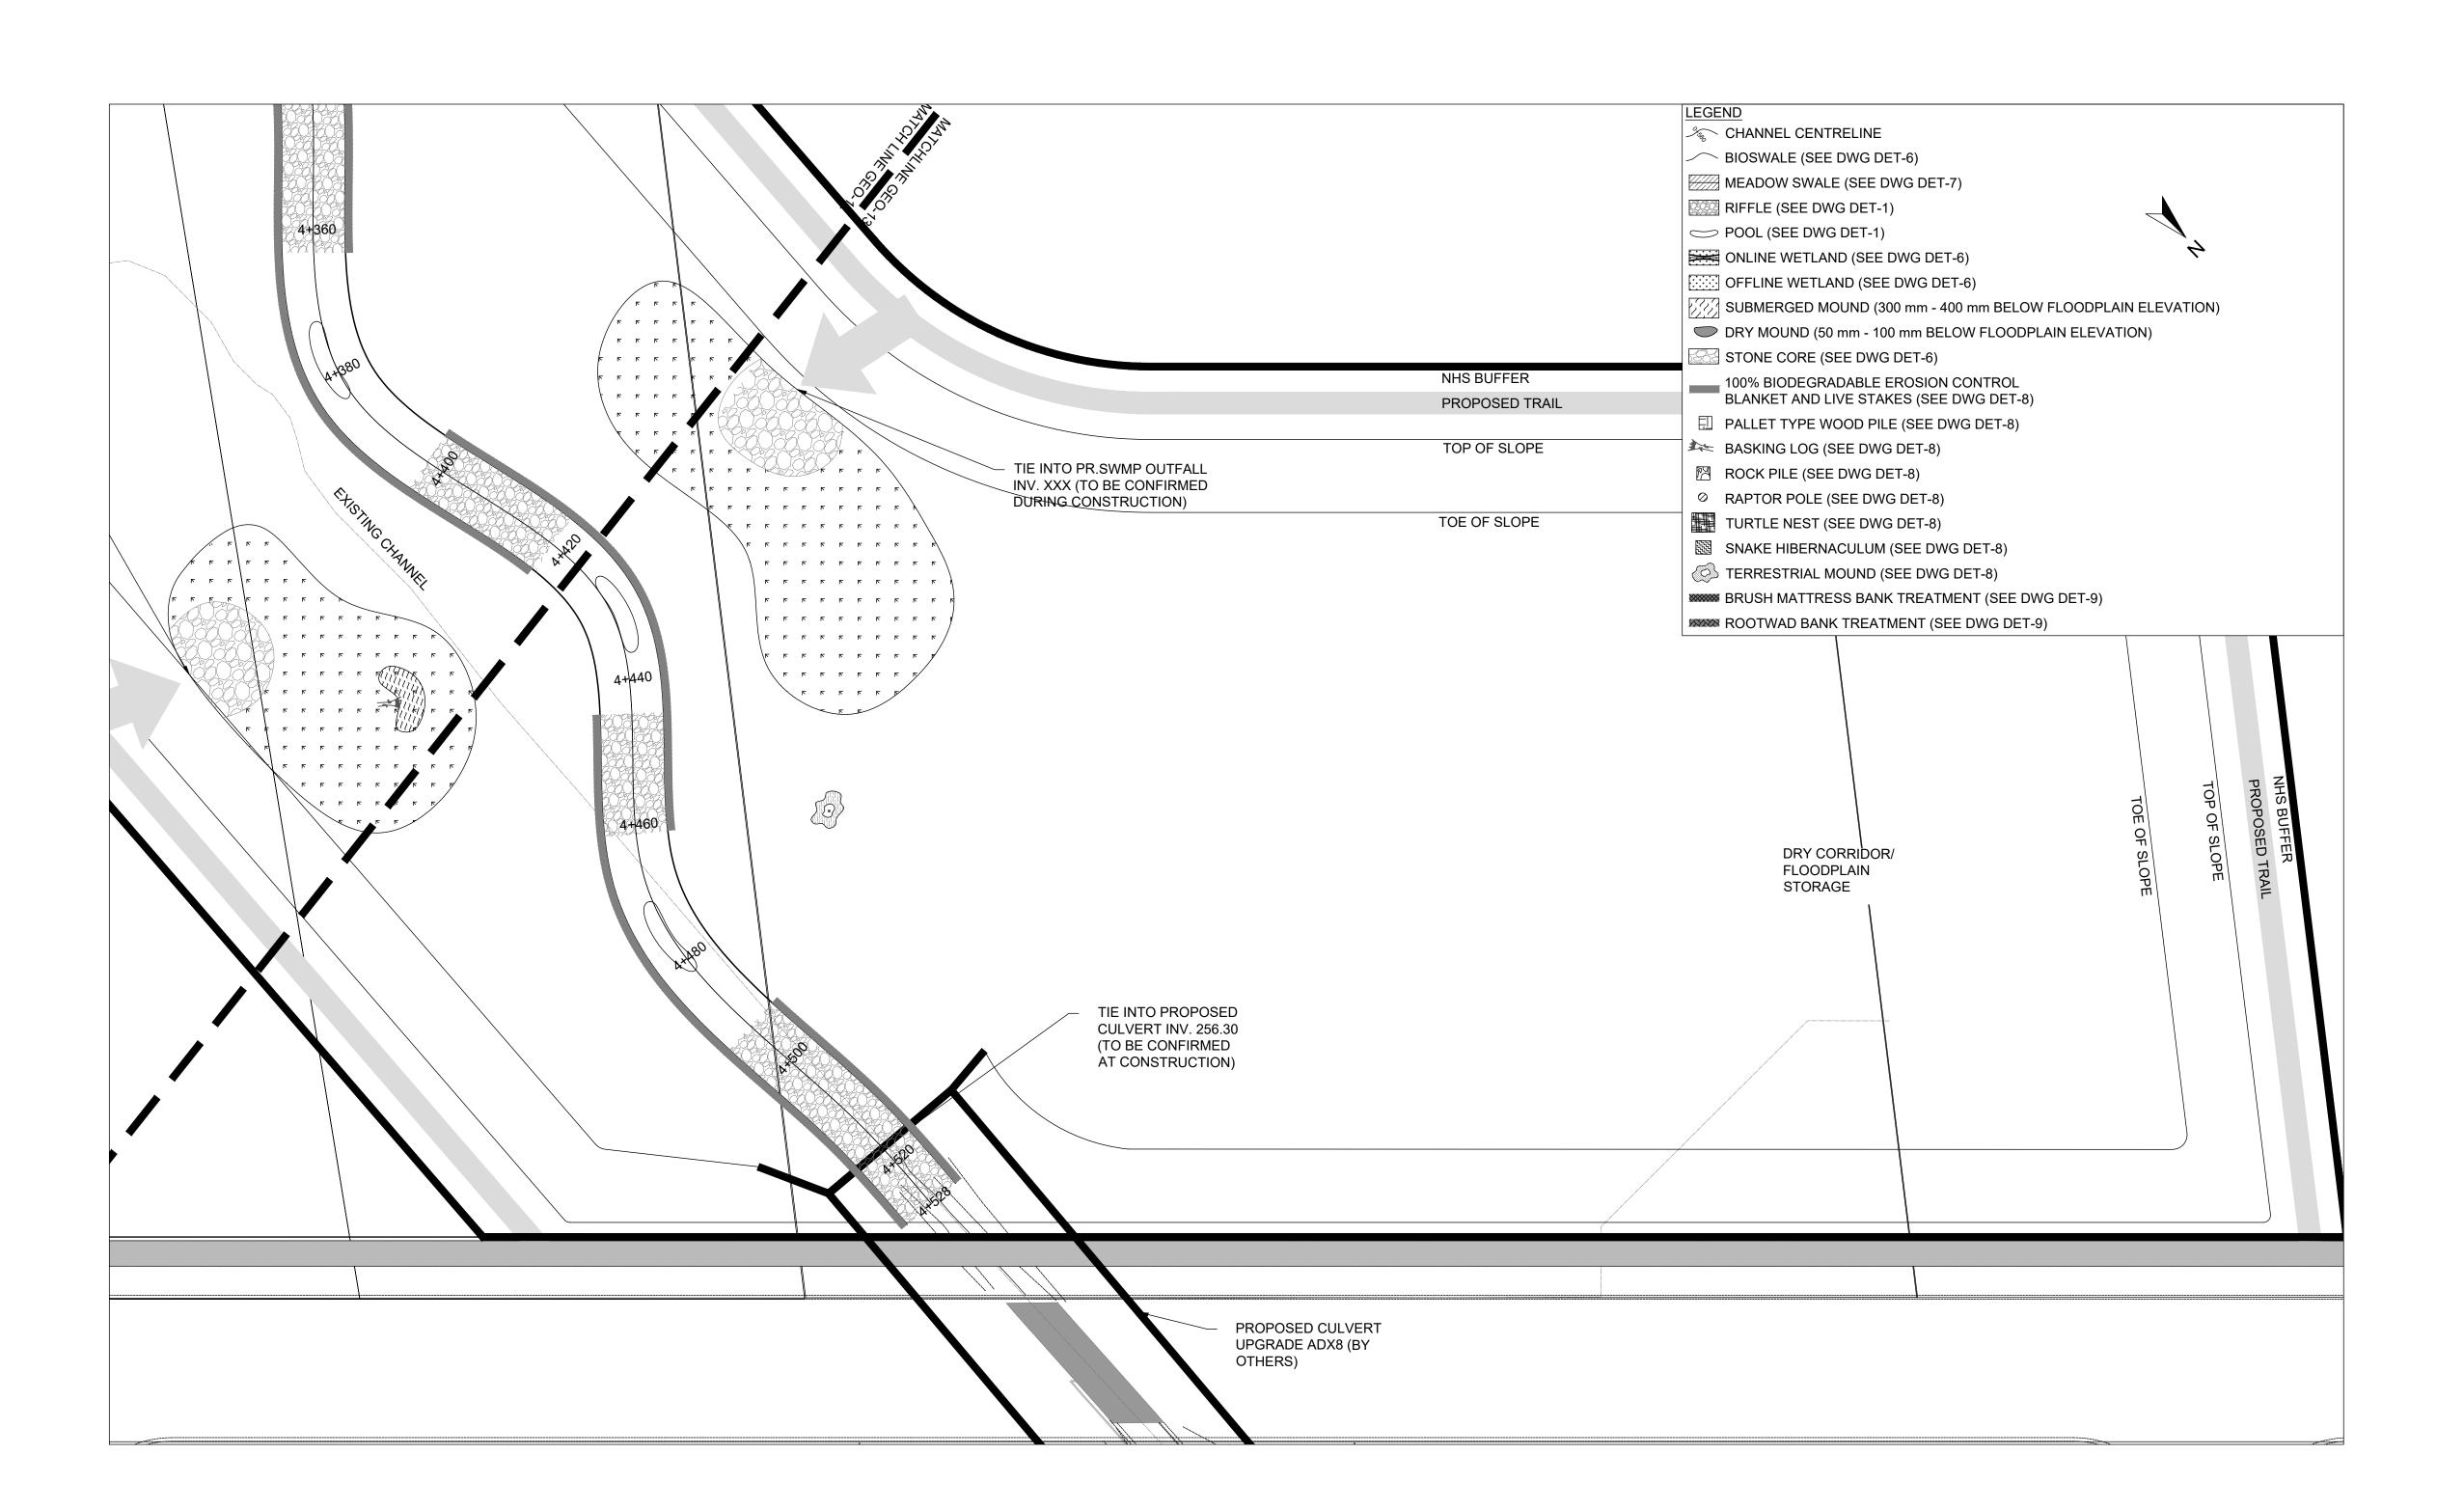

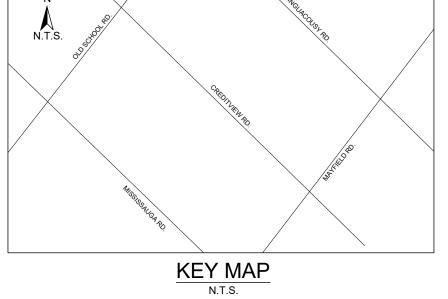

1. THE ACCOMPANYING CHANNEL REALIGNMENT TECHNICAL DESIGN BRIEF PREPARED BY GEO MORPHIX LTD. (2023) PROVIDES ADDITIONAL DESIGN DETAILS AND DIRECTION FOR IMPLEMENTATION AND IS TO BE REVIEWED IN

CONJUNCTION WITH THIS DRAWING SET. 2. ALL CONTRACT DRAWINGS, SPECIFICATIONS AND APPLICABLE PERMITS MUST BE KEPT ON SITE DURING

CONSTRUCTION FOR REFERENCE.

3. THE CONTRACTOR MUST NOTIFY THE DESIGNER AND CONTRACT ADMINISTRATOR OF THE INTENT TO COMMENCE WORK AT LEAST 48 HOURS IN ADVANCE.

4. THE CONTRACTOR IS RESPONSIBLE FOR ALL UTILITY LOCATES.
5. LAYOUT MUST BE REVIEWED AND APPROVED BY THE DESIGNER / DESIGNER REPRESENTATIVE, DESIGNATED

ENGINEER, AND THE CONTRACT ADMINISTRATOR. CONSTRUCTION OBSERVATION IS TO BE PERFORMED BY A CERTIFIED FLUVIAL GEOMORPHOLOGIST OR EXPERIENCED ENVIRONMENTAL INSPECTOR UNDER DIRECTION FROM THE DESIGNER.

7. ON-SITE SUPPORT FROM PROJECT ENGINEER (E.G., GEOTECHNICAL, HYDROGEOLOGICAL, AND/OR WATER RESOURCES ENGINEER) REQUIRED TO ASSESS AND ENSURE FAVOURABLE SURFICIAL AND SUBSURFACE

CONDITIONS TO SUPPORT CHANNEL REALIGNMENT CONSTRUCTION. 8. BE ADVISED THAT THE LOCAL REGULATORY BODY MAY, AT ANY TIME, WITHDRAW THIS PERMISSION, IF, IN THE OPINION OF THE AUTHORITY. THE CONDITIONS OF THE PERMIT ARE NOT BEING COMPLIED WITH. THIS APPROVAL DOES NOT EXEMPT THE PROPERTY OWNER/APPLICANT/AGENT FROM THE PROVISIONS OF ANY OTHER FEDERAL,

PROVINCIAL OR MUNICIPAL STATUTES, REGULATIONS OR BY-LAWS, OR ANY RIGHTS UNDER COMMON LAW.

TIMING OF WORKS

1. WORKS SHALL BE COMPLETED DURING THE DESIGNATED IN-WATER WORKS WINDOW SET OUT BY MNRF/DFO. TREE CLEARING IS TO BE COMPLETED OUTSIDE THE BIRD NESTING SEASON (APRIL 1ST TO AUGUST 1ST) TO COMPLY WITH THE FEDERAL MIGRATORY BIRDS CONVENTION ACT. ANY TREES THAT REQUIRE REMOVAL OUTSIDE OF THIS TIMING WINDOW MUST FIRST BE INSPECTED BY A QUALIFIED BIOLOGIST TO DETERMINE THE PRESENCE OF

3. THE WEATHER FORECAST SHOULD BE CONTINUALLY MONITORED TO ENSURE THAT WORKS ARE UNDERTAKEN

ONLY DURING FAVOURABLE WEATHER CONDITIONS. 4. COMPLETE THE WORKS WITH MINIMAL AVOIDABLE INTERRUPTIONS ONCE THEY COMMENCE.

SITE AND MATERIAL MANAGEMENT

1. ALL CONSTRUCTION EQUIPMENT AND MATERIALS (IMPORTED OR EXCAVATED) MUST BE STORED AT LEAST 30 m

AWAY FROM ANY WATERBODY IN A STABLE AREA ABOVE THE ACTIVE FLOODPLAIN, OR IN A DESIGNATED 2. IN THE EVENT OF AN UNEXPECTED STORM, ALL UNFIXED ITEMS THAT HAVE THE POTENTIAL TO CAUSE A SPILL OR AN OBSTRUCTION TO FLOW MUST BE MOVED A STABLE AREA ABOVE ACTIVE FLOODPLAIN.

3. STOCKPILES MUST BE LOCATED OUTSIDE THE ISOLATED WORK AREAS. 4. STABILIZE, TEMPORARILY OR PERMANENTLY, ANY DISTURBED AREAS AS WORK PROGRESSES, OR SOON AS

CONDITIONS ALLOW. 5. MINIMIZE THE AREA OF DISTURBANCE TO THE EXTENT POSSIBLE. ALL DISTURBED GROUND LEFT INACTIVE FOR MORE THAN 30 DAYS SHALL BE STABILIZED USING APPROPRIATE EROSION CONTROL MEASURES AND AN

APPROPRIATE SEED MIX AS NOTED WITHIN THE FINAL APPROVED RESTORATION PLAN. 6. ALL VEGETATION, ADJACENT TO THE WORK AREA, MUST BE PROTECTED AND DELINEATED WITH CONSTRUCTION

FENCING OR TREE PROTECTION BARRIERS. 7. ALL GRADES IN THE AREA REGULATED BY THE CONSERVATION AUTHORITY MUST BE MAINTAINED OR MATCHED,

UNLESS OTHERWISE AUTHORIZED IN THE APPLICABLE PERMIT.

8. AN AFTER-HOURS CONTACT NUMBER IS TO BE VISIBLY POSTED ONSITE FOR EMERGENCIES. ALL THE PLANS SHOULD HAVE NAME AND CONTACT INFO OF THE PERSON RESPONSIBLE FOR ESC MEASURES.

EROSION AND SEDIMENT CONTROL

 ALL TEMPORARY EROSION AND SEDIMENT CONTROL MEASURES MUST BE INSTALLED PRIOR TO START OF WORKS.
 FOLLOWING INSTALLATION OF THE PROPOSED ESC MEASURES, A QUALIFIED AGENT OF THE PROPONENT (E.G. CAN-CISEC CERTIFIED MONITOR) WILL CONDUCT REGULAR SITÉ VISITS TO MONITOR ALL WORKS, PARTICULARLY THE CONDITION OF THE ESC MEASURES, DEWATERING, AND IN- OR NEAR-WATER WORKS. SHOULD CONCERNS ARISE; THE ENVIRONMENTAL MONITOR WILL CONTACT THE PROPONENT, THE CONSERVATION AUTHORITY, AND

ANY OTHER APPROPRIATE PARTIES. 3. EROSION AND SEDIMENT CONTROLS MUST BE MAINTAINED DURING CONSTRUCTION, AND ANY REQUIRED REPAIRS OR REPLACEMENTS MUST BE COMPLETED WITHIN 24 HOURS AFTER THEY HAVE BEEN IDENTIFIED DURING THE

4. EROSION AND SEDIMENT CONTROLS MAY REQUIRE PERIODIC ADJUSTMENTS TO REFLECT CHANGING SITE CONDITIONS. THE CONTRACTOR WILL BE RESPONSIBLE FOR THESE ADJUSTMENTS TO ENSURE PROPER

ANY CHANGES TO THE EROSION AND SEDIMENT CONTROL PLAN BEYOND MINOR ADJUSTMENTS MUST BE APPROVED BY THE CONTRACT ADMINISTRATOR.

6. ADDITIONAL EROSION AND SEDIMENT CONTROL SUPPLIES MUST BE KEPT ON SITE IN ORDER TO FACILITATE IMMEDIATE REPAIRS AND/OR UPGRADES AS NEEDED.
7. ALL TEMPORARY SEDIMENT CONTROLS MUST BE REMOVED AFTER THE CONTRACT ADMINISTRATOR DEEMS THE

8. THE PROJECT PROPONENT OR THEIR REPRESENTATIVE IS ULTIMATELY RESPONSIBLE FOR CONTROLLING

SEDIMENT AND EROSION WITHIN THE CONSTRUCTION SITE FOR THE TOTAL PERIOD OF THE CONSTRUCTION. 9. IF EXCESSIVE SILTATION RESULTS FROM THE CONSTRUCTION ACTIVITIES, THE ONSITE SUPERVISOR/INSPECTOR AND/OR THE LOCAL REGULATORY BODY RESERVE THE RIGHT TO REQUEST ADDITIONAL ESC MEASURES WHICH WOULD BE INSTALLED PRIOR TO FURTHER CONSTRUCTION ACTIVITIES.

DELETERIOUS SUBSTANCE CONTROL/SPILL MANAGEMENT

1. PREVENT THE RELEASE OF SEDIMENT, SEDIMENT-LADEN WATER, RAW CONCRETE, CONCRETE LEACHATE OR ANY OTHER DELETERIOUS SUBSTANCES INTO ANY WATERBODY, RAVINE OR STORM SEWER SYSTEM. 2. ENSURE EQUIPMENT AND MACHINERY ARE IN GOOD OPERATING CONDITION (POWER WASHED), FREE OF LEAKS, EXCESS OIL, AND GREASE.

3. NO EQUIPMENT REFUELLING OR SERVICING SHOULD BE UNDERTAKEN WITHIN 30 m OF ANY WATERCOURSE OR

SURFACE WATER DRAINAGE. A SPILL CONTAINMENT KIT MUST BE READILY ACCESSIBLE ON SITE IN THE EVENT OF A RELEASE OF A DELETERIOUS SUBSTANCE TO THE ENVIRONMENT. ONSITE STAFF MUST BE TRAINED IN ITS USE.

5. THE CONTRACT ADMINISTRATOR MUST BE NOTIFIED IMMEDIATELY IN THE EVENT OF A SPILL OF DELETERIOUS

SUBSTANCE. ANY SEDIMENT SPILL FROM THE SITE SHOULD BE REPORTED TO MINISTRY OF ENVIRONMENT (SPILL ACTION CENTER) AT 1-800-268-6060.

WORK AREA ISOLATION

1. ALL WORK IN ISOLATED WORK AREAS MUST BE COMPLETED IN THE DRY. AN ADEQUATE NUMBER OF PUMPS MUST BE USED FOR UNWATERING.

CROSSING AN ACTIVE WATERCOURSE OR WETLAND BY EQUIPMENT, VEHICLES, PERSONNEL, ETC. IS NOT

PERMITTED UNLESS APPROVED BY THE CONSERVATION AUTHORITY. ALL ACCESS TO WORK SITES SHALL BE FROM

EITHER SIDES OF THE WATERCOURSE OR WETLAND. 3. THE UNWATERING DISCHARGE LOCATION MUST BE LOCATED AT LEAST 30 M FROM ANY WATERCOURSE OR WETLAND IN AN AREA WITH DENSE VEGETATIVE GROUNDCOVER, AND WHERE THE DISCHARGE CAN RETURN TO THE WATERBODY DOWNSTREAM OF THE WORK AREA OVER THE GROUNDCOVER.

4. FISH MUST BE REMOVED FROM THE WORK AREA ONCE ISOLATED. FISH SALVAGE MUST BE COMPLETED BY A QUALIFIED TECHNICIAN WITH A LICENSE FROM THE ONTARIO MINISTRY OF NATURAL RESOURCES AND FORESTRY

DATE BY **REVISIONS** CHECKED BY: PV DESIGNED BY: LD/AS DRAWN BY: AL/CP/SC DATE: JUNE 2024

DRAFT FOR **INTERNAL**

DISCUSSION

NOT FOR CONSTRUCTION


 $M O R P H I X^{\mathsf{m}}$ 36 Main St N., P.O. Box 205


Campbellville, Ontario L0P 1B0 T: 416.920.0926 www.geomorphix.com

ALLOA SPA **TOWN OF CALEDON**

ETOBICOKE CREEK - ALLOA DRAIN CONCEPTUAL CHANNEL DESIGN CHANNEL PLANFORM

PROJECT No.: PN24009 DRAWING No.: GEO-13 SHEET 14 OF 35

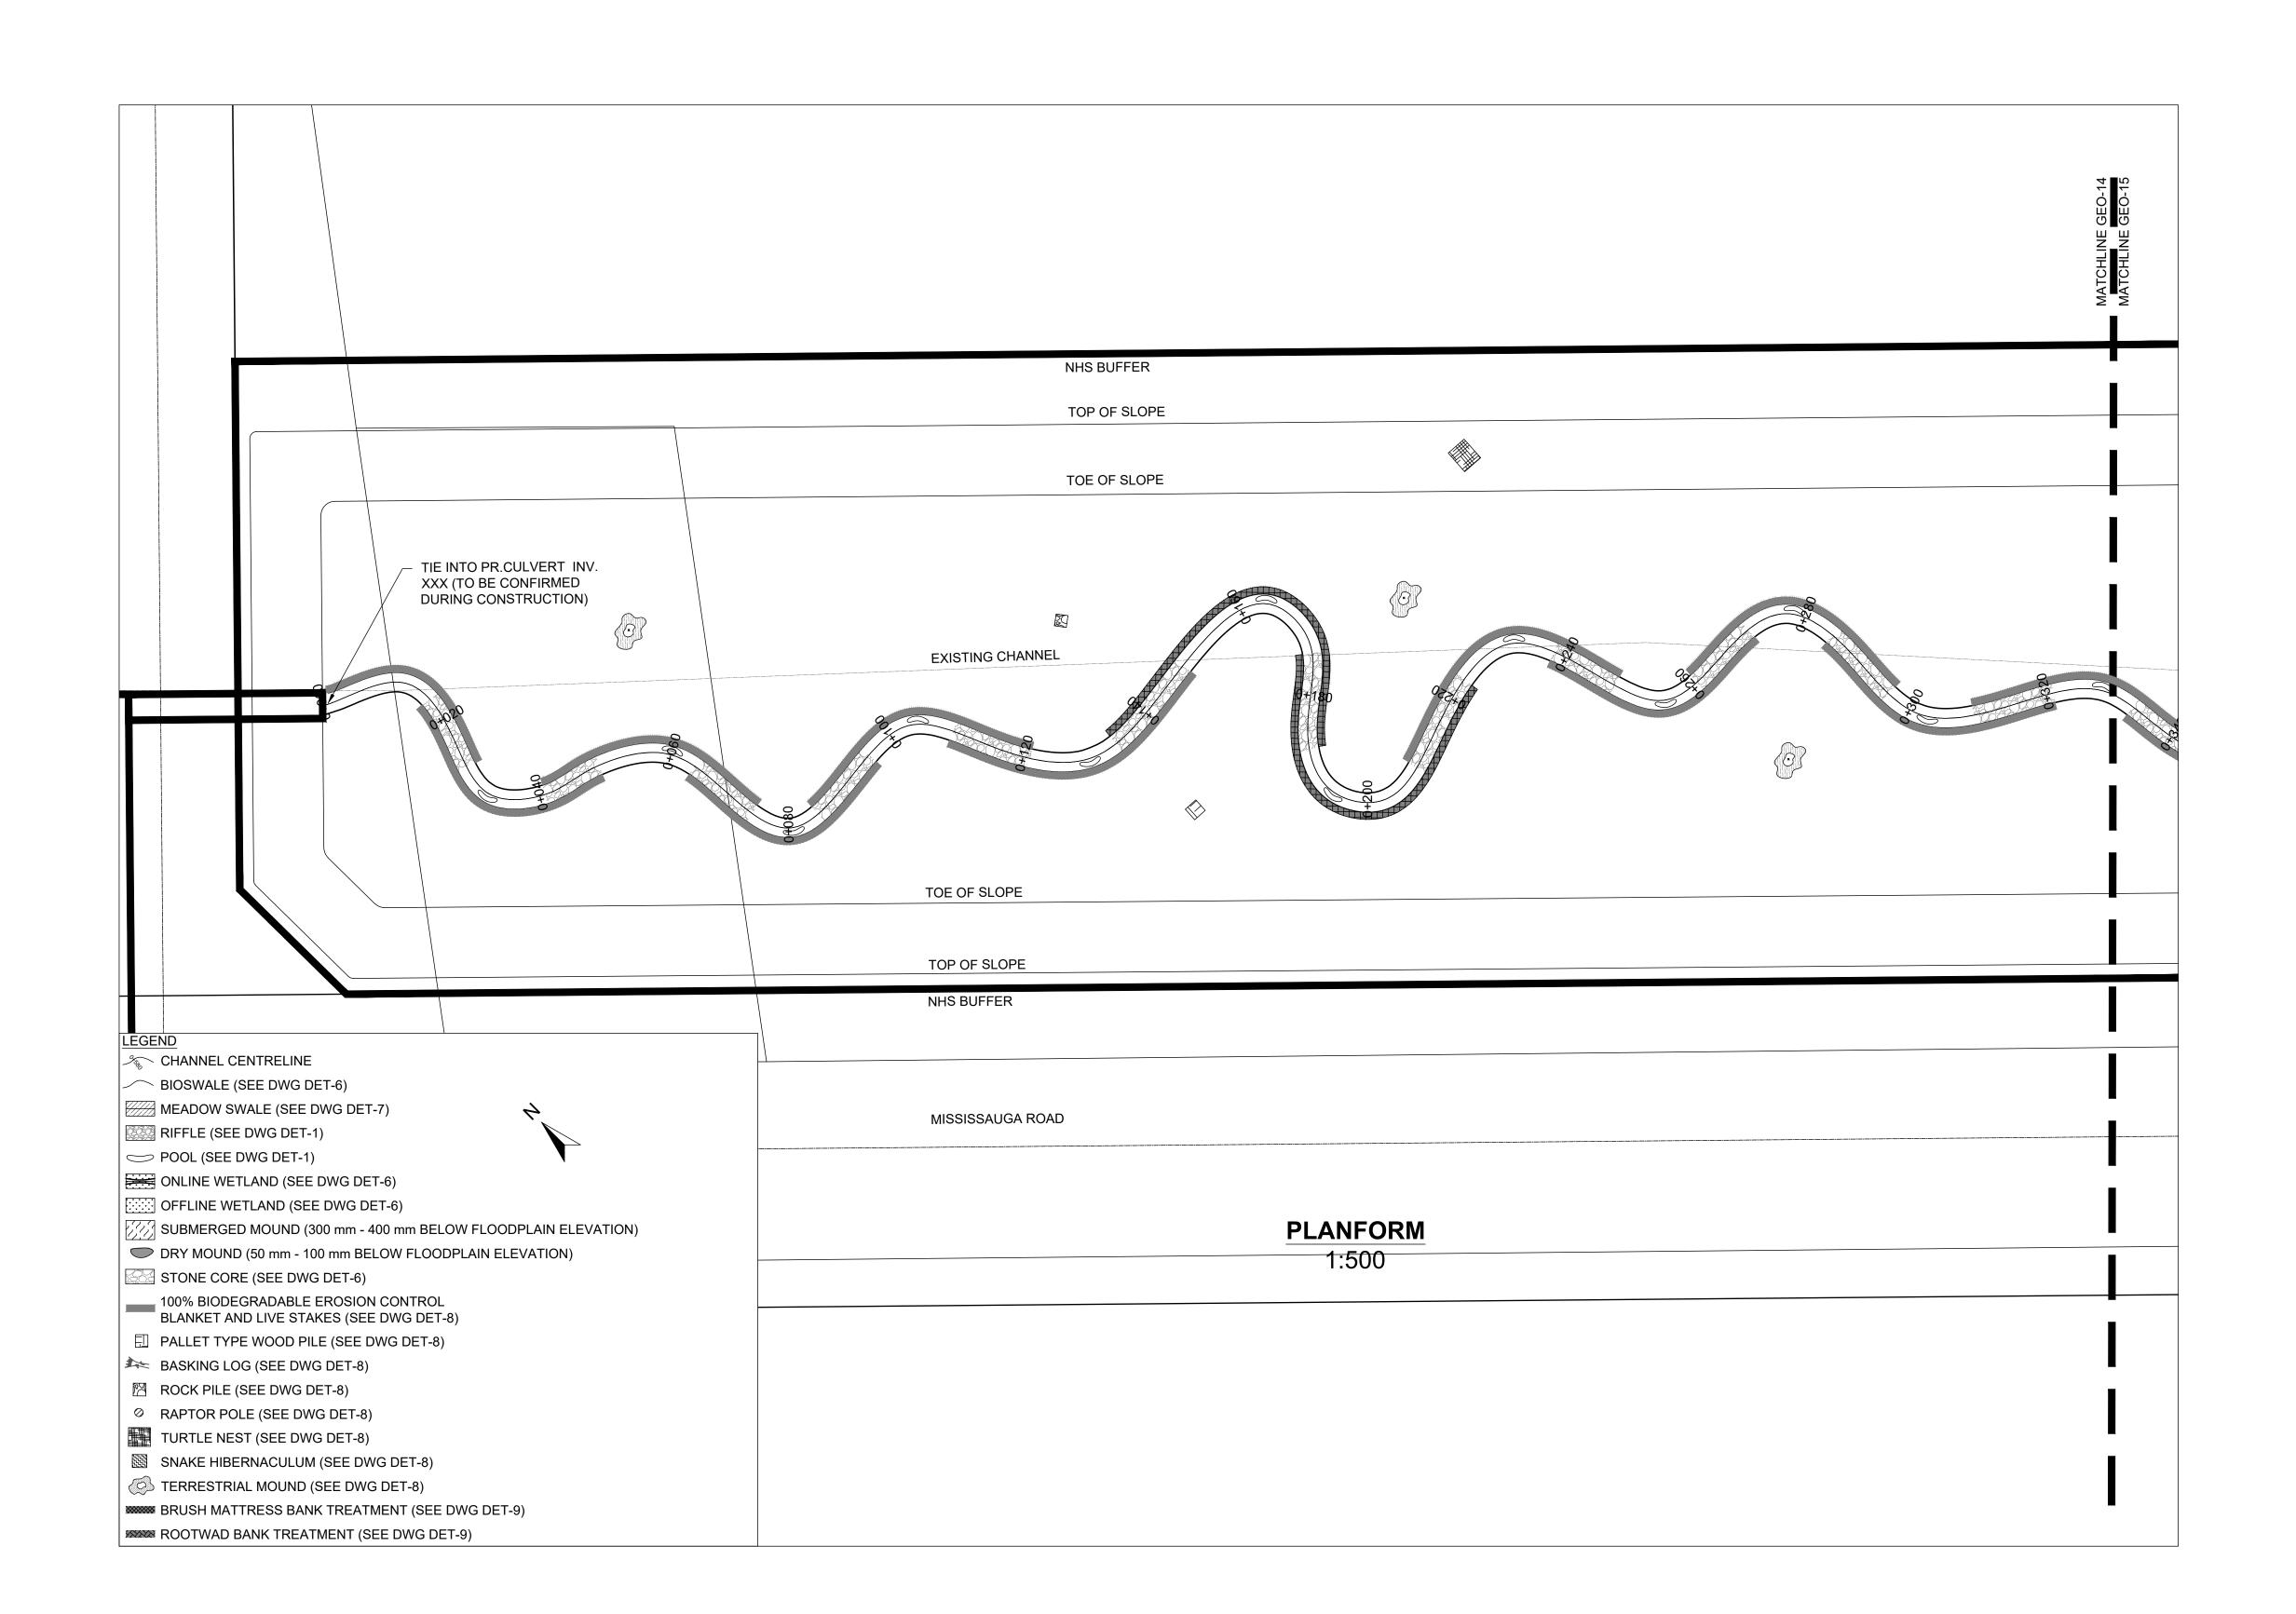

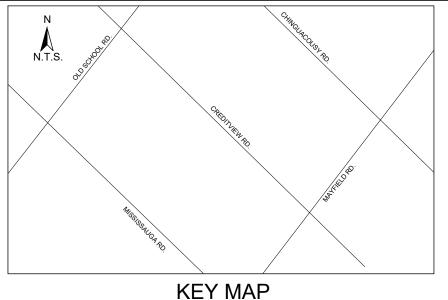

CONJUNCTION WITH THIS DRAWING SET.

- 1. THE ACCOMPANYING CHANNEL REALIGNMENT TECHNICAL DESIGN BRIEF PREPARED BY GEO MORPHIX LTD. (2023) PROVIDES ADDITIONAL DESIGN DETAILS AND DIRECTION FOR IMPLEMENTATION AND IS TO BE REVIEWED IN
- 2. ALL CONTRACT DRAWINGS, SPECIFICATIONS AND APPLICABLE PERMITS MUST BE KEPT ON SITE DURING
- CONSTRUCTION FOR REFERENCE.

 3. THE CONTRACTOR MUST NOTIFY THE DESIGNER AND CONTRACT ADMINISTRATOR OF THE INTENT TO COMMENCE WORK AT LEAST 48 HOURS IN ADVANCE.
- THE CONTRACTOR IS RESPONSIBLE FOR ALL UTILITY LOCATES.
 LAYOUT MUST BE REVIEWED AND APPROVED BY THE DESIGNER / DESIGNER REPRESENTATIVE, DESIGNATED
- ENGINEER, AND THE CONTRACT ADMINISTRATOR.
- CONSTRUCTION OBSERVATION IS TO BE PERFORMED BY A CERTIFIED FLUVIAL GEOMORPHOLOGIST OR EXPERIENCED ENVIRONMENTAL INSPECTOR UNDER DIRECTION FROM THE DESIGNER. 7. ON-SITE SUPPORT FROM PROJECT ENGINEER (E.G., GEOTECHNICAL, HYDROGEOLOGICAL, AND/OR WATER
- RESOURCES ENGINEER) REQUIRED TO ASSESS AND ENSURE FAVOURABLE SURFICIAL AND SUBSURFACE CONDITIONS TO SUPPORT CHANNEL REALIGNMENT CONSTRUCTION. 8. BE ADVISED THAT THE LOCAL REGULATORY BODY MAY, AT ANY TIME, WITHDRAW THIS PERMISSION, IF, IN THE
- OPINION OF THE AUTHORITY, THE CONDITIONS OF THE PERMIT ARE NOT BEING COMPLIED WITH. THIS APPROVAL DOES NOT EXEMPT THE PROPERTY OWNER/APPLICANT/AGENT FROM THE PROVISIONS OF ANY OTHER FEDERAL, PROVINCIAL OR MUNICIPAL STATUTES, REGULATIONS OR BY-LAWS, OR ANY RIGHTS UNDER COMMON LAW.

TIMING OF WORKS

- 1. WORKS SHALL BE COMPLETED DURING THE DESIGNATED IN-WATER WORKS WINDOW SET OUT BY MNRF/DFO. 2. TREE CLEARING IS TO BE COMPLETED OUTSIDE THE BIRD NESTING SEASON (APRIL 1ST TO AUGUST 1ST) TO COMPLY WITH THE FEDERAL MIGRATORY BIRDS CONVENTION ACT. ANY TREES THAT REQUIRE REMOVAL OUTSIDE
- OF THIS TIMING WINDOW MUST FIRST BE INSPECTED BY A QUALIFIED BIOLOGIST TO DETERMINE THE PRESENCE OF
- 3. THE WEATHER FORECAST SHOULD BE CONTINUALLY MONITORED TO ENSURE THAT WORKS ARE UNDERTAKEN ONLY DURING FAVOURABLE WEATHER CONDITIONS.
- 4. COMPLETE THE WORKS WITH MINIMAL AVOIDABLE INTERRUPTIONS ONCE THEY COMMENCE.

SITE AND MATERIAL MANAGEMENT

EROSION AND SEDIMENT CONTROL

- 1. ALL CONSTRUCTION EQUIPMENT AND MATERIALS (IMPORTED OR EXCAVATED) MUST BE STORED AT LEAST 30 m AWAY FROM ANY WATERBODY IN A STABLE AREA ABOVE THE ACTIVE FLOODPLAIN, OR IN A DESIGNATED
- 2. IN THE EVENT OF AN UNEXPECTED STORM, ALL UNFIXED ITEMS THAT HAVE THE POTENTIAL TO CAUSE A SPILL OR AN OBSTRUCTION TO FLOW MUST BE MOVED A STABLE AREA ABOVE ACTIVE FLOODPLAIN.
- 3. STOCKPILES MUST BE LOCATED OUTSIDE THE ISOLATED WORK AREAS.
- 4. STABILIZE, TEMPORARILY OR PERMANENTLY, ANY DISTURBED AREAS AS WORK PROGRESSES, OR SOON AS CONDITIONS ALLOW. 5. MINIMIZE THE AREA OF DISTURBANCE TO THE EXTENT POSSIBLE. ALL DISTURBED GROUND LEFT INACTIVE FOR
- MORE THAN 30 DAYS SHALL BE STABILIZED USING APPROPRIATE EROSION CONTROL MEASURES AND AN APPROPRIATE SEED MIX AS NOTED WITHIN THE FINAL APPROVED RESTORATION PLAN.
- 6. ALL VEGETATION, ADJACENT TO THE WORK AREA, MUST BE PROTECTED AND DELINEATED WITH CONSTRUCTION FENCING OR TREE PROTECTION BARRIERS.
- 7. ALL GRADES IN THE AREA REGULATED BY THE CONSERVATION AUTHORITY MUST BE MAINTAINED OR MATCHED,
- UNLESS OTHERWISE AUTHORIZED IN THE APPLICABLE PERMIT.

 8. AN AFTER-HOURS CONTACT NUMBER IS TO BE VISIBLY POSTED ONSITE FOR EMERGENCIES. ALL THE PLANS

SHOULD HAVE NAME AND CONTACT INFO OF THE PERSON RESPONSIBLE FOR ESC MEASURES.

- ALL TEMPORARY EROSION AND SEDIMENT CONTROL MEASURES MUST BE INSTALLED PRIOR TO START OF WORKS.
 FOLLOWING INSTALLATION OF THE PROPOSED ESC MEASURES, A QUALIFIED AGENT OF THE PROPONENT (E.G. CAN-CISEC CERTIFIED MONITOR) WILL CONDUCT REGULAR SITÉ VISITS TO MONITOR ALL WORKS, PARTICULARLY THE CONDITION OF THE ESC MEASURES, DEWATERING, AND IN- OR NEAR-WATER WORKS. SHOULD CONCERNS
- ANY OTHER APPROPRIATE PARTIES. 3. EROSION AND SEDIMENT CONTROLS MUST BE MAINTAINED DURING CONSTRUCTION, AND ANY REQUIRED REPAIRS OR REPLACEMENTS MUST BE COMPLETED WITHIN 24 HOURS AFTER THEY HAVE BEEN IDENTIFIED DURING THE

ARISE; THE ENVIRONMENTAL MONITOR WILL CONTACT THE PROPONENT, THE CONSERVATION AUTHORITY, AND

- 4. EROSION AND SEDIMENT CONTROLS MAY REQUIRE PERIODIC ADJUSTMENTS TO REFLECT CHANGING SITE CONDITIONS. THE CONTRACTOR WILL BE RESPONSIBLE FOR THESE ADJUSTMENTS TO ENSURE PROPER
- 5. ANY CHANGES TO THE EROSION AND SEDIMENT CONTROL PLAN BEYOND MINOR ADJUSTMENTS MUST BE APPROVED BY THE CONTRACT ADMINISTRATOR.
- 6. ADDITIONAL EROSION AND SEDIMENT CONTROL SUPPLIES MUST BE KEPT ON SITE IN ORDER TO FACILITATE IMMEDIATE REPAIRS AND/OR UPGRADES AS NEEDED.
- 7. ALL TEMPORARY SEDIMENT CONTROLS MUST BE REMOVED AFTER THE CONTRACT ADMINISTRATOR DEEMS THE
- 8. THE PROJECT PROPONENT OR THEIR REPRESENTATIVE IS ULTIMATELY RESPONSIBLE FOR CONTROLLING SEDIMENT AND EROSION WITHIN THE CONSTRUCTION SITE FOR THE TOTAL PERIOD OF THE CONSTRUCTION.
- 9. IF EXCESSIVE SILTATION RESULTS FROM THE CONSTRUCTION ACTIVITIES, THE ONSITE SUPERVISOR/INSPECTOR AND/OR THE LOCAL REGULATORY BODY RESERVE THE RIGHT TO REQUEST ADDITIONAL ESC MEASURES WHICH WOULD BE INSTALLED PRIOR TO FURTHER CONSTRUCTION ACTIVITIES.

DELETERIOUS SUBSTANCE CONTROL/SPILL MANAGEMENT

PREVENT THE RELEASE OF SEDIMENT, SEDIMENT-LADEN WATER, RAW CONCRETE, CONCRETE LEACHATE OR ANY OTHER DELETERIOUS SUBSTANCES INTO ANY WATERBODY, RAVINE OR STORM SEWER SYSTEM.

EITHER SIDES OF THE WATERCOURSE OR WETLAND.

- 2. ENSURE EQUIPMENT AND MACHINERY ARE IN GOOD OPERATING CONDITION (POWER WASHED), FREE OF LEAKS, EXCESS OIL, AND GREASE.

 3. NO EQUIPMENT REFUELLING OR SERVICING SHOULD BE UNDERTAKEN WITHIN 30 m OF ANY WATERCOURSE OR
- SURFACE WATER DRAINAGE. A SPILL CONTAINMENT KIT MUST BE READILY ACCESSIBLE ON SITE IN THE EVENT OF A RELEASE OF A DELETERIOUS SUBSTANCE TO THE ENVIRONMENT. ONSITE STAFF MUST BE TRAINED IN ITS USE.
- 5. THE CONTRACT ADMINISTRATOR MUST BE NOTIFIED IMMEDIATELY IN THE EVENT OF A SPILL OF DELETERIOUS
- SUBSTANCE. ANY SEDIMENT SPILL FROM THE SITE SHOULD BE REPORTED TO MINISTRY OF ENVIRONMENT (SPILL ACTION CENTER) AT 1-800-268-6060.

WORK AREA ISOLATION

- 1. ALL WORK IN ISOLATED WORK AREAS MUST BE COMPLETED IN THE DRY. AN ADEQUATE NUMBER OF PUMPS MUST BE USED FOR UNWATERING.
 2. CROSSING AN ACTIVE WATERCOURSE OR WETLAND BY EQUIPMENT, VEHICLES, PERSONNEL, ETC. IS NOT
- PERMITTED UNLESS APPROVED BY THE CONSERVATION AUTHORITY. ALL ACCESS TO WORK SITES SHALL BE FROM
- 3. THE UNWATERING DISCHARGE LOCATION MUST BE LOCATED AT LEAST 30 M FROM ANY WATERCOURSE OR WETLAND IN AN AREA WITH DENSE VEGETATIVE GROUNDCOVER, AND WHERE THE DISCHARGE CAN RETURN TO THE WATERBODY DOWNSTREAM OF THE WORK AREA OVER THE GROUNDCOVER.
- 4. FISH MUST BE REMOVED FROM THE WORK AREA ONCE ISOLATED. FISH SALVAGE MUST BE COMPLETED BY A QUALIFIED TECHNICIAN WITH A LICENSE FROM THE ONTARIO MINISTRY OF NATURAL RESOURCES AND FORESTRY

	DATE	BY	REVISIONS
DESIGNED BY: LD/AS			CHECKED BY: PV

DRAFT FOR INTERNAL DISCUSSION

DRAWN BY: AL/CP/SC

DATE: JUNE 2024


NOT FOR CONSTRUCTION


 $M O R P H I X^{\mathsf{m}}$ 36 Main St N., P.O. Box 205 Campbellville, Ontario L0P 1B0 T: 416.920.0926 www.geomorphix.com

ALLOA SPA TOWN OF CALEDON

ETOBICOKE CREEK - ALLOA DRAIN CONCEPTUAL CHANNEL DESIGN CHANNEL PLANFORM

PROJECT No.: PN24009 DRAWING No.:GEO-14 SHEET 15 OF 35

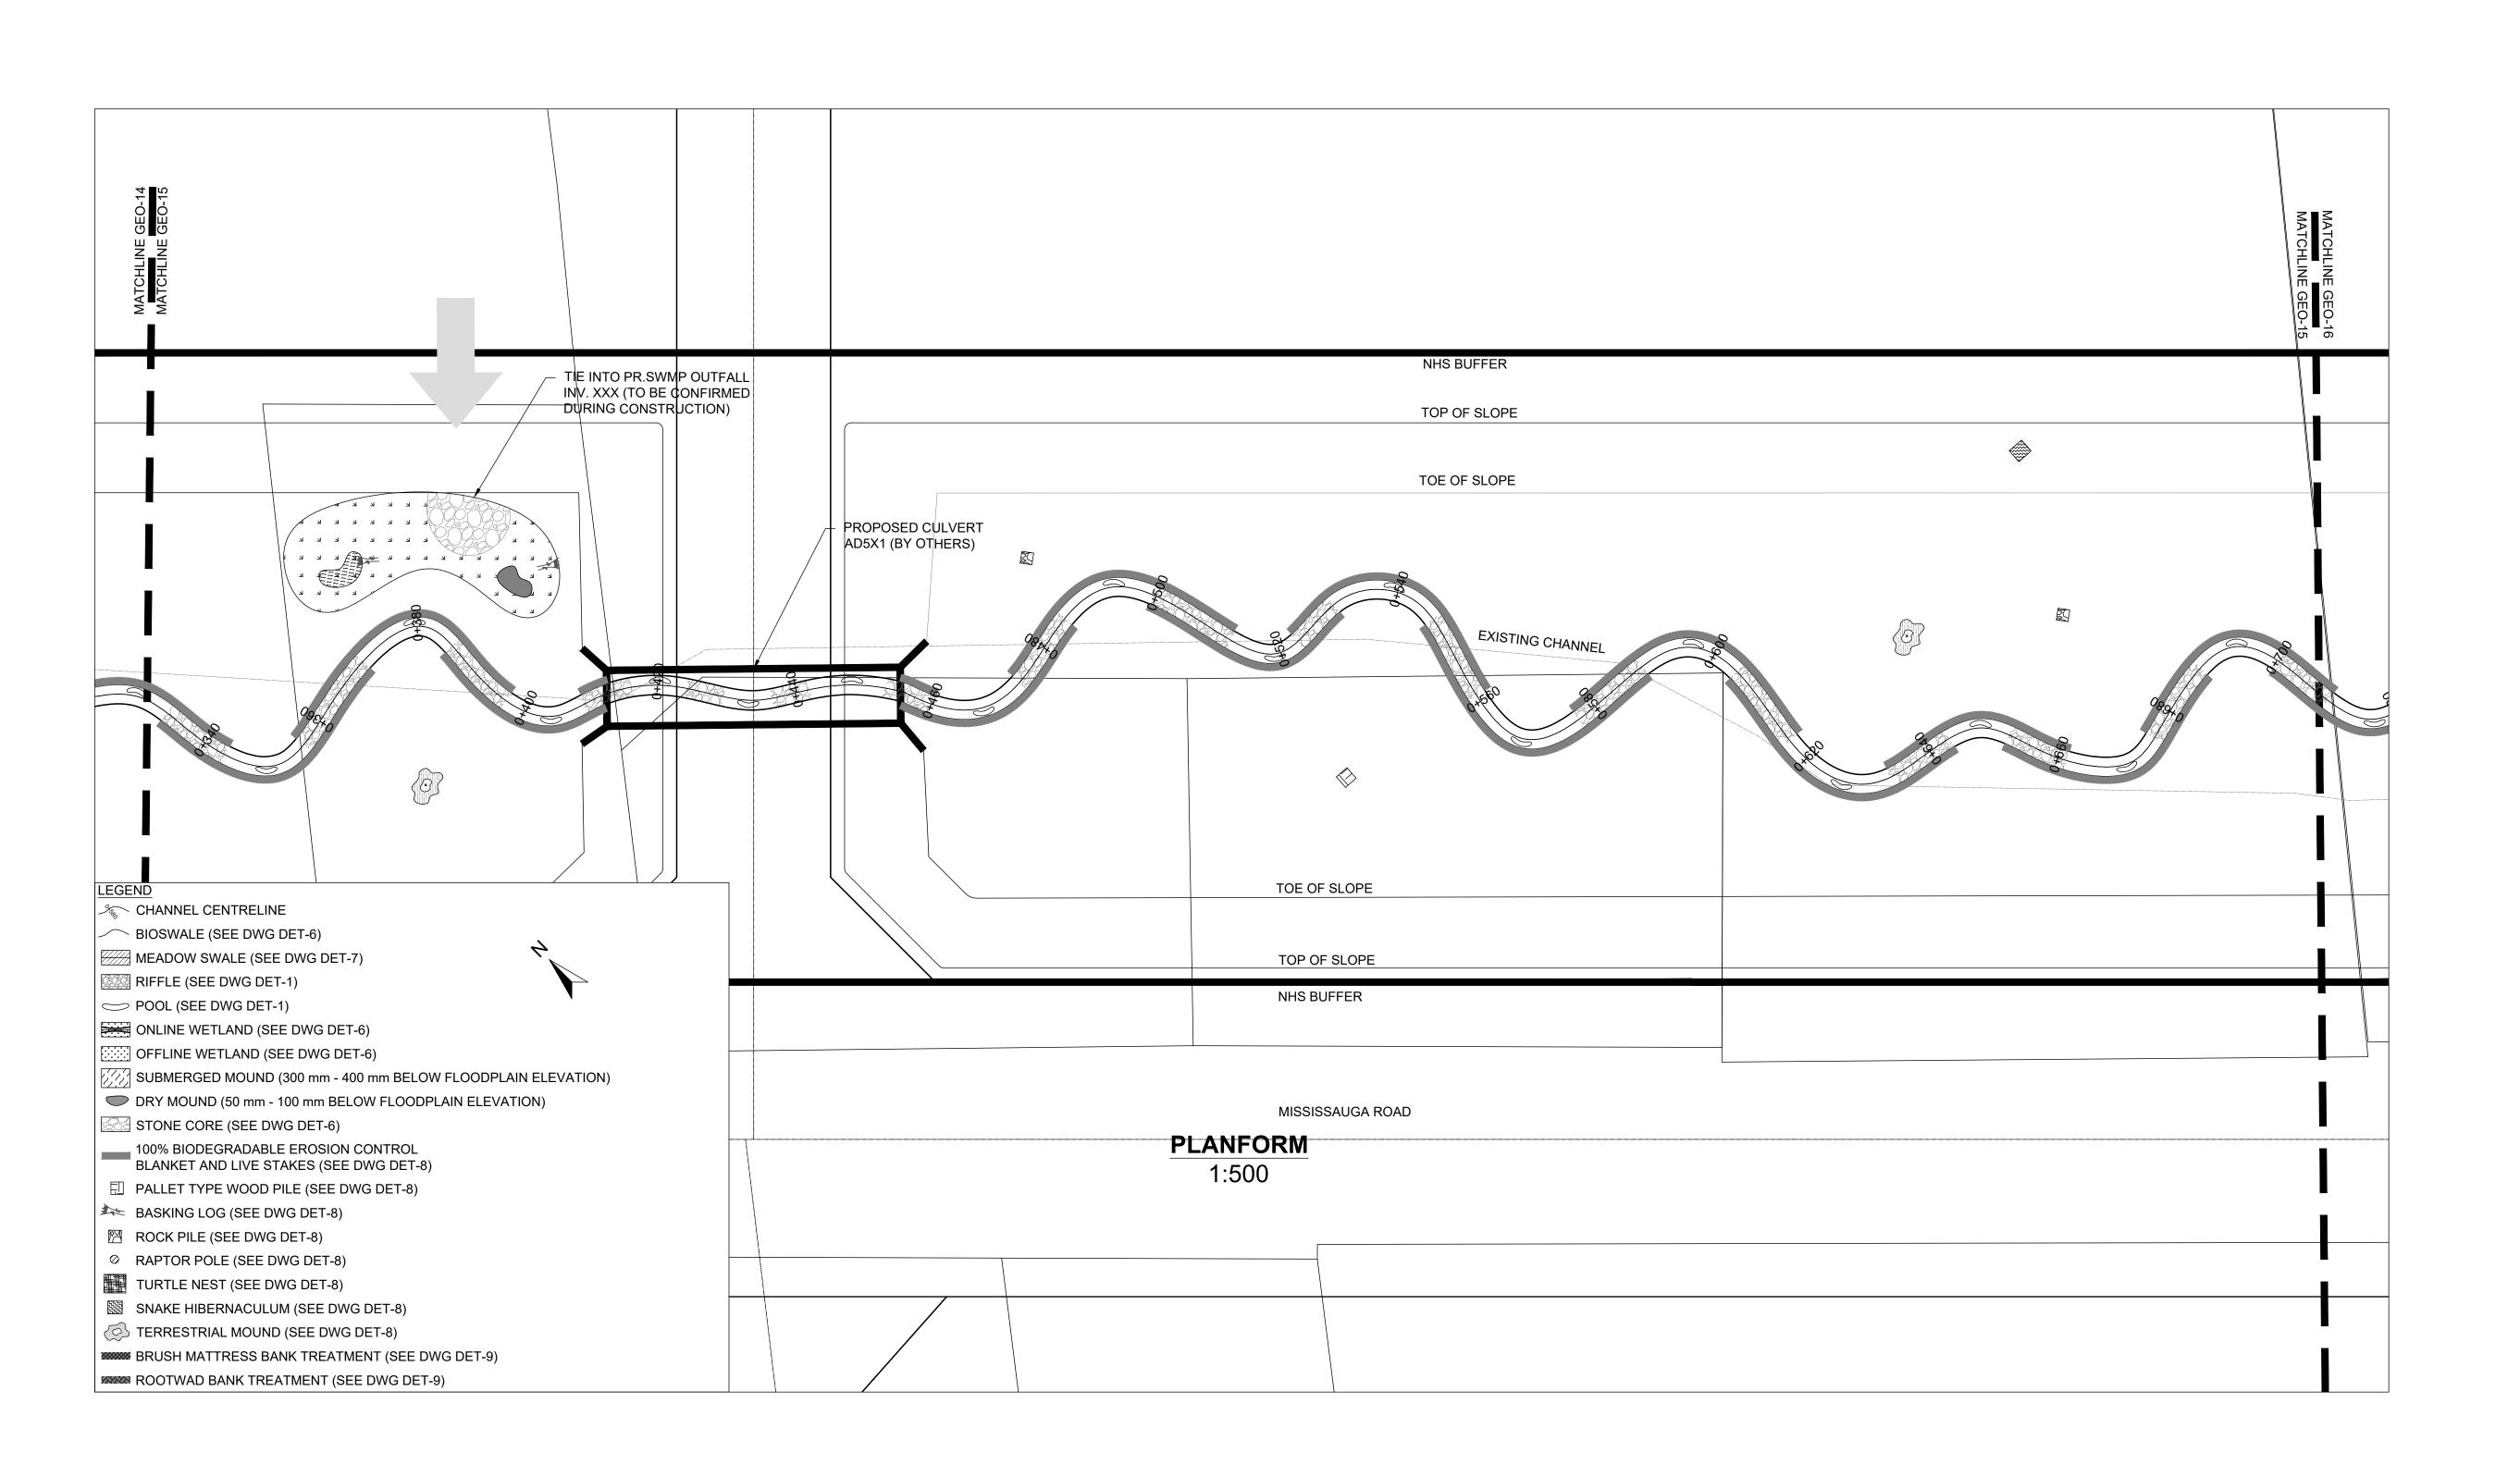

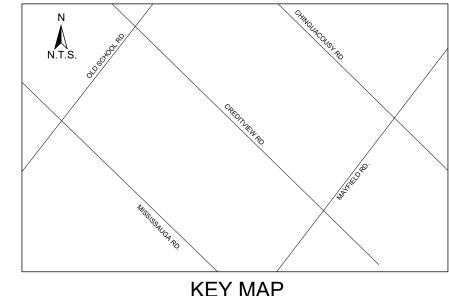

- 1. THE ACCOMPANYING CHANNEL REALIGNMENT TECHNICAL DESIGN BRIEF PREPARED BY GEO MORPHIX LTD. (2023) PROVIDES ADDITIONAL DESIGN DETAILS AND DIRECTION FOR IMPLEMENTATION AND IS TO BE REVIEWED IN CONJUNCTION WITH THIS DRAWING SET.
- 2. ALL CONTRACT DRAWINGS, SPECIFICATIONS AND APPLICABLE PERMITS MUST BE KEPT ON SITE DURING
- CONSTRUCTION FOR REFERENCE.

 3. THE CONTRACTOR MUST NOTIFY THE DESIGNER AND CONTRACT ADMINISTRATOR OF THE INTENT TO COMMENCE WORK AT LEAST 48 HOURS IN ADVANCE.
- 4. THE CONTRACTOR IS RESPONSIBLE FOR ALL UTILITY LOCATES.
 5. LAYOUT MUST BE REVIEWED AND APPROVED BY THE DESIGNER / DESIGNER REPRESENTATIVE, DESIGNATED
- ENGINEER, AND THE CONTRACT ADMINISTRATOR.
- CONSTRUCTION OBSERVATION IS TO BE PERFORMED BY A CERTIFIED FLUVIAL GEOMORPHOLOGIST OR EXPERIENCED ENVIRONMENTAL INSPECTOR UNDER DIRECTION FROM THE DESIGNER.
- 7. ON-SITE SUPPORT FROM PROJECT ENGINEER (E.G., GEOTECHNICAL, HYDROGEOLOGICAL, AND/OR WATER RESOURCES ENGINEER) REQUIRED TO ASSESS AND ENSURE FAVOURABLE SURFICIAL AND SUBSURFACE CONDITIONS TO SUPPORT CHANNEL REALIGNMENT CONSTRUCTION.
- 8. BE ADVISED THAT THE LOCAL REGULATORY BODY MAY, AT ANY TIME, WITHDRAW THIS PERMISSION, IF, IN THE OPINION OF THE AUTHORITY. THE CONDITIONS OF THE PERMIT ARE NOT BEING COMPLIED WITH. THIS APPROVAL DOES NOT EXEMPT THE PROPERTY OWNER/APPLICANT/AGENT FROM THE PROVISIONS OF ANY OTHER FEDERAL,

TIMING OF WORKS

- 1. WORKS SHALL BE COMPLETED DURING THE DESIGNATED IN-WATER WORKS WINDOW SET OUT BY MNRF/DFO. 2. TREE CLEARING IS TO BE COMPLETED OUTSIDE THE BIRD NESTING SEASON (APRIL 1ST TO AUGUST 1ST) TO COMPLY WITH THE FEDERAL MIGRATORY BIRDS CONVENTION ACT. ANY TREES THAT REQUIRE REMOVAL OUTSIDE
- OF THIS TIMING WINDOW MUST FIRST BE INSPECTED BY A QUALIFIED BIOLOGIST TO DETERMINE THE PRESENCE OF

PROVINCIAL OR MUNICIPAL STATUTES, REGULATIONS OR BY-LAWS, OR ANY RIGHTS UNDER COMMON LAW.

- 3. THE WEATHER FORECAST SHOULD BE CONTINUALLY MONITORED TO ENSURE THAT WORKS ARE UNDERTAKEN ONLY DURING FAVOURABLE WEATHER CONDITIONS.
- 4. COMPLETE THE WORKS WITH MINIMAL AVOIDABLE INTERRUPTIONS ONCE THEY COMMENCE.

SITE AND MATERIAL MANAGEMENT

- 1. ALL CONSTRUCTION EQUIPMENT AND MATERIALS (IMPORTED OR EXCAVATED) MUST BE STORED AT LEAST 30 m AWAY FROM ANY WATERBODY IN A STABLE AREA ABOVE THE ACTIVE FLOODPLAIN, OR IN A DESIGNATED
- 2. IN THE EVENT OF AN UNEXPECTED STORM, ALL UNFIXED ITEMS THAT HAVE THE POTENTIAL TO CAUSE A SPILL OR AN OBSTRUCTION TO FLOW MUST BE MOVED A STABLE AREA ABOVE ACTIVE FLOODPLAIN. 3. STOCKPILES MUST BE LOCATED OUTSIDE THE ISOLATED WORK AREAS.
- 4. STABILIZE, TEMPORARILY OR PERMANENTLY, ANY DISTURBED AREAS AS WORK PROGRESSES, OR SOON AS CONDITIONS ALLOW.
- 5. MINIMIZE THE AREA OF DISTURBANCE TO THE EXTENT POSSIBLE. ALL DISTURBED GROUND LEFT INACTIVE FOR MORE THAN 30 DAYS SHALL BE STABILIZED USING APPROPRIATE EROSION CONTROL MEASURES AND AN APPROPRIATE SEED MIX AS NOTED WITHIN THE FINAL APPROVED RESTORATION PLAN.
- 6. ALL VEGETATION, ADJACENT TO THE WORK AREA, MUST BE PROTECTED AND DELINEATED WITH CONSTRUCTION FENCING OR TREE PROTECTION BARRIERS.
- 7. ALL GRADES IN THE AREA REGULATED BY THE CONSERVATION AUTHORITY MUST BE MAINTAINED OR MATCHED,
- UNLESS OTHERWISE AUTHORIZED IN THE APPLICABLE PERMIT.

 8. AN AFTER-HOURS CONTACT NUMBER IS TO BE VISIBLY POSTED ONSITE FOR EMERGENCIES. ALL THE PLANS SHOULD HAVE NAME AND CONTACT INFO OF THE PERSON RESPONSIBLE FOR ESC MEASURES.

EROSION AND SEDIMENT CONTROL

- ALL TEMPORARY EROSION AND SEDIMENT CONTROL MEASURES MUST BE INSTALLED PRIOR TO START OF WORKS.
 FOLLOWING INSTALLATION OF THE PROPOSED ESC MEASURES, A QUALIFIED AGENT OF THE PROPONENT (E.G. CAN-CISEC CERTIFIED MONITOR) WILL CONDUCT REGULAR SITÉ VISITS TO MONITOR ALL WORKS, PARTICULARLY THE CONDITION OF THE ESC MEASURES, DEWATERING, AND IN- OR NEAR-WATER WORKS. SHOULD CONCERNS ARISE; THE ENVIRONMENTAL MONITOR WILL CONTACT THE PROPONENT, THE CONSERVATION AUTHORITY, AND
- ANY OTHER APPROPRIATE PARTIES. 3. EROSION AND SEDIMENT CONTROLS MUST BE MAINTAINED DURING CONSTRUCTION, AND ANY REQUIRED REPAIRS OR REPLACEMENTS MUST BE COMPLETED WITHIN 24 HOURS AFTER THEY HAVE BEEN IDENTIFIED DURING THE
- 4 FROSION AND SEDIMENT CONTROLS MAY REQUIRE PERIODIC ADJUSTMENTS TO REFLECT CHANGING SITE CONDITIONS. THE CONTRACTOR WILL BE RESPONSIBLE FOR THESE ADJUSTMENTS TO ENSURE PROPER
- ANY CHANGES TO THE EROSION AND SEDIMENT CONTROL PLAN BEYOND MINOR ADJUSTMENTS MUST BE APPROVED BY THE CONTRACT ADMINISTRATOR.
- 6. ADDITIONAL EROSION AND SEDIMENT CONTROL SUPPLIES MUST BE KEPT ON SITE IN ORDER TO FACILITATE IMMEDIATE REPAIRS AND/OR UPGRADES AS NEEDED.
- 7. ALL TEMPORARY SEDIMENT CONTROLS MUST BE REMOVED AFTER THE CONTRACT ADMINISTRATOR DEEMS THE 8. THE PROJECT PROPONENT OR THEIR REPRESENTATIVE IS ULTIMATELY RESPONSIBLE FOR CONTROLLING
- SEDIMENT AND EROSION WITHIN THE CONSTRUCTION SITE FOR THE TOTAL PERIOD OF THE CONSTRUCTION. 9. IF EXCESSIVE SILTATION RESULTS FROM THE CONSTRUCTION ACTIVITIES, THE ONSITE SUPERVISOR/INSPECTOR
- AND/OR THE LOCAL REGULATORY BODY RESERVE THE RIGHT TO REQUEST ADDITIONAL ESC MEASURES WHICH WOULD BE INSTALLED PRIOR TO FURTHER CONSTRUCTION ACTIVITIES.

DELETERIOUS SUBSTANCE CONTROL/SPILL MANAGEMENT

- 1. PREVENT THE RELEASE OF SEDIMENT, SEDIMENT-LADEN WATER, RAW CONCRETE, CONCRETE LEACHATE OR ANY OTHER DELETERIOUS SUBSTANCES INTO ANY WATERBODY, RAVINE OR STORM SEWER SYSTEM. 2. ENSURE EQUIPMENT AND MACHINERY ARE IN GOOD OPERATING CONDITION (POWER WASHED), FREE OF LEAKS,
- EXCESS OIL, AND GREASE.

 3. NO EQUIPMENT REFUELLING OR SERVICING SHOULD BE UNDERTAKEN WITHIN 30 m OF ANY WATERCOURSE OR SURFACE WATER DRAINAGE.
- A SPILL CONTAINMENT KIT MUST BE READILY ACCESSIBLE ON SITE IN THE EVENT OF A RELEASE OF A DELETERIOUS SUBSTANCE TO THE ENVIRONMENT. ONSITE STAFF MUST BE TRAINED IN ITS USE.
- 5. THE CONTRACT ADMINISTRATOR MUST BE NOTIFIED IMMEDIATELY IN THE EVENT OF A SPILL OF DELETERIOUS SUBSTANCE. ANY SEDIMENT SPILL FROM THE SITE SHOULD BE REPORTED TO MINISTRY OF ENVIRONMENT (SPILL ACTION CENTER) AT 1-800-268-6060.

WORK AREA ISOLATION

- 1. ALL WORK IN ISOLATED WORK AREAS MUST BE COMPLETED IN THE DRY. AN ADEQUATE NUMBER OF PUMPS MUST BE USED FOR UNWATERING.

 CROSSING AN ACTIVE WATERCOURSE OR WETLAND BY EQUIPMENT, VEHICLES, PERSONNEL, ETC. IS NOT
- PERMITTED UNLESS APPROVED BY THE CONSERVATION AUTHORITY. ALL ACCESS TO WORK SITES SHALL BE FROM
- EITHER SIDES OF THE WATERCOURSE OR WETLAND. 3. THE UNWATERING DISCHARGE LOCATION MUST BE LOCATED AT LEAST 30 M FROM ANY WATERCOURSE OR WETLAND IN AN AREA WITH DENSE VEGETATIVE GROUNDCOVER, AND WHERE THE DISCHARGE CAN RETURN TO
- THE WATERBODY DOWNSTREAM OF THE WORK AREA OVER THE GROUNDCOVER. 4. FISH MUST BE REMOVED FROM THE WORK AREA ONCE ISOLATED. FISH SALVAGE MUST BE COMPLETED BY A QUALIFIED TECHNICIAN WITH A LICENSE FROM THE ONTARIO MINISTRY OF NATURAL RESOURCES AND FORESTRY

	DATE BY		REVISIONS	
DESIG	SNED BY: LD/A	S	CHECKED BY: PV	
DRAW	/N BY: AL/CP/S	SC	DATE: JUNE 2024	

DRAFT FOR INTERNAL DISCUSSION $M O R P H I X^{\mathsf{m}}$

NOT FOR CONSTRUCTION

36 Main St N., P.O. Box 205 Campbellville, Ontario L0P 1B0 T: 416.920.0926 www.geomorphix.com


ALLOA SPA TOWN OF CALEDON


SHEET 16 OF 35

ETOBICOKE CREEK - ALLOA DRAIN CONCEPTUAL CHANNEL DESIGN

CHANNEL PLANFORM

PROJECT No.: PN24009 DRAWING No.: GEO-15

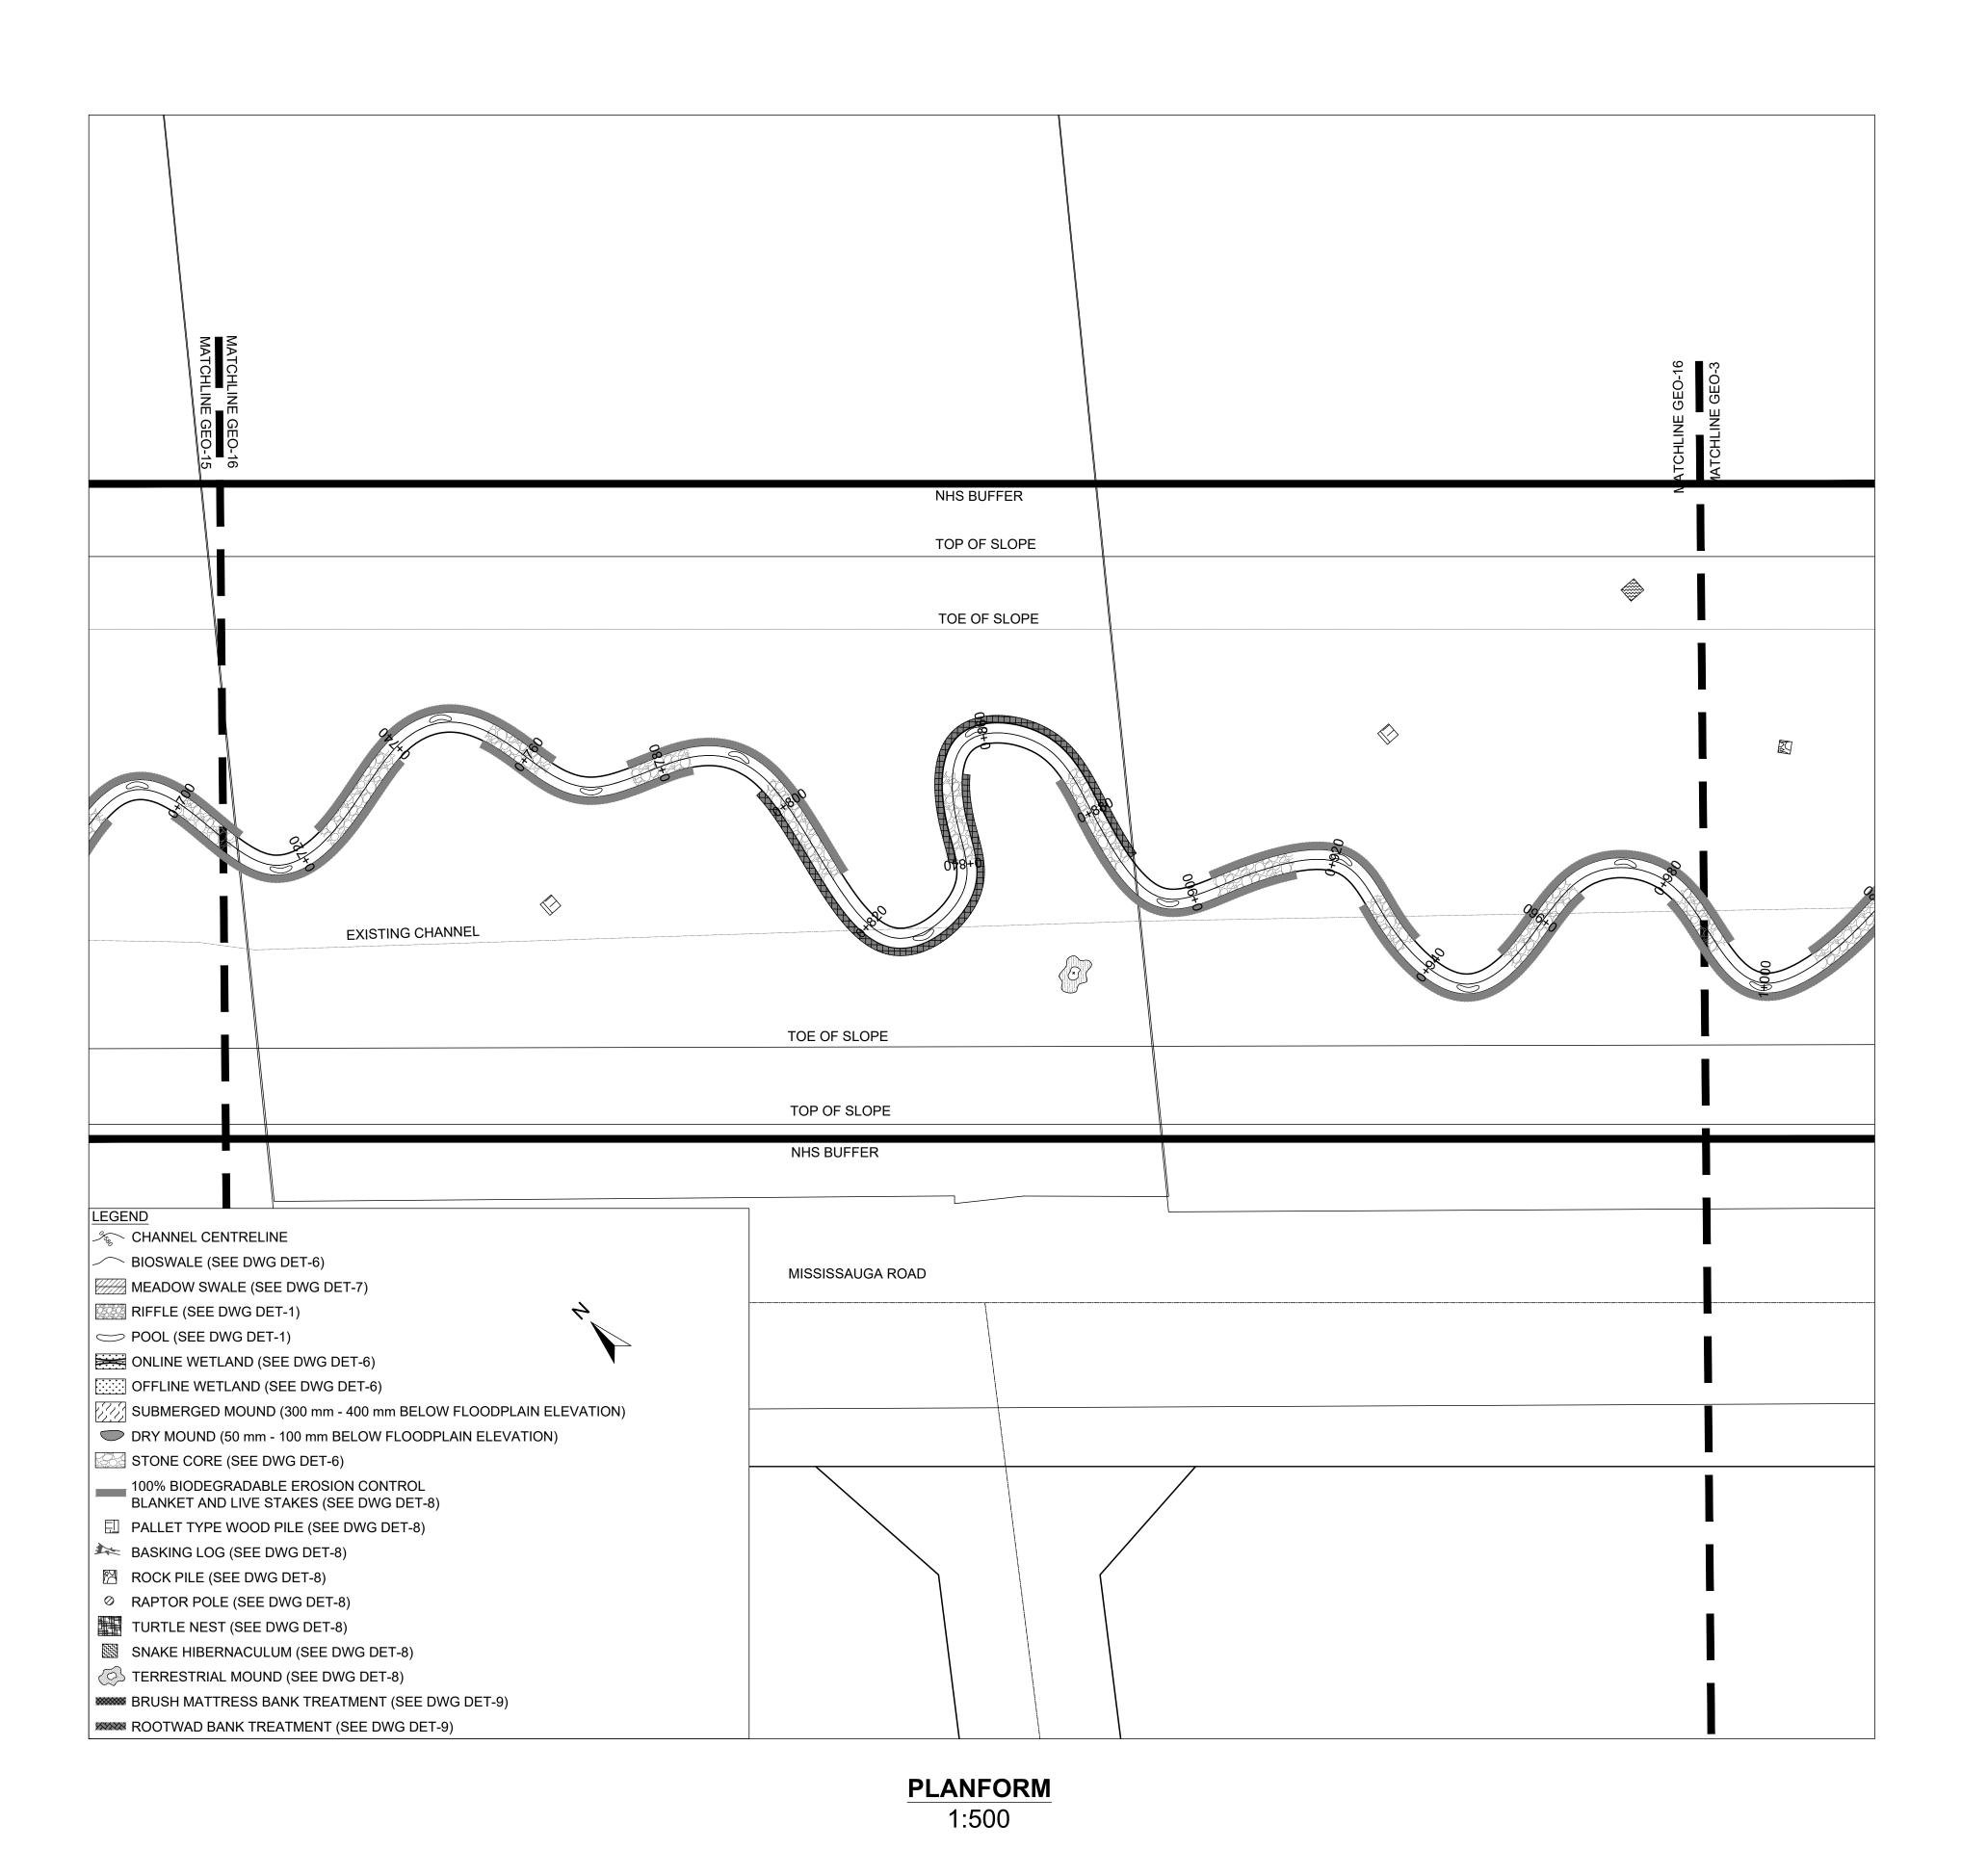

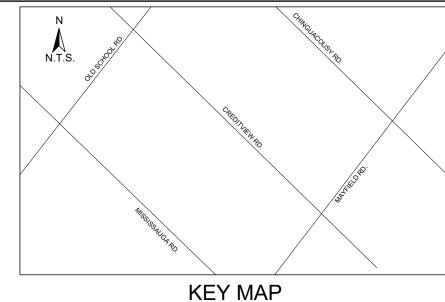

- 1. THE ACCOMPANYING CHANNEL REALIGNMENT TECHNICAL DESIGN BRIEF PREPARED BY GEO MORPHIX LTD. (2023) PROVIDES ADDITIONAL DESIGN DETAILS AND DIRECTION FOR IMPLEMENTATION AND IS TO BE REVIEWED IN CONJUNCTION WITH THIS DRAWING SET.
- 2. ALL CONTRACT DRAWINGS, SPECIFICATIONS AND APPLICABLE PERMITS MUST BE KEPT ON SITE DURING CONSTRUCTION FOR REFERENCE.

 3. THE CONTRACTOR MUST NOTIFY THE DESIGNER AND CONTRACT ADMINISTRATOR OF THE INTENT TO COMMENCE
- WORK AT LEAST 48 HOURS IN ADVANCE.
- 4. THE CONTRACTOR IS RESPONSIBLE FOR ALL UTILITY LOCATES.
 5. LAYOUT MUST BE REVIEWED AND APPROVED BY THE DESIGNER / DESIGNER REPRESENTATIVE, DESIGNATED ENGINEER, AND THE CONTRACT ADMINISTRATOR.
- CONSTRUCTION OBSERVATION IS TO BE PERFORMED BY A CERTIFIED FLUVIAL GEOMORPHOLOGIST OR EXPERIENCED ENVIRONMENTAL INSPECTOR UNDER DIRECTION FROM THE DESIGNER.
- 7. ON-SITE SUPPORT FROM PROJECT ENGINEER (E.G., GEOTECHNICAL, HYDROGEOLOGICAL, AND/OR WATER RESOURCES ENGINEER) REQUIRED TO ASSESS AND ENSURE FAVOURABLE SURFICIAL AND SUBSURFACE
- CONDITIONS TO SUPPORT CHANNEL REALIGNMENT CONSTRUCTION. 8. BE ADVISED THAT THE LOCAL REGULATORY BODY MAY, AT ANY TIME, WITHDRAW THIS PERMISSION, IF, IN THE OPINION OF THE AUTHORITY, THE CONDITIONS OF THE PERMIT ARE NOT BEING COMPLIED WITH. THIS APPROVAL

DOES NOT EXEMPT THE PROPERTY OWNER/APPLICANT/AGENT FROM THE PROVISIONS OF ANY OTHER FEDERAL, PROVINCIAL OR MUNICIPAL STATUTES, REGULATIONS OR BY-LAWS, OR ANY RIGHTS UNDER COMMON LAW.

- 1. WORKS SHALL BE COMPLETED DURING THE DESIGNATED IN-WATER WORKS WINDOW SET OUT BY MNRF/DFO. 2. TREE CLEARING IS TO BE COMPLETED OUTSIDE THE BIRD NESTING SEASON (APRIL 1ST TO AUGUST 1ST) TO COMPLY WITH THE FEDERAL MIGRATORY BIRDS CONVENTION ACT. ANY TREES THAT REQUIRE REMOVAL OUTSIDE OF THIS TIMING WINDOW MUST FIRST BE INSPECTED BY A QUALIFIED BIOLOGIST TO DETERMINE THE PRESENCE OF
- 3. THE WEATHER FORECAST SHOULD BE CONTINUALLY MONITORED TO ENSURE THAT WORKS ARE UNDERTAKEN
- ONLY DURING FAVOURABLE WEATHER CONDITIONS 4. COMPLETE THE WORKS WITH MINIMAL AVOIDABLE INTERRUPTIONS ONCE THEY COMMENCE.

SITE AND MATERIAL MANAGEMENT

- 1. ALL CONSTRUCTION EQUIPMENT AND MATERIALS (IMPORTED OR EXCAVATED) MUST BE STORED AT LEAST 30 m
- AWAY FROM ANY WATERBODY IN A STABLE AREA ABOVE THE ACTIVE FLOODPLAIN, OR IN A DESIGNATED
- 2. IN THE EVENT OF AN UNEXPECTED STORM, ALL UNFIXED ITEMS THAT HAVE THE POTENTIAL TO CAUSE A SPILL OR AN OBSTRUCTION TO FLOW MUST BE MOVED A STABLE AREA ABOVE ACTIVE FLOODPLAIN. 3. STOCKPILES MUST BE LOCATED OUTSIDE THE ISOLATED WORK AREAS. 4. STABILIZE, TEMPORARILY OR PERMANENTLY, ANY DISTURBED AREAS AS WORK PROGRESSES, OR SOON AS
- CONDITIONS ALLOW. 5. MINIMIZE THE AREA OF DISTURBANCE TO THE EXTENT POSSIBLE. ALL DISTURBED GROUND LEFT INACTIVE FOR MORE THAN 30 DAYS SHALL BE STABILIZED USING APPROPRIATE EROSION CONTROL MEASURES AND AN
- APPROPRIATE SEED MIX AS NOTED WITHIN THE FINAL APPROVED RESTORATION PLAN. 6. ALL VEGETATION, ADJACENT TO THE WORK AREA, MUST BE PROTECTED AND DELINEATED WITH CONSTRUCTION
- FENCING OR TREE PROTECTION BARRIERS. 7. ALL GRADES IN THE AREA REGULATED BY THE CONSERVATION AUTHORITY MUST BE MAINTAINED OR MATCHED,
- UNLESS OTHERWISE AUTHORIZED IN THE APPLICABLE PERMIT.

 8. AN AFTER-HOURS CONTACT NUMBER IS TO BE VISIBLY POSTED ONSITE FOR EMERGENCIES. ALL THE PLANS
- SHOULD HAVE NAME AND CONTACT INFO OF THE PERSON RESPONSIBLE FOR ESC MEASURES.

EROSION AND SEDIMENT CONTROL

- ALL TEMPORARY EROSION AND SEDIMENT CONTROL MEASURES MUST BE INSTALLED PRIOR TO START OF WORKS.
 FOLLOWING INSTALLATION OF THE PROPOSED ESC MEASURES, A QUALIFIED AGENT OF THE PROPONENT (E.G. CAN-CISEC CERTIFIED MONITOR) WILL CONDUCT REGULAR SITÉ VISITS TO MONITOR ALL WORKS, PARTICULARLY THE CONDITION OF THE ESC MEASURES, DEWATERING, AND IN- OR NEAR-WATER WORKS. SHOULD CONCERNS ARISE; THE ENVIRONMENTAL MONITOR WILL CONTACT THE PROPONENT, THE CONSERVATION AUTHORITY, AND
- 3. EROSION AND SEDIMENT CONTROLS MUST BE MAINTAINED DURING CONSTRUCTION, AND ANY REQUIRED REPAIRS OR REPLACEMENTS MUST BE COMPLETED WITHIN 24 HOURS AFTER THEY HAVE BEEN IDENTIFIED DURING THE
- 4. EROSION AND SEDIMENT CONTROLS MAY REQUIRE PERIODIC ADJUSTMENTS TO REFLECT CHANGING SITE CONDITIONS. THE CONTRACTOR WILL BE RESPONSIBLE FOR THESE ADJUSTMENTS TO ENSURE PROPER
- ANY CHANGES TO THE EROSION AND SEDIMENT CONTROL PLAN BEYOND MINOR ADJUSTMENTS MUST BE APPROVED BY THE CONTRACT ADMINISTRATOR.
- 6. ADDITIONAL EROSION AND SEDIMENT CONTROL SUPPLIES MUST BE KEPT ON SITE IN ORDER TO FACILITATE IMMEDIATE REPAIRS AND/OR UPGRADES AS NEEDED.
- 7. ALL TEMPORARY SEDIMENT CONTROLS MUST BE REMOVED AFTER THE CONTRACT ADMINISTRATOR DEEMS THE
- 8. THE PROJECT PROPONENT OR THEIR REPRESENTATIVE IS ULTIMATELY RESPONSIBLE FOR CONTROLLING SEDIMENT AND EROSION WITHIN THE CONSTRUCTION SITE FOR THE TOTAL PERIOD OF THE CONSTRUCTION.
- 9. IF EXCESSIVE SILTATION RESULTS FROM THE CONSTRUCTION ACTIVITIES, THE ONSITE SUPERVISOR/INSPECTOR AND/OR THE LOCAL REGULATORY BODY RESERVE THE RIGHT TO REQUEST ADDITIONAL ESC MEASURES WHICH WOULD BE INSTALLED PRIOR TO FURTHER CONSTRUCTION ACTIVITIES.

DELETERIOUS SUBSTANCE CONTROL/SPILL MANAGEMENT

- PREVENT THE RELEASE OF SEDIMENT, SEDIMENT-LADEN WATER, RAW CONCRETE, CONCRETE LEACHATE OR ANY OTHER DELETERIOUS SUBSTANCES INTO ANY WATERBODY, RAVINE OR STORM SEWER SYSTEM. 2. ENSURE EQUIPMENT AND MACHINERY ARE IN GOOD OPERATING CONDITION (POWER WASHED), FREE OF LEAKS,
- EXCESS OIL, AND GREASE.

 3. NO EQUIPMENT REFUELLING OR SERVICING SHOULD BE UNDERTAKEN WITHIN 30 m OF ANY WATERCOURSE OR SURFACE WATER DRAINAGE.
- A SPILL CONTAINMENT KIT MUST BE READILY ACCESSIBLE ON SITE IN THE EVENT OF A RELEASE OF A
 DELETERIOUS SUBSTANCE TO THE ENVIRONMENT. ONSITE STAFF MUST BE TRAINED IN ITS USE. 5. THE CONTRACT ADMINISTRATOR MUST BE NOTIFIED IMMEDIATELY IN THE EVENT OF A SPILL OF DELETERIOUS
- SUBSTANCE. ANY SEDIMENT SPILL FROM THE SITE SHOULD BE REPORTED TO MINISTRY OF ENVIRONMENT (SPILL ACTION CENTER) AT 1-800-268-6060.

WORK AREA ISOLATION

- 1. ALL WORK IN ISOLATED WORK AREAS MUST BE COMPLETED IN THE DRY. AN ADEQUATE NUMBER OF PUMPS MUST BE USED FOR UNWATERING.
 2. CROSSING AN ACTIVE WATERCOURSE OR WETLAND BY EQUIPMENT, VEHICLES, PERSONNEL, ETC. IS NOT
- PERMITTED UNLESS APPROVED BY THE CONSERVATION AUTHORITY. ALL ACCESS TO WORK SITES SHALL BE FROM
- EITHER SIDES OF THE WATERCOURSE OR WETLAND.

 3. THE UNWATERING DISCHARGE LOCATION MUST BE LOCATED AT LEAST 30 M FROM ANY WATERCOURSE OR WETLAND IN AN AREA WITH DENSE VEGETATIVE GROUNDCOVER, AND WHERE THE DISCHARGE CAN RETURN TO THE WATERBODY DOWNSTREAM OF THE WORK AREA OVER THE GROUNDCOVER.
- 4. FISH MUST BE REMOVED FROM THE WORK AREA ONCE ISOLATED. FISH SALVAGE MUST BE COMPLETED BY A QUALIFIED TECHNICIAN WITH A LICENSE FROM THE ONTARIO MINISTRY OF NATURAL RESOURCES AND FORESTRY

	DATE	BY	REVISIONS
DESIG	SNED BY: LD/A	S	CHECKED BY: PV

DRAWN BY: AL/CP/SC DATE: JUNE 2024

DRAFT FOR **INTERNAL** DISCUSSION

 $M O R P H I X^{\mathsf{m}}$

NOT FOR CONSTRUCTION

36 Main St N., P.O. Box 205 Campbellville, Ontario L0P 1B0 T: 416.920.0926 www.geomorphix.com


ALLOA SPA TOWN OF CALEDON


ETOBICOKE CREEK - ALLOA DRAIN CONCEPTUAL CHANNEL DESIGN CHANNEL PLANFORM

PROJECT No.: PN24009 DRAWING No.: GEO-16

SCALED FOR PLOT ON 'ARCH D' | SCALE: AS NOTED

SHEET 17 OF 35

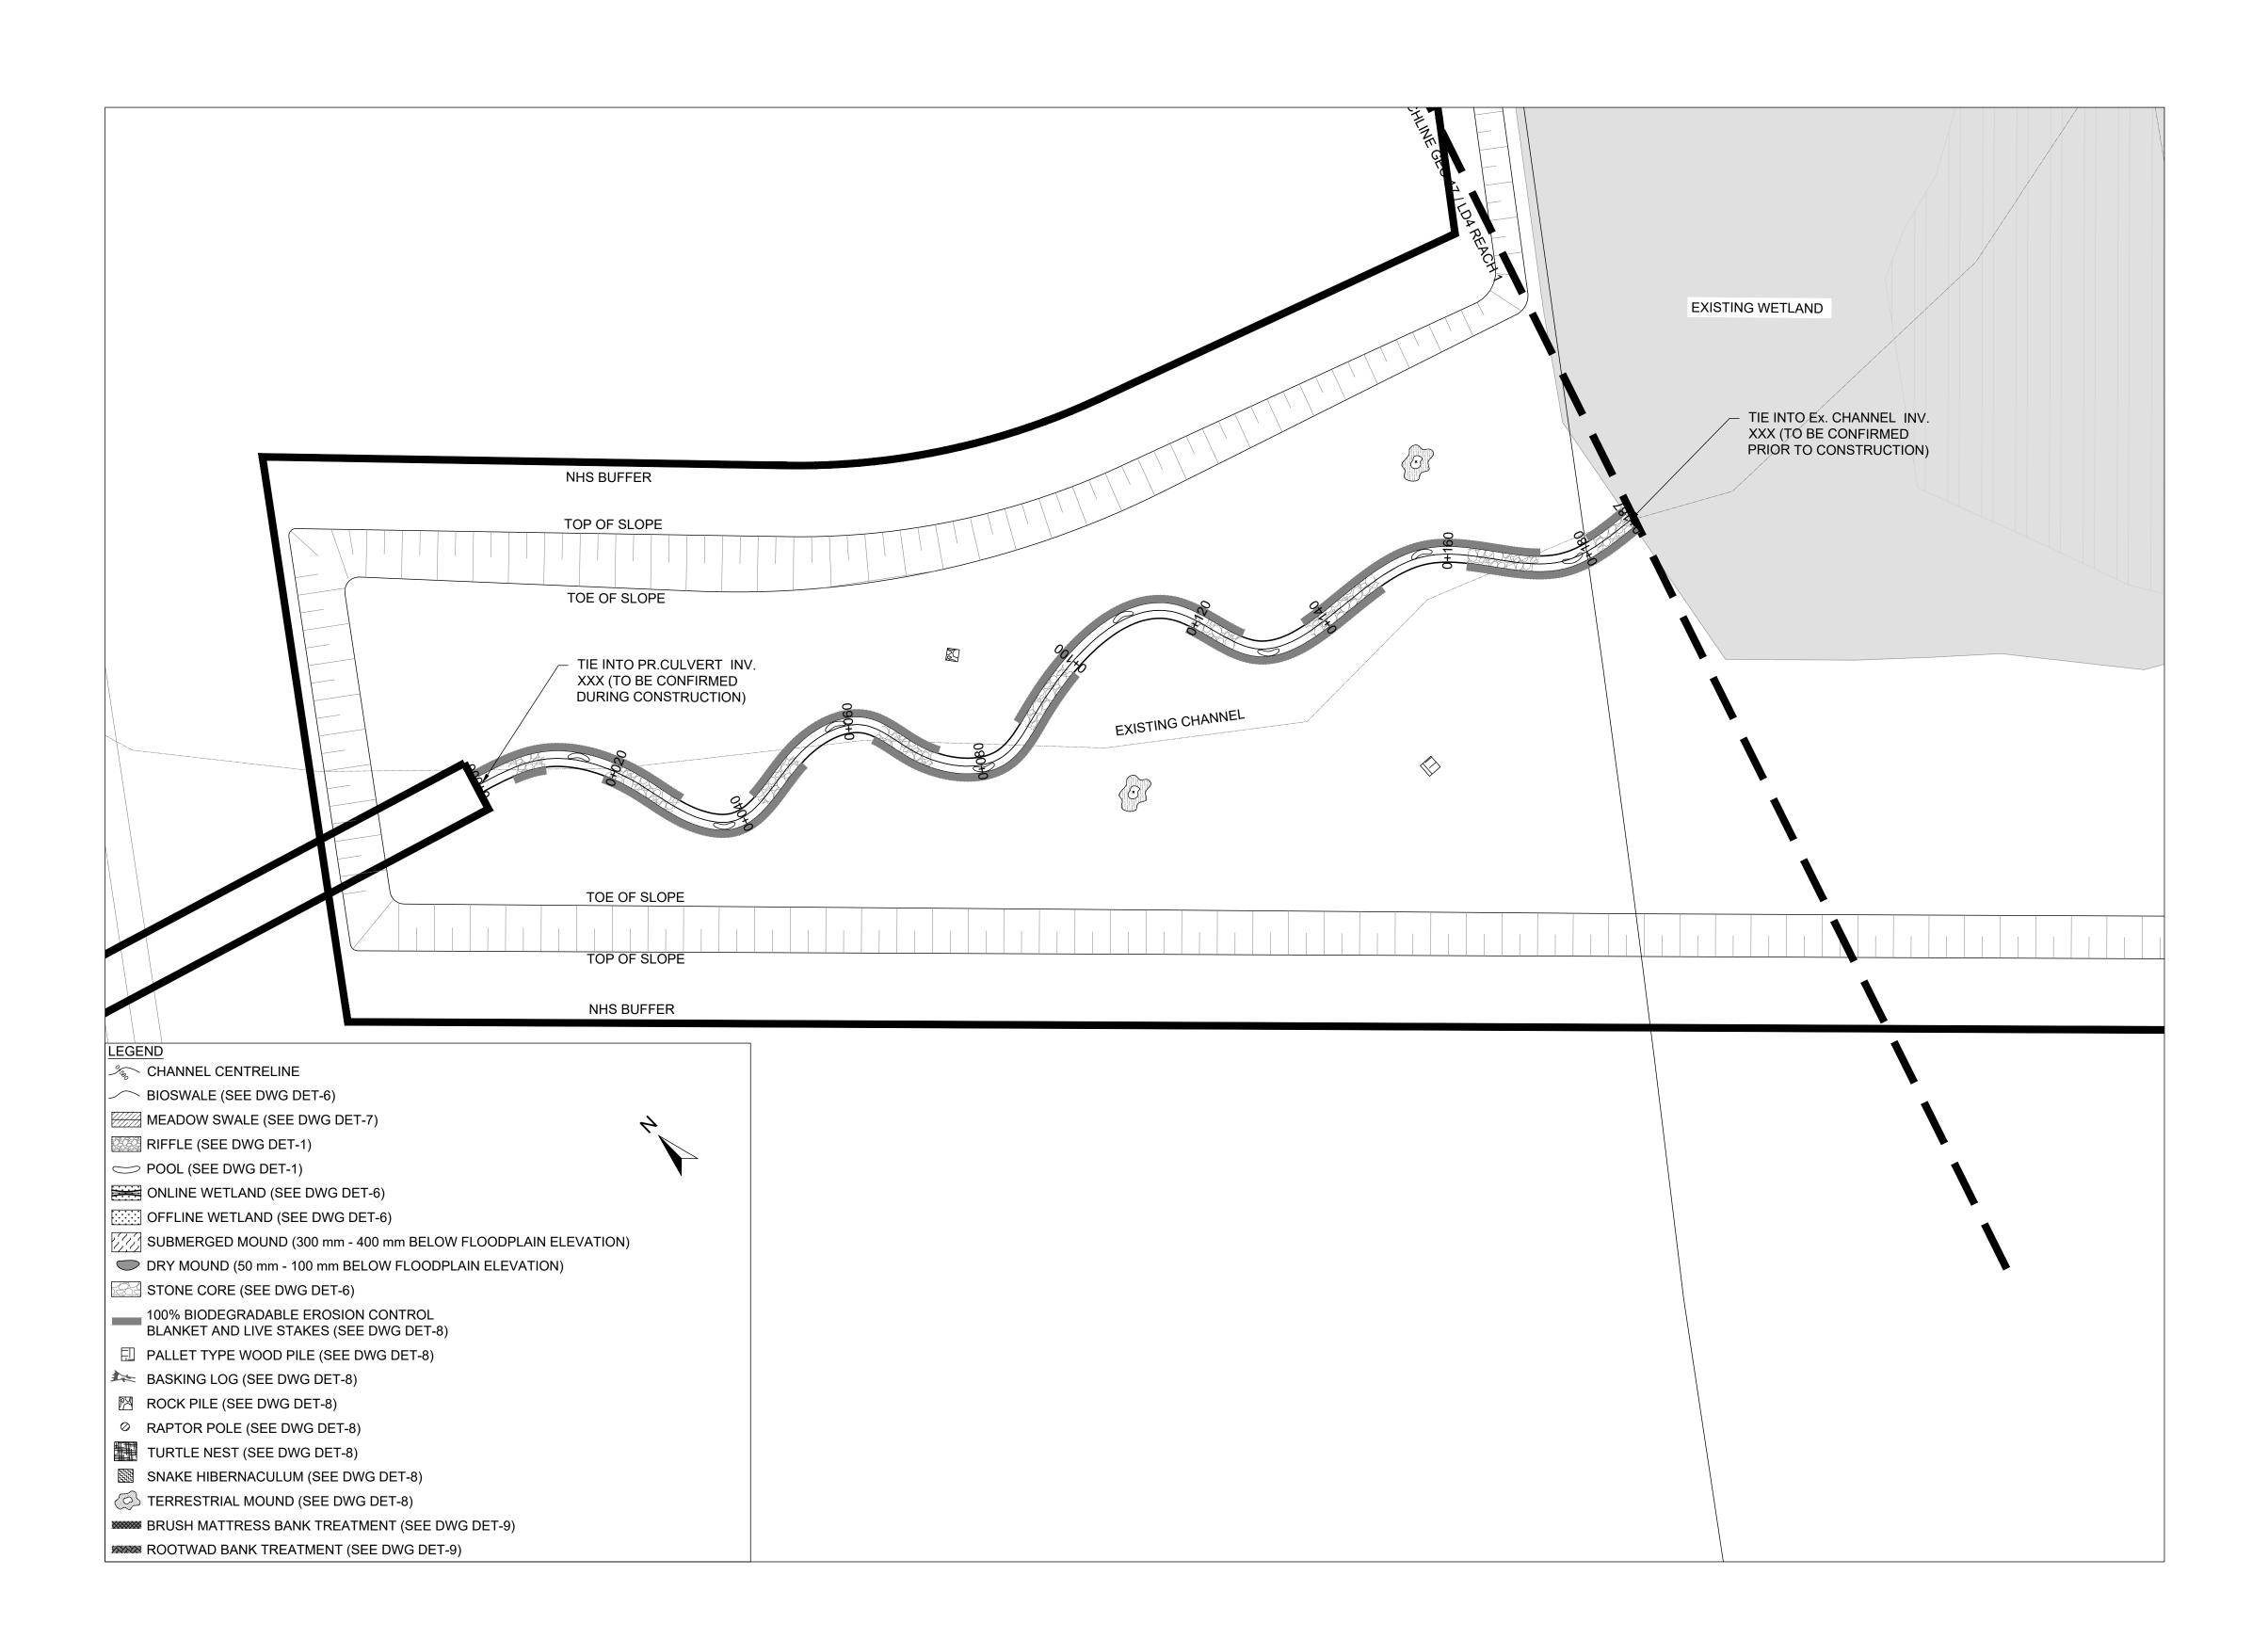

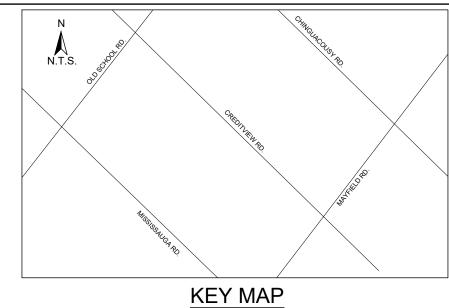

- 1. THE ACCOMPANYING CHANNEL REALIGNMENT TECHNICAL DESIGN BRIEF PREPARED BY GEO MORPHIX LTD. (2023) PROVIDES ADDITIONAL DESIGN DETAILS AND DIRECTION FOR IMPLEMENTATION AND IS TO BE REVIEWED IN CONJUNCTION WITH THIS DRAWING SET.
- 2. ALL CONTRACT DRAWINGS, SPECIFICATIONS AND APPLICABLE PERMITS MUST BE KEPT ON SITE DURING
- CONSTRUCTION FOR REFERENCE.

 3. THE CONTRACTOR MUST NOTIFY THE DESIGNER AND CONTRACT ADMINISTRATOR OF THE INTENT TO COMMENCE WORK AT LEAST 48 HOURS IN ADVANCE.
- 4. THE CONTRACTOR IS RESPONSIBLE FOR ALL UTILITY LOCATES.
 5. LAYOUT MUST BE REVIEWED AND APPROVED BY THE DESIGNER / DESIGNER REPRESENTATIVE, DESIGNATED ENGINEER, AND THE CONTRACT ADMINISTRATOR.
- CONSTRUCTION OBSERVATION IS TO BE PERFORMED BY A CERTIFIED FLUVIAL GEOMORPHOLOGIST OR EXPERIENCED ENVIRONMENTAL INSPECTOR UNDER DIRECTION FROM THE DESIGNER.
- 7. ON-SITE SUPPORT FROM PROJECT ENGINEER (E.G., GEOTECHNICAL, HYDROGEOLOGICAL, AND/OR WATER
- RESOURCES ENGINEER) REQUIRED TO ASSESS AND ENSURE FAVOURABLE SURFICIAL AND SUBSURFACE CONDITIONS TO SUPPORT CHANNEL REALIGNMENT CONSTRUCTION. 8. BE ADVISED THAT THE LOCAL REGULATORY BODY MAY, AT ANY TIME, WITHDRAW THIS PERMISSION, IF, IN THE
- OPINION OF THE AUTHORITY, THE CONDITIONS OF THE PERMIT ARE NOT BEING COMPLIED WITH. THIS APPROVAL DOES NOT EXEMPT THE PROPERTY OWNER/APPLICANT/AGENT FROM THE PROVISIONS OF ANY OTHER FEDERAL, PROVINCIAL OR MUNICIPAL STATUTES, REGULATIONS OR BY-LAWS, OR ANY RIGHTS UNDER COMMON LAW.

TIMING OF WORKS

- 1. WORKS SHALL BE COMPLETED DURING THE DESIGNATED IN-WATER WORKS WINDOW SET OUT BY MNRF/DFO. 2. TREE CLEARING IS TO BE COMPLETED OUTSIDE THE BIRD NESTING SEASON (APRIL 1ST TO AUGUST 1ST) TO COMPLY WITH THE FEDERAL MIGRATORY BIRDS CONVENTION ACT. ANY TREES THAT REQUIRE REMOVAL OUTSIDE
- OF THIS TIMING WINDOW MUST FIRST BE INSPECTED BY A QUALIFIED BIOLOGIST TO DETERMINE THE PRESENCE OF
- 3. THE WEATHER FORECAST SHOULD BE CONTINUALLY MONITORED TO ENSURE THAT WORKS ARE UNDERTAKEN ONLY DURING FAVOURABLE WEATHER CONDITIONS. 4. COMPLETE THE WORKS WITH MINIMAL AVOIDABLE INTERRUPTIONS ONCE THEY COMMENCE.

SITE AND MATERIAL MANAGEMENT

- 1. ALL CONSTRUCTION EQUIPMENT AND MATERIALS (IMPORTED OR EXCAVATED) MUST BE STORED AT LEAST 30 m AWAY FROM ANY WATERBODY IN A STABLE AREA ABOVE THE ACTIVE FLOODPLAIN, OR IN A DESIGNATED
- 2. IN THE EVENT OF AN UNEXPECTED STORM, ALL UNFIXED ITEMS THAT HAVE THE POTENTIAL TO CAUSE A SPILL OR AN OBSTRUCTION TO FLOW MUST BE MOVED A STABLE AREA ABOVE ACTIVE FLOODPLAIN. 3. STOCKPILES MUST BE LOCATED OUTSIDE THE ISOLATED WORK AREAS.
- 4. STABILIZE, TEMPORARILY OR PERMANENTLY, ANY DISTURBED AREAS AS WORK PROGRESSES, OR SOON AS CONDITIONS ALLOW.
- 5. MINIMIZE THE AREA OF DISTURBANCE TO THE EXTENT POSSIBLE. ALL DISTURBED GROUND LEFT INACTIVE FOR MORE THAN 30 DAYS SHALL BE STABILIZED USING APPROPRIATE EROSION CONTROL MEASURES AND AN APPROPRIATE SEED MIX AS NOTED WITHIN THE FINAL APPROVED RESTORATION PLAN.
- 6. ALL VEGETATION, ADJACENT TO THE WORK AREA, MUST BE PROTECTED AND DELINEATED WITH CONSTRUCTION FFNCING OR TREE PROTECTION BARRIERS.
- 7. ALL GRADES IN THE AREA REGULATED BY THE CONSERVATION AUTHORITY MUST BE MAINTAINED OR MATCHED,
- UNLESS OTHERWISE AUTHORIZED IN THE APPLICABLE PERMIT.

 8. AN AFTER-HOURS CONTACT NUMBER IS TO BE VISIBLY POSTED ONSITE FOR EMERGENCIES. ALL THE PLANS
- SHOULD HAVE NAME AND CONTACT INFO OF THE PERSON RESPONSIBLE FOR ESC MEASURES.

EROSION AND SEDIMENT CONTROL

- ALL TEMPORARY EROSION AND SEDIMENT CONTROL MEASURES MUST BE INSTALLED PRIOR TO START OF WORKS.
 FOLLOWING INSTALLATION OF THE PROPOSED ESC MEASURES, A QUALIFIED AGENT OF THE PROPONENT (E.G. CAN-CISEC CERTIFIED MONITOR) WILL CONDUCT REGULAR SITÉ VISITS TO MONITOR ALL WORKS, PARTICULARLY THE CONDITION OF THE ESC MEASURES, DEWATERING, AND IN- OR NEAR-WATER WORKS. SHOULD CONCERNS ARISE; THE ENVIRONMENTAL MONITOR WILL CONTACT THE PROPONENT, THE CONSERVATION AUTHORITY, AND
- ANY OTHER APPROPRIATE PARTIES. 3. EROSION AND SEDIMENT CONTROLS MUST BE MAINTAINED DURING CONSTRUCTION, AND ANY REQUIRED REPAIRS OR REPLACEMENTS MUST BE COMPLETED WITHIN 24 HOURS AFTER THEY HAVE BEEN IDENTIFIED DURING THE
- 4. EROSION AND SEDIMENT CONTROLS MAY REQUIRE PERIODIC ADJUSTMENTS TO REFLECT CHANGING SITE CONDITIONS. THE CONTRACTOR WILL BE RESPONSIBLE FOR THESE ADJUSTMENTS TO ENSURE PROPER
- ANY CHANGES TO THE EROSION AND SEDIMENT CONTROL PLAN BEYOND MINOR ADJUSTMENTS MUST BE APPROVED BY THE CONTRACT ADMINISTRATOR.
- 6. ADDITIONAL EROSION AND SEDIMENT CONTROL SUPPLIES MUST BE KEPT ON SITE IN ORDER TO FACILITATE IMMEDIATE REPAIRS AND/OR UPGRADES AS NEEDED.
- 7. ALL TEMPORARY SEDIMENT CONTROLS MUST BE REMOVED AFTER THE CONTRACT ADMINISTRATOR DEEMS THE 8. THE PROJECT PROPONENT OR THEIR REPRESENTATIVE IS ULTIMATELY RESPONSIBLE FOR CONTROLLING
- SEDIMENT AND EROSION WITHIN THE CONSTRUCTION SITE FOR THE TOTAL PERIOD OF THE CONSTRUCTION. 9. IF EXCESSIVE SILTATION RESULTS FROM THE CONSTRUCTION ACTIVITIES, THE ONSITE SUPERVISOR/INSPECTOR
- AND/OR THE LOCAL REGULATORY BODY RESERVE THE RIGHT TO REQUEST ADDITIONAL ESC MEASURES WHICH WOULD BE INSTALLED PRIOR TO FURTHER CONSTRUCTION ACTIVITIES.

DELETERIOUS SUBSTANCE CONTROL/SPILL MANAGEMENT

- PREVENT THE RELEASE OF SEDIMENT, SEDIMENT-LADEN WATER, RAW CONCRETE, CONCRETE LEACHATE OR ANY OTHER DELETERIOUS SUBSTANCES INTO ANY WATERBODY, RAVINE OR STORM SEWER SYSTEM. 2. ENSURE EQUIPMENT AND MACHINERY ARE IN GOOD OPERATING CONDITION (POWER WASHED), FREE OF LEAKS, EXCESS OIL, AND GREASE.

 3. NO EQUIPMENT REFUELLING OR SERVICING SHOULD BE UNDERTAKEN WITHIN 30 m OF ANY WATERCOURSE OR
- SURFACE WATER DRAINAGE. A SPILL CONTAINMENT KIT MUST BE READILY ACCESSIBLE ON SITE IN THE EVENT OF A RELEASE OF A DELETERIOUS SUBSTANCE TO THE ENVIRONMENT. ONSITE STAFF MUST BE TRAINED IN ITS USE.
- 5. THE CONTRACT ADMINISTRATOR MUST BE NOTIFIED IMMEDIATELY IN THE EVENT OF A SPILL OF DELETERIOUS SUBSTANCE. ANY SEDIMENT SPILL FROM THE SITE SHOULD BE REPORTED TO MINISTRY OF ENVIRONMENT (SPILL ACTION CENTER) AT 1-800-268-6060.

WORK AREA ISOLATION

- 1. ALL WORK IN ISOLATED WORK AREAS MUST BE COMPLETED IN THE DRY. AN ADEQUATE NUMBER OF PUMPS MUST BE USED FOR UNWATERING.
 2. CROSSING AN ACTIVE WATERCOURSE OR WETLAND BY EQUIPMENT, VEHICLES, PERSONNEL, ETC. IS NOT
- PERMITTED UNLESS APPROVED BY THE CONSERVATION AUTHORITY. ALL ACCESS TO WORK SITES SHALL BE FROM
- EITHER SIDES OF THE WATERCOURSE OR WETLAND. 3. THE UNWATERING DISCHARGE LOCATION MUST BE LOCATED AT LEAST 30 M FROM ANY WATERCOURSE OR WETLAND IN AN AREA WITH DENSE VEGETATIVE GROUNDCOVER, AND WHERE THE DISCHARGE CAN RETURN TO
- THE WATERBODY DOWNSTREAM OF THE WORK AREA OVER THE GROUNDCOVER. 4. FISH MUST BE REMOVED FROM THE WORK AREA ONCE ISOLATED. FISH SALVAGE MUST BE COMPLETED BY A
- QUALIFIED TECHNICIAN WITH A LICENSE FROM THE ONTARIO MINISTRY OF NATURAL RESOURCES AND FORESTRY

DATE BY REVISIONS

CHECKED BY: PV DESIGNED BY: LD/AS

DRAFT FOR INTERNAL DISCUSSION

DRAWN BY: AL/CP/SC

 $M O R P H I X^{\mathsf{m}}$

DATE: JUNE 2024


NOT FOR CONSTRUCTION

36 Main St N., P.O. Box 205 Campbellville, Ontario L0P 1B0 T: 416.920.0926 www.geomorphix.com


ALLOA SPA TOWN OF CALEDON

ETOBICOKE CREEK - ALLOA DRAIN CONCEPTUAL CHANNEL DESIGN CHANNEL PLANFORM

PROJECT No.: PN24009 DRAWING No.: GEO-17 SCALE: AS NOTED SHEET 18 OF 35

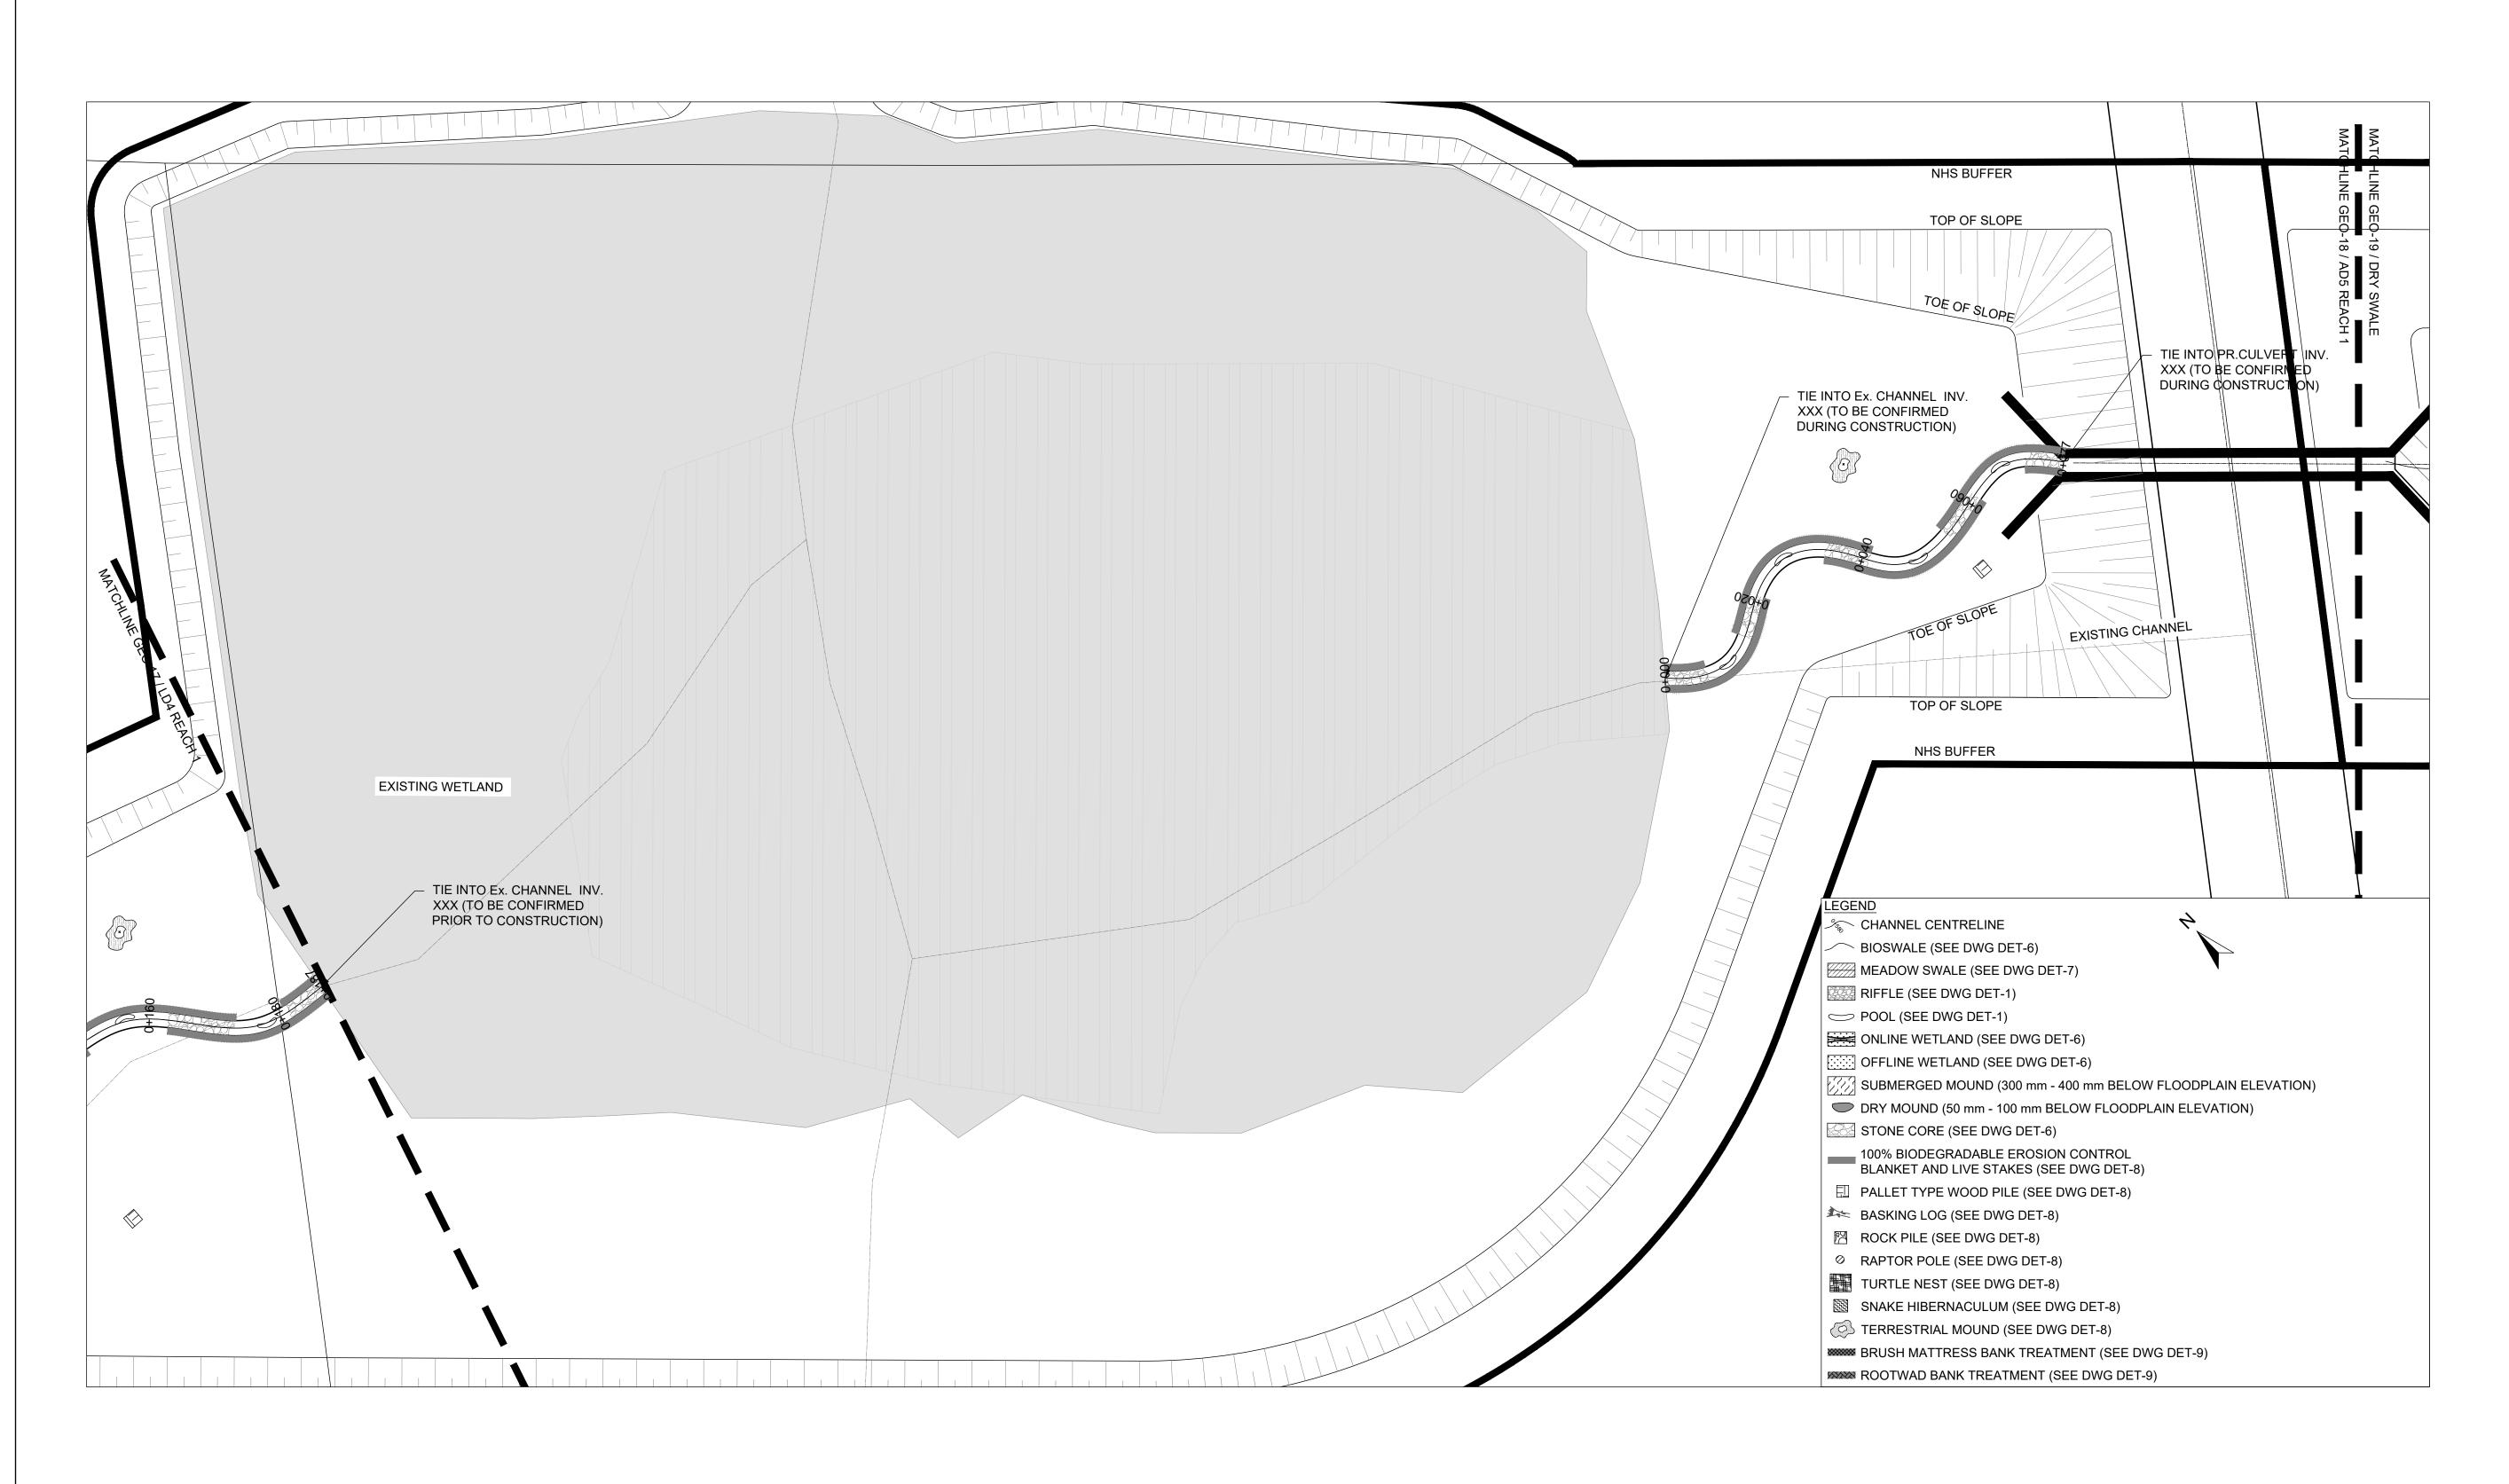

PLANFORM

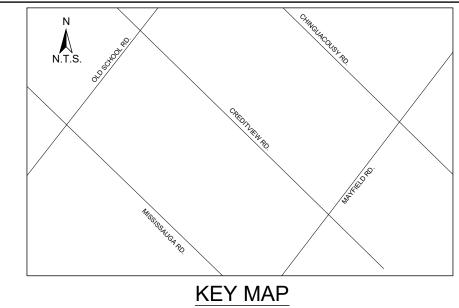

TIMING OF WORKS

- 1. THE ACCOMPANYING CHANNEL REALIGNMENT TECHNICAL DESIGN BRIEF PREPARED BY GEO MORPHIX LTD. (2023) PROVIDES ADDITIONAL DESIGN DETAILS AND DIRECTION FOR IMPLEMENTATION AND IS TO BE REVIEWED IN CONJUNCTION WITH THIS DRAWING SET.
- 2. ALL CONTRACT DRAWINGS, SPECIFICATIONS AND APPLICABLE PERMITS MUST BE KEPT ON SITE DURING CONSTRUCTION FOR REFERENCE.

 3. THE CONTRACTOR MUST NOTIFY THE DESIGNER AND CONTRACT ADMINISTRATOR OF THE INTENT TO COMMENCE
- WORK AT LEAST 48 HOURS IN ADVANCE.
- 4. THE CONTRACTOR IS RESPONSIBLE FOR ALL UTILITY LOCATES.
 5. LAYOUT MUST BE REVIEWED AND APPROVED BY THE DESIGNER / DESIGNER REPRESENTATIVE, DESIGNATED ENGINEER, AND THE CONTRACT ADMINISTRATOR.
- CONSTRUCTION OBSERVATION IS TO BE PERFORMED BY A CERTIFIED FLUVIAL GEOMORPHOLOGIST OR EXPERIENCED ENVIRONMENTAL INSPECTOR UNDER DIRECTION FROM THE DESIGNER.
- 7. ON-SITE SUPPORT FROM PROJECT ENGINEER (E.G., GEOTECHNICAL, HYDROGEOLOGICAL, AND/OR WATER RESOURCES ENGINEER) REQUIRED TO ASSESS AND ENSURE FAVOURABLE SURFICIAL AND SUBSURFACE
- CONDITIONS TO SUPPORT CHANNEL REALIGNMENT CONSTRUCTION. 8. BE ADVISED THAT THE LOCAL REGULATORY BODY MAY, AT ANY TIME, WITHDRAW THIS PERMISSION, IF, IN THE OPINION OF THE AUTHORITY. THE CONDITIONS OF THE PERMIT ARE NOT BEING COMPLIED WITH. THIS APPROVAL

DOES NOT EXEMPT THE PROPERTY OWNER/APPLICANT/AGENT FROM THE PROVISIONS OF ANY OTHER FEDERAL, PROVINCIAL OR MUNICIPAL STATUTES, REGULATIONS OR BY-LAWS, OR ANY RIGHTS UNDER COMMON LAW.

- 1. WORKS SHALL BE COMPLETED DURING THE DESIGNATED IN-WATER WORKS WINDOW SET OUT BY MNRF/DFO. 2. TREE CLEARING IS TO BE COMPLETED OUTSIDE THE BIRD NESTING SEASON (APRIL 1ST TO AUGUST 1ST) TO COMPLY WITH THE FEDERAL MIGRATORY BIRDS CONVENTION ACT. ANY TREES THAT REQUIRE REMOVAL OUTSIDE OF THIS TIMING WINDOW MUST FIRST BE INSPECTED BY A QUALIFIED BIOLOGIST TO DETERMINE THE PRESENCE OF
- 3. THE WEATHER FORECAST SHOULD BE CONTINUALLY MONITORED TO ENSURE THAT WORKS ARE UNDERTAKEN ONLY DURING FAVOURABLE WEATHER CONDITIONS.

4. COMPLETE THE WORKS WITH MINIMAL AVOIDABLE INTERRUPTIONS ONCE THEY COMMENCE.

SITE AND MATERIAL MANAGEMENT

1. ALL CONSTRUCTION EQUIPMENT AND MATERIALS (IMPORTED OR EXCAVATED) MUST BE STORED AT LEAST 30 m

- AWAY FROM ANY WATERBODY IN A STABLE AREA ABOVE THE ACTIVE FLOODPLAIN, OR IN A DESIGNATED
- 2. IN THE EVENT OF AN UNEXPECTED STORM, ALL UNFIXED ITEMS THAT HAVE THE POTENTIAL TO CAUSE A SPILL OR AN OBSTRUCTION TO FLOW MUST BE MOVED A STABLE AREA ABOVE ACTIVE FLOODPLAIN.
- 3. STOCKPILES MUST BE LOCATED OUTSIDE THE ISOLATED WORK AREAS. 4. STABILIZE, TEMPORARILY OR PERMANENTLY, ANY DISTURBED AREAS AS WORK PROGRESSES, OR SOON AS CONDITIONS ALLOW.
- 5. MINIMIZE THE AREA OF DISTURBANCE TO THE EXTENT POSSIBLE. ALL DISTURBED GROUND LEFT INACTIVE FOR MORE THAN 30 DAYS SHALL BE STABILIZED USING APPROPRIATE EROSION CONTROL MEASURES AND AN
- APPROPRIATE SEED MIX AS NOTED WITHIN THE FINAL APPROVED RESTORATION PLAN. 6. ALL VEGETATION, ADJACENT TO THE WORK AREA, MUST BE PROTECTED AND DELINEATED WITH CONSTRUCTION
- FENCING OR TREE PROTECTION BARRIERS. 7. ALL GRADES IN THE AREA REGULATED BY THE CONSERVATION AUTHORITY MUST BE MAINTAINED OR MATCHED,
- UNLESS OTHERWISE AUTHORIZED IN THE APPLICABLE PERMIT.

 8. AN AFTER-HOURS CONTACT NUMBER IS TO BE VISIBLY POSTED ONSITE FOR EMERGENCIES. ALL THE PLANS SHOULD HAVE NAME AND CONTACT INFO OF THE PERSON RESPONSIBLE FOR ESC MEASURES.

EROSION AND SEDIMENT CONTROL

- ALL TEMPORARY EROSION AND SEDIMENT CONTROL MEASURES MUST BE INSTALLED PRIOR TO START OF WORKS.
 FOLLOWING INSTALLATION OF THE PROPOSED ESC MEASURES, A QUALIFIED AGENT OF THE PROPONENT (E.G. CAN-CISEC CERTIFIED MONITOR) WILL CONDUCT REGULAR SITÉ VISITS TO MONITOR ALL WORKS, PARTICULARLY THE CONDITION OF THE ESC MEASURES, DEWATERING, AND IN- OR NEAR-WATER WORKS. SHOULD CONCERNS ARISE; THE ENVIRONMENTAL MONITOR WILL CONTACT THE PROPONENT, THE CONSERVATION AUTHORITY, AND
- ANY OTHER APPROPRIATE PARTIES. 3. EROSION AND SEDIMENT CONTROLS MUST BE MAINTAINED DURING CONSTRUCTION, AND ANY REQUIRED REPAIRS OR REPLACEMENTS MUST BE COMPLETED WITHIN 24 HOURS AFTER THEY HAVE BEEN IDENTIFIED DURING THE
- 4. EROSION AND SEDIMENT CONTROLS MAY REQUIRE PERIODIC ADJUSTMENTS TO REFLECT CHANGING SITE CONDITIONS. THE CONTRACTOR WILL BE RESPONSIBLE FOR THESE ADJUSTMENTS TO ENSURE PROPER
- ANY CHANGES TO THE EROSION AND SEDIMENT CONTROL PLAN BEYOND MINOR ADJUSTMENTS MUST BE APPROVED BY THE CONTRACT ADMINISTRATOR.
- 6. ADDITIONAL EROSION AND SEDIMENT CONTROL SUPPLIES MUST BE KEPT ON SITE IN ORDER TO FACILITATE
- IMMEDIATE REPAIRS AND/OR UPGRADES AS NEEDED. 7. ALL TEMPORARY SEDIMENT CONTROLS MUST BE REMOVED AFTER THE CONTRACT ADMINISTRATOR DEEMS THE
- 8. THE PROJECT PROPONENT OR THEIR REPRESENTATIVE IS ULTIMATELY RESPONSIBLE FOR CONTROLLING SEDIMENT AND EROSION WITHIN THE CONSTRUCTION SITE FOR THE TOTAL PERIOD OF THE CONSTRUCTION. 9. IF EXCESSIVE SILTATION RESULTS FROM THE CONSTRUCTION ACTIVITIES, THE ONSITE SUPERVISOR/INSPECTOR
- AND/OR THE LOCAL REGULATORY BODY RESERVE THE RIGHT TO REQUEST ADDITIONAL ESC MEASURES WHICH WOULD BE INSTALLED PRIOR TO FURTHER CONSTRUCTION ACTIVITIES.

DELETERIOUS SUBSTANCE CONTROL/SPILL MANAGEMENT

- PREVENT THE RELEASE OF SEDIMENT, SEDIMENT-LADEN WATER, RAW CONCRETE, CONCRETE LEACHATE OR ANY OTHER DELETERIOUS SUBSTANCES INTO ANY WATERBODY, RAVINE OR STORM SEWER SYSTEM. 2. ENSURE EQUIPMENT AND MACHINERY ARE IN GOOD OPERATING CONDITION (POWER WASHED), FREE OF LEAKS, EXCESS OIL, AND GREASE.

 3. NO EQUIPMENT REFUELLING OR SERVICING SHOULD BE UNDERTAKEN WITHIN 30 m OF ANY WATERCOURSE OR
- SURFACE WATER DRAINAGE. A SPILL CONTAINMENT KIT MUST BE READILY ACCESSIBLE ON SITE IN THE EVENT OF A RELEASE OF A DELETERIOUS SUBSTANCE TO THE ENVIRONMENT. ONSITE STAFF MUST BE TRAINED IN ITS USE.
- 5. THE CONTRACT ADMINISTRATOR MUST BE NOTIFIED IMMEDIATELY IN THE EVENT OF A SPILL OF DELETERIOUS
- SUBSTANCE. ANY SEDIMENT SPILL FROM THE SITE SHOULD BE REPORTED TO MINISTRY OF ENVIRONMENT (SPILL ACTION CENTER) AT 1-800-268-6060.

WORK AREA ISOLATION

- 1. ALL WORK IN ISOLATED WORK AREAS MUST BE COMPLETED IN THE DRY. AN ADEQUATE NUMBER OF PUMPS MUST BE USED FOR UNWATERING.
 2. CROSSING AN ACTIVE WATERCOURSE OR WETLAND BY EQUIPMENT, VEHICLES, PERSONNEL, ETC. IS NOT
- PERMITTED UNLESS APPROVED BY THE CONSERVATION AUTHORITY. ALL ACCESS TO WORK SITES SHALL BE FROM
- EITHER SIDES OF THE WATERCOURSE OR WETLAND. 3. THE UNWATERING DISCHARGE LOCATION MUST BE LOCATED AT LEAST 30 M FROM ANY WATERCOURSE OR WETLAND IN AN AREA WITH DENSE VEGETATIVE GROUNDCOVER, AND WHERE THE DISCHARGE CAN RETURN TO
- THE WATERBODY DOWNSTREAM OF THE WORK AREA OVER THE GROUNDCOVER. 4. FISH MUST BE REMOVED FROM THE WORK AREA ONCE ISOLATED. FISH SALVAGE MUST BE COMPLETED BY A QUALIFIED TECHNICIAN WITH A LICENSE FROM THE ONTARIO MINISTRY OF NATURAL RESOURCES AND FORESTRY

DATE BY REVISIONS DESIGNED BY: LD/AS CHECKED BY: PV DRAWN BY: AL/CP/SC DATE: JUNE 2024

DRAFT FOR **INTERNAL**

NOT FOR CONSTRUCTION

DISCUSSION

 $M O R P H I X^{\mathsf{m}}$ 36 Main St N., P.O. Box 205 Campbellville, Ontario L0P 1B0 T: 416.920.0926


www.geomorphix.com ALLOA SPA


TOWN OF CALEDON

ETOBICOKE CREEK - ALLOA DRAIN CONCEPTUAL CHANNEL DESIGN CHANNEL PLANFORM

PROJECT No.: PN24009 DRAWING No.: GEO-18 SCALED FOR PLOT ON 'ARCH D' | SCALE: AS NOTED SHEET 19 OF 35

1:500

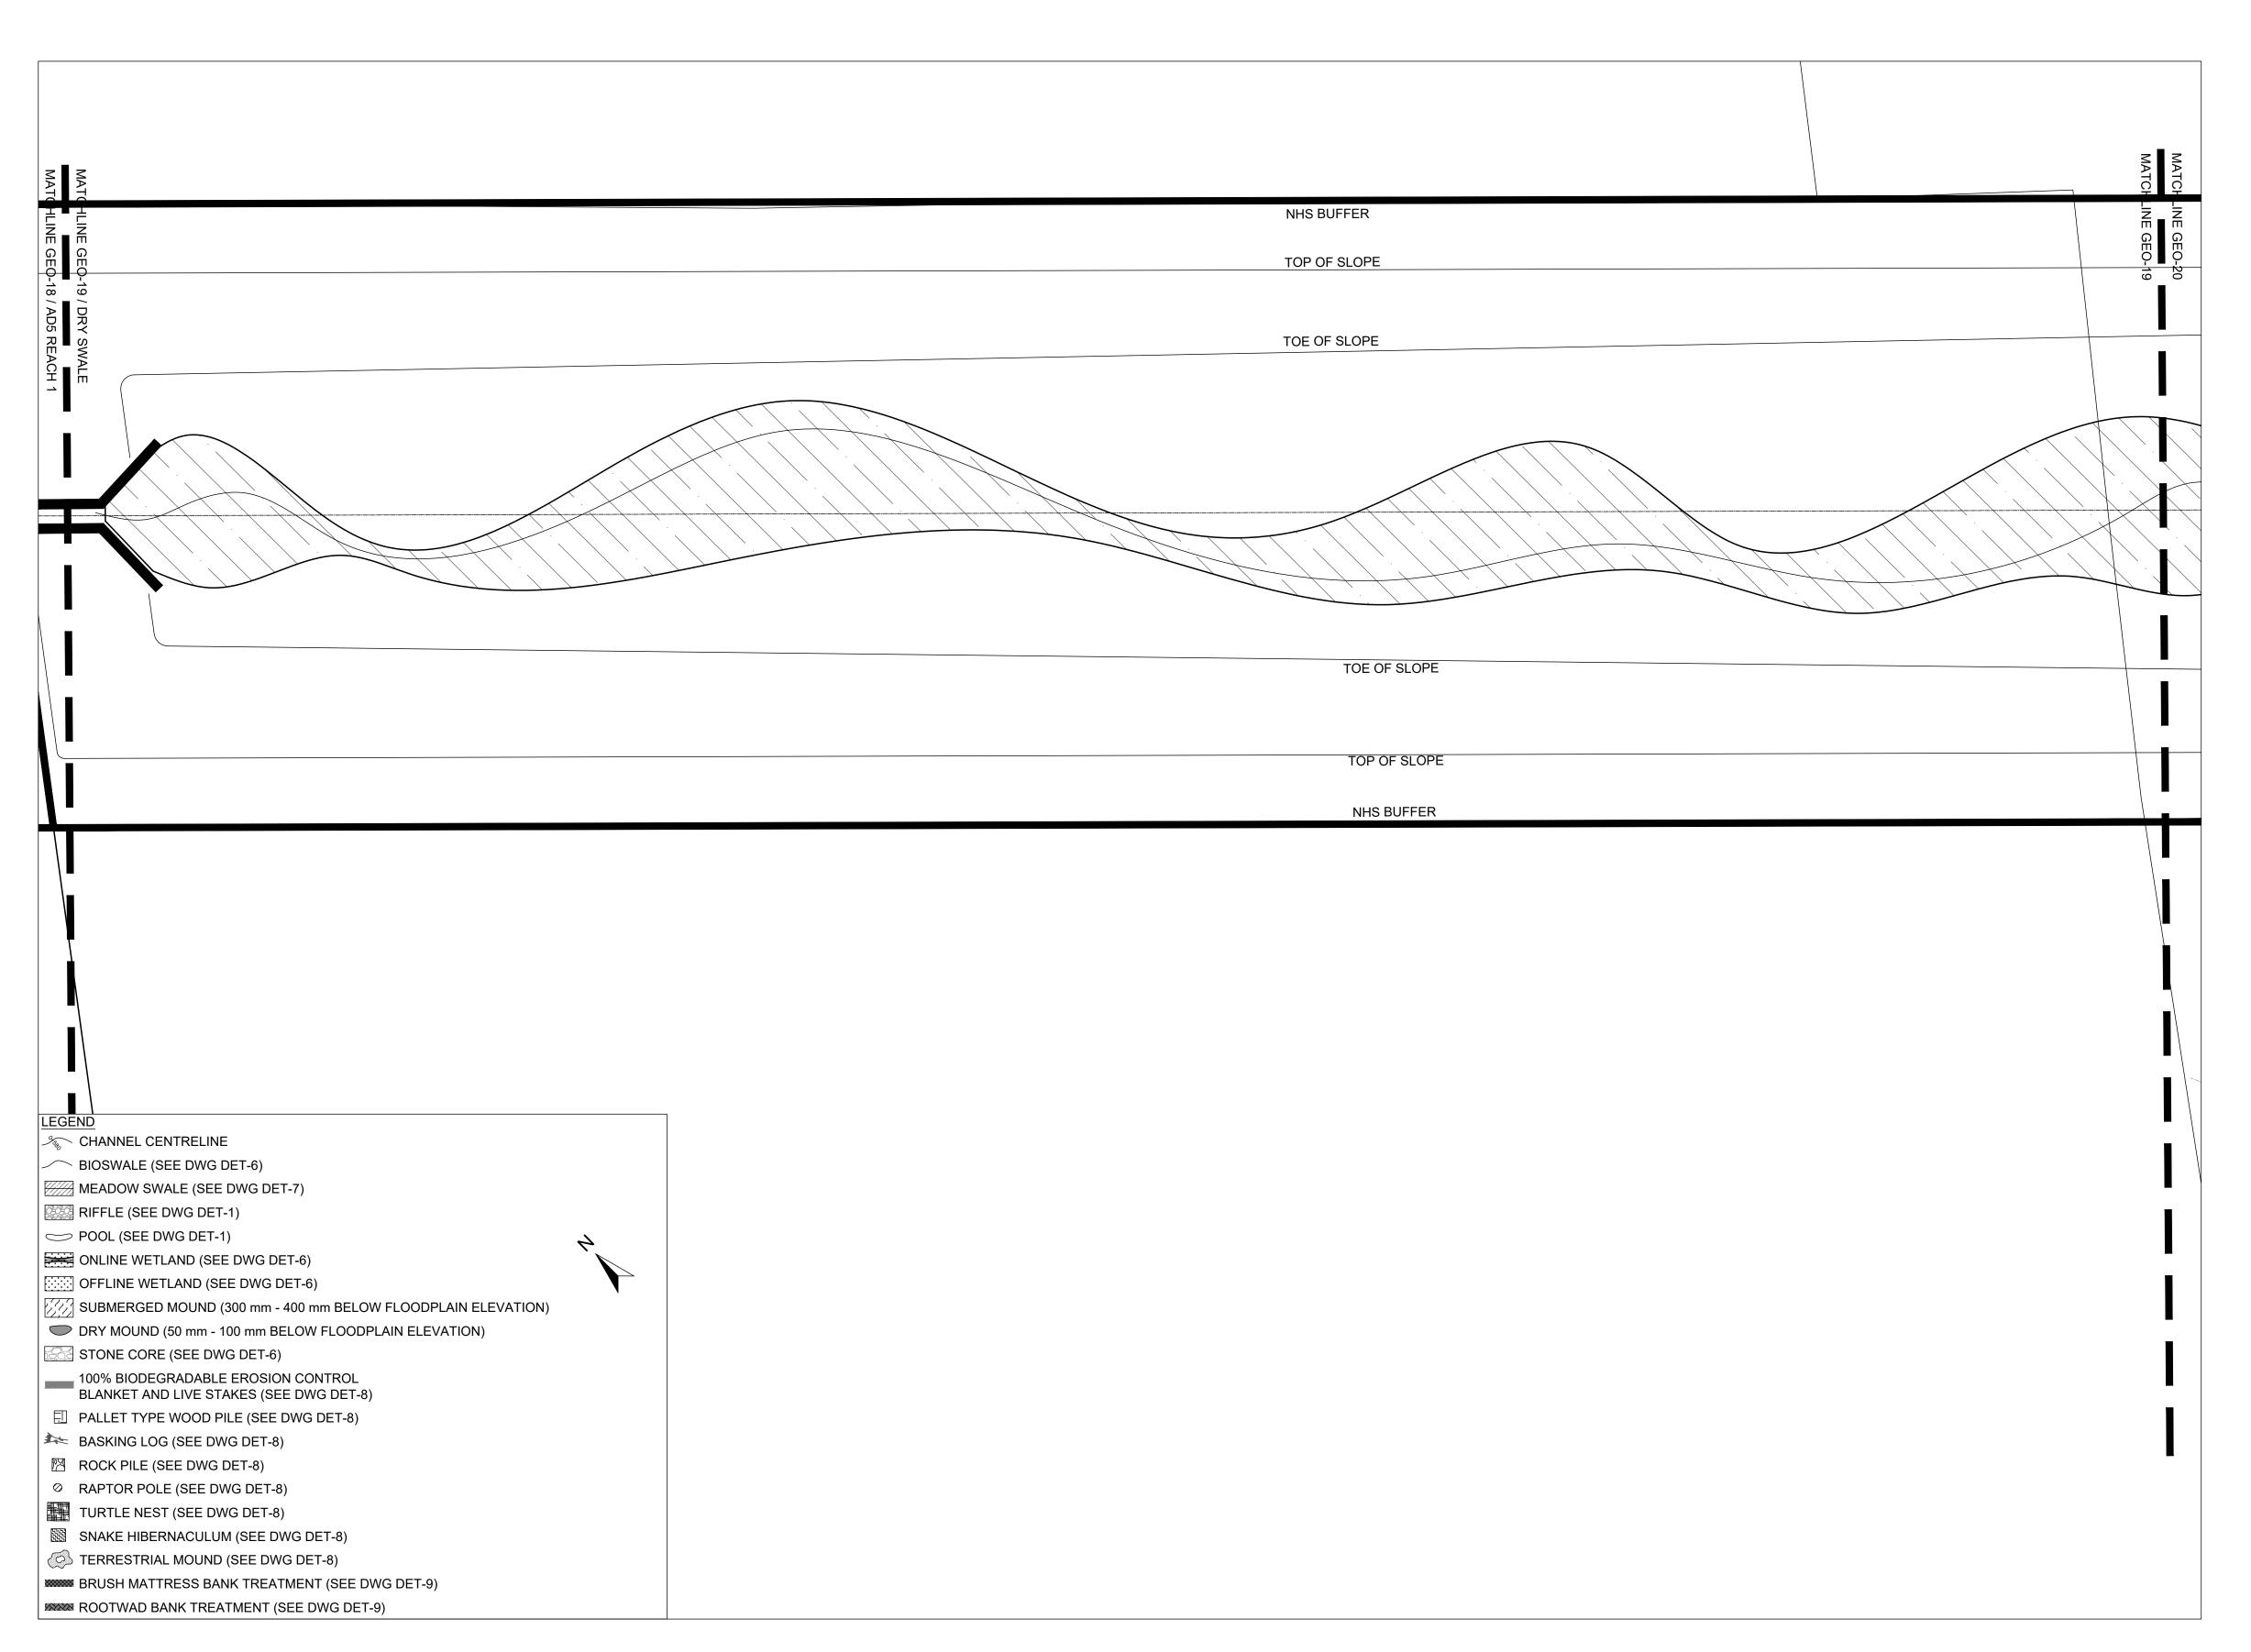

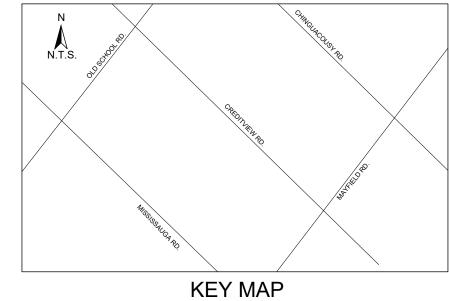

- 1. THE ACCOMPANYING CHANNEL REALIGNMENT TECHNICAL DESIGN BRIEF PREPARED BY GEO MORPHIX LTD. (2023) PROVIDES ADDITIONAL DESIGN DETAILS AND DIRECTION FOR IMPLEMENTATION AND IS TO BE REVIEWED IN CONJUNCTION WITH THIS DRAWING SET.
- 2. ALL CONTRACT DRAWINGS, SPECIFICATIONS AND APPLICABLE PERMITS MUST BE KEPT ON SITE DURING
- CONSTRUCTION FOR REFERENCE.

 3. THE CONTRACTOR MUST NOTIFY THE DESIGNER AND CONTRACT ADMINISTRATOR OF THE INTENT TO COMMENCE WORK AT LEAST 48 HOURS IN ADVANCE.
- 4. THE CONTRACTOR IS RESPONSIBLE FOR ALL UTILITY LOCATES.
 5. LAYOUT MUST BE REVIEWED AND APPROVED BY THE DESIGNER / DESIGNER REPRESENTATIVE, DESIGNATED
- ENGINEER, AND THE CONTRACT ADMINISTRATOR.
- CONSTRUCTION OBSERVATION IS TO BE PERFORMED BY A CERTIFIED FLUVIAL GEOMORPHOLOGIST OR EXPERIENCED ENVIRONMENTAL INSPECTOR UNDER DIRECTION FROM THE DESIGNER. 7. ON-SITE SUPPORT FROM PROJECT ENGINEER (E.G., GEOTECHNICAL, HYDROGEOLOGICAL, AND/OR WATER
- RESOURCES ENGINEER) REQUIRED TO ASSESS AND ENSURE FAVOURABLE SURFICIAL AND SUBSURFACE CONDITIONS TO SUPPORT CHANNEL REALIGNMENT CONSTRUCTION. 8. BE ADVISED THAT THE LOCAL REGULATORY BODY MAY, AT ANY TIME, WITHDRAW THIS PERMISSION, IF, IN THE
- OPINION OF THE AUTHORITY, THE CONDITIONS OF THE PERMIT ARE NOT BEING COMPLIED WITH. THIS APPROVAL DOES NOT EXEMPT THE PROPERTY OWNER/APPLICANT/AGENT FROM THE PROVISIONS OF ANY OTHER FEDERAL, PROVINCIAL OR MUNICIPAL STATUTES, REGULATIONS OR BY-LAWS, OR ANY RIGHTS UNDER COMMON LAW.

TIMING OF WORKS

- 1. WORKS SHALL BE COMPLETED DURING THE DESIGNATED IN-WATER WORKS WINDOW SET OUT BY MNRF/DFO. 2. TREE CLEARING IS TO BE COMPLETED OUTSIDE THE BIRD NESTING SEASON (APRIL 1ST TO AUGUST 1ST) TO COMPLY WITH THE FEDERAL MIGRATORY BIRDS CONVENTION ACT. ANY TREES THAT REQUIRE REMOVAL OUTSIDE
- OF THIS TIMING WINDOW MUST FIRST BE INSPECTED BY A QUALIFIED BIOLOGIST TO DETERMINE THE PRESENCE OF
- 3. THE WEATHER FORECAST SHOULD BE CONTINUALLY MONITORED TO ENSURE THAT WORKS ARE UNDERTAKEN ONLY DURING FAVOURABLE WEATHER CONDITIONS.
- 4. COMPLETE THE WORKS WITH MINIMAL AVOIDABLE INTERRUPTIONS ONCE THEY COMMENCE.

SITE AND MATERIAL MANAGEMENT

- 1. ALL CONSTRUCTION EQUIPMENT AND MATERIALS (IMPORTED OR EXCAVATED) MUST BE STORED AT LEAST 30 m AWAY FROM ANY WATERBODY IN A STABLE AREA ABOVE THE ACTIVE FLOODPLAIN, OR IN A DESIGNATED
- 2. IN THE EVENT OF AN UNEXPECTED STORM, ALL UNFIXED ITEMS THAT HAVE THE POTENTIAL TO CAUSE A SPILL OR AN OBSTRUCTION TO FLOW MUST BE MOVED A STABLE AREA ABOVE ACTIVE FLOODPLAIN.
- 3. STOCKPILES MUST BE LOCATED OUTSIDE THE ISOLATED WORK AREAS.
- 4. STABILIZE, TEMPORARILY OR PERMANENTLY, ANY DISTURBED AREAS AS WORK PROGRESSES, OR SOON AS CONDITIONS ALLOW.
- 5. MINIMIZE THE AREA OF DISTURBANCE TO THE EXTENT POSSIBLE. ALL DISTURBED GROUND LEFT INACTIVE FOR MORE THAN 30 DAYS SHALL BE STABILIZED USING APPROPRIATE EROSION CONTROL MEASURES AND AN APPROPRIATE SEED MIX AS NOTED WITHIN THE FINAL APPROVED RESTORATION PLAN.
- 6. ALL VEGETATION, ADJACENT TO THE WORK AREA, MUST BE PROTECTED AND DELINEATED WITH CONSTRUCTION
- FENCING OR TREE PROTECTION BARRIERS. 7. ALL GRADES IN THE AREA REGULATED BY THE CONSERVATION AUTHORITY MUST BE MAINTAINED OR MATCHED,
- UNLESS OTHERWISE AUTHORIZED IN THE APPLICABLE PERMIT.

 8. AN AFTER-HOURS CONTACT NUMBER IS TO BE VISIBLY POSTED ONSITE FOR EMERGENCIES. ALL THE PLANS SHOULD HAVE NAME AND CONTACT INFO OF THE PERSON RESPONSIBLE FOR ESC MEASURES.

EROSION AND SEDIMENT CONTROL

- ALL TEMPORARY EROSION AND SEDIMENT CONTROL MEASURES MUST BE INSTALLED PRIOR TO START OF WORKS.
 FOLLOWING INSTALLATION OF THE PROPOSED ESC MEASURES, A QUALIFIED AGENT OF THE PROPONENT (E.G. CAN-CISEC CERTIFIED MONITOR) WILL CONDUCT REGULAR SITÉ VISITS TO MONITOR ALL WORKS, PARTICULARLY THE CONDITION OF THE ESC MEASURES, DEWATERING, AND IN- OR NEAR-WATER WORKS. SHOULD CONCERNS ARISE; THE ENVIRONMENTAL MONITOR WILL CONTACT THE PROPONENT, THE CONSERVATION AUTHORITY, AND
- ANY OTHER APPROPRIATE PARTIES. 3. EROSION AND SEDIMENT CONTROLS MUST BE MAINTAINED DURING CONSTRUCTION, AND ANY REQUIRED REPAIRS OR REPLACEMENTS MUST BE COMPLETED WITHIN 24 HOURS AFTER THEY HAVE BEEN IDENTIFIED DURING THE
- 4. EROSION AND SEDIMENT CONTROLS MAY REQUIRE PERIODIC ADJUSTMENTS TO REFLECT CHANGING SITE CONDITIONS. THE CONTRACTOR WILL BE RESPONSIBLE FOR THESE ADJUSTMENTS TO ENSURE PROPER
- ANY CHANGES TO THE EROSION AND SEDIMENT CONTROL PLAN BEYOND MINOR ADJUSTMENTS MUST BE APPROVED BY THE CONTRACT ADMINISTRATOR.
- 6. ADDITIONAL EROSION AND SEDIMENT CONTROL SUPPLIES MUST BE KEPT ON SITE IN ORDER TO FACILITATE IMMEDIATE REPAIRS AND/OR UPGRADES AS NEEDED.
- 7. ALL TEMPORARY SEDIMENT CONTROLS MUST BE REMOVED AFTER THE CONTRACT ADMINISTRATOR DEEMS THE
- 8. THE PROJECT PROPONENT OR THEIR REPRESENTATIVE IS ULTIMATELY RESPONSIBLE FOR CONTROLLING SEDIMENT AND EROSION WITHIN THE CONSTRUCTION SITE FOR THE TOTAL PERIOD OF THE CONSTRUCTION. 9. IF EXCESSIVE SILTATION RESULTS FROM THE CONSTRUCTION ACTIVITIES, THE ONSITE SUPERVISOR/INSPECTOR
- AND/OR THE LOCAL REGULATORY BODY RESERVE THE RIGHT TO REQUEST ADDITIONAL ESC MEASURES WHICH WOULD BE INSTALLED PRIOR TO FURTHER CONSTRUCTION ACTIVITIES.

DELETERIOUS SUBSTANCE CONTROL/SPILL MANAGEMENT

- 1. PREVENT THE RELEASE OF SEDIMENT, SEDIMENT-LADEN WATER, RAW CONCRETE, CONCRETE LEACHATE OR ANY OTHER DELETERIOUS SUBSTANCES INTO ANY WATERBODY. RAVINE OR STORM SEWER SYSTEM. 2. ENSURE EQUIPMENT AND MACHINERY ARE IN GOOD OPERATING CONDITION (POWER WASHED), FREE OF LEAKS,
- EXCESS OIL, AND GREASE.

 3. NO EQUIPMENT REFUELLING OR SERVICING SHOULD BE UNDERTAKEN WITHIN 30 m OF ANY WATERCOURSE OR SURFACE WATER DRAINAGE.
- A SPILL CONTAINMENT KIT MUST BE READILY ACCESSIBLE ON SITE IN THE EVENT OF A RELEASE OF A DELETERIOUS SUBSTANCE TO THE ENVIRONMENT. ONSITE STAFF MUST BE TRAINED IN ITS USE.
- 5. THE CONTRACT ADMINISTRATOR MUST BE NOTIFIED IMMEDIATELY IN THE EVENT OF A SPILL OF DELETERIOUS SUBSTANCE. ANY SEDIMENT SPILL FROM THE SITE SHOULD BE REPORTED TO MINISTRY OF ENVIRONMENT (SPILL ACTION CENTER) AT 1-800-268-6060.

WORK AREA ISOLATION

- 1. ALL WORK IN ISOLATED WORK AREAS MUST BE COMPLETED IN THE DRY. AN ADEQUATE NUMBER OF PUMPS MUST BE USED FOR UNWATERING.
 2. CROSSING AN ACTIVE WATERCOURSE OR WETLAND BY EQUIPMENT, VEHICLES, PERSONNEL, ETC. IS NOT
- PERMITTED UNLESS APPROVED BY THE CONSERVATION AUTHORITY. ALL ACCESS TO WORK SITES SHALL BE FROM EITHER SIDES OF THE WATERCOURSE OR WETLAND.
- 3. THE UNWATERING DISCHARGE LOCATION MUST BE LOCATED AT LEAST 30 M FROM ANY WATERCOURSE OR WETLAND IN AN AREA WITH DENSE VEGETATIVE GROUNDCOVER, AND WHERE THE DISCHARGE CAN RETURN TO
- THE WATERBODY DOWNSTREAM OF THE WORK AREA OVER THE GROUNDCOVER. 4. FISH MUST BE REMOVED FROM THE WORK AREA ONCE ISOLATED. FISH SALVAGE MUST BE COMPLETED BY A QUALIFIED TECHNICIAN WITH A LICENSE FROM THE ONTARIO MINISTRY OF NATURAL RESOURCES AND FORESTRY

DATE BY REVISIONS CHECKED BY: PV DESIGNED BY: LD/AS DRAWN BY: AL/CP/SC DATE: JUNE 2024

DRAFT FOR

INTERNAL DISCUSSION

SCALE: AS NOTED

 $M O R P H I X^{\mathsf{m}}$ 36 Main St N., P.O. Box 205 NOT FOR Campbellville, Ontario L0P 1B0 CONSTRUCTION

TOWN OF CALEDON

T: 416.920.0926 www.geomorphix.com


ALLOA SPA


SHEET 20 OF 35

ETOBICOKE CREEK - ALLOA DRAIN

CONCEPTUAL CHANNEL DESIGN DRY SWALE PLANFORM

PROJECT No.: PN24009 DRAWING No.: GEO-19

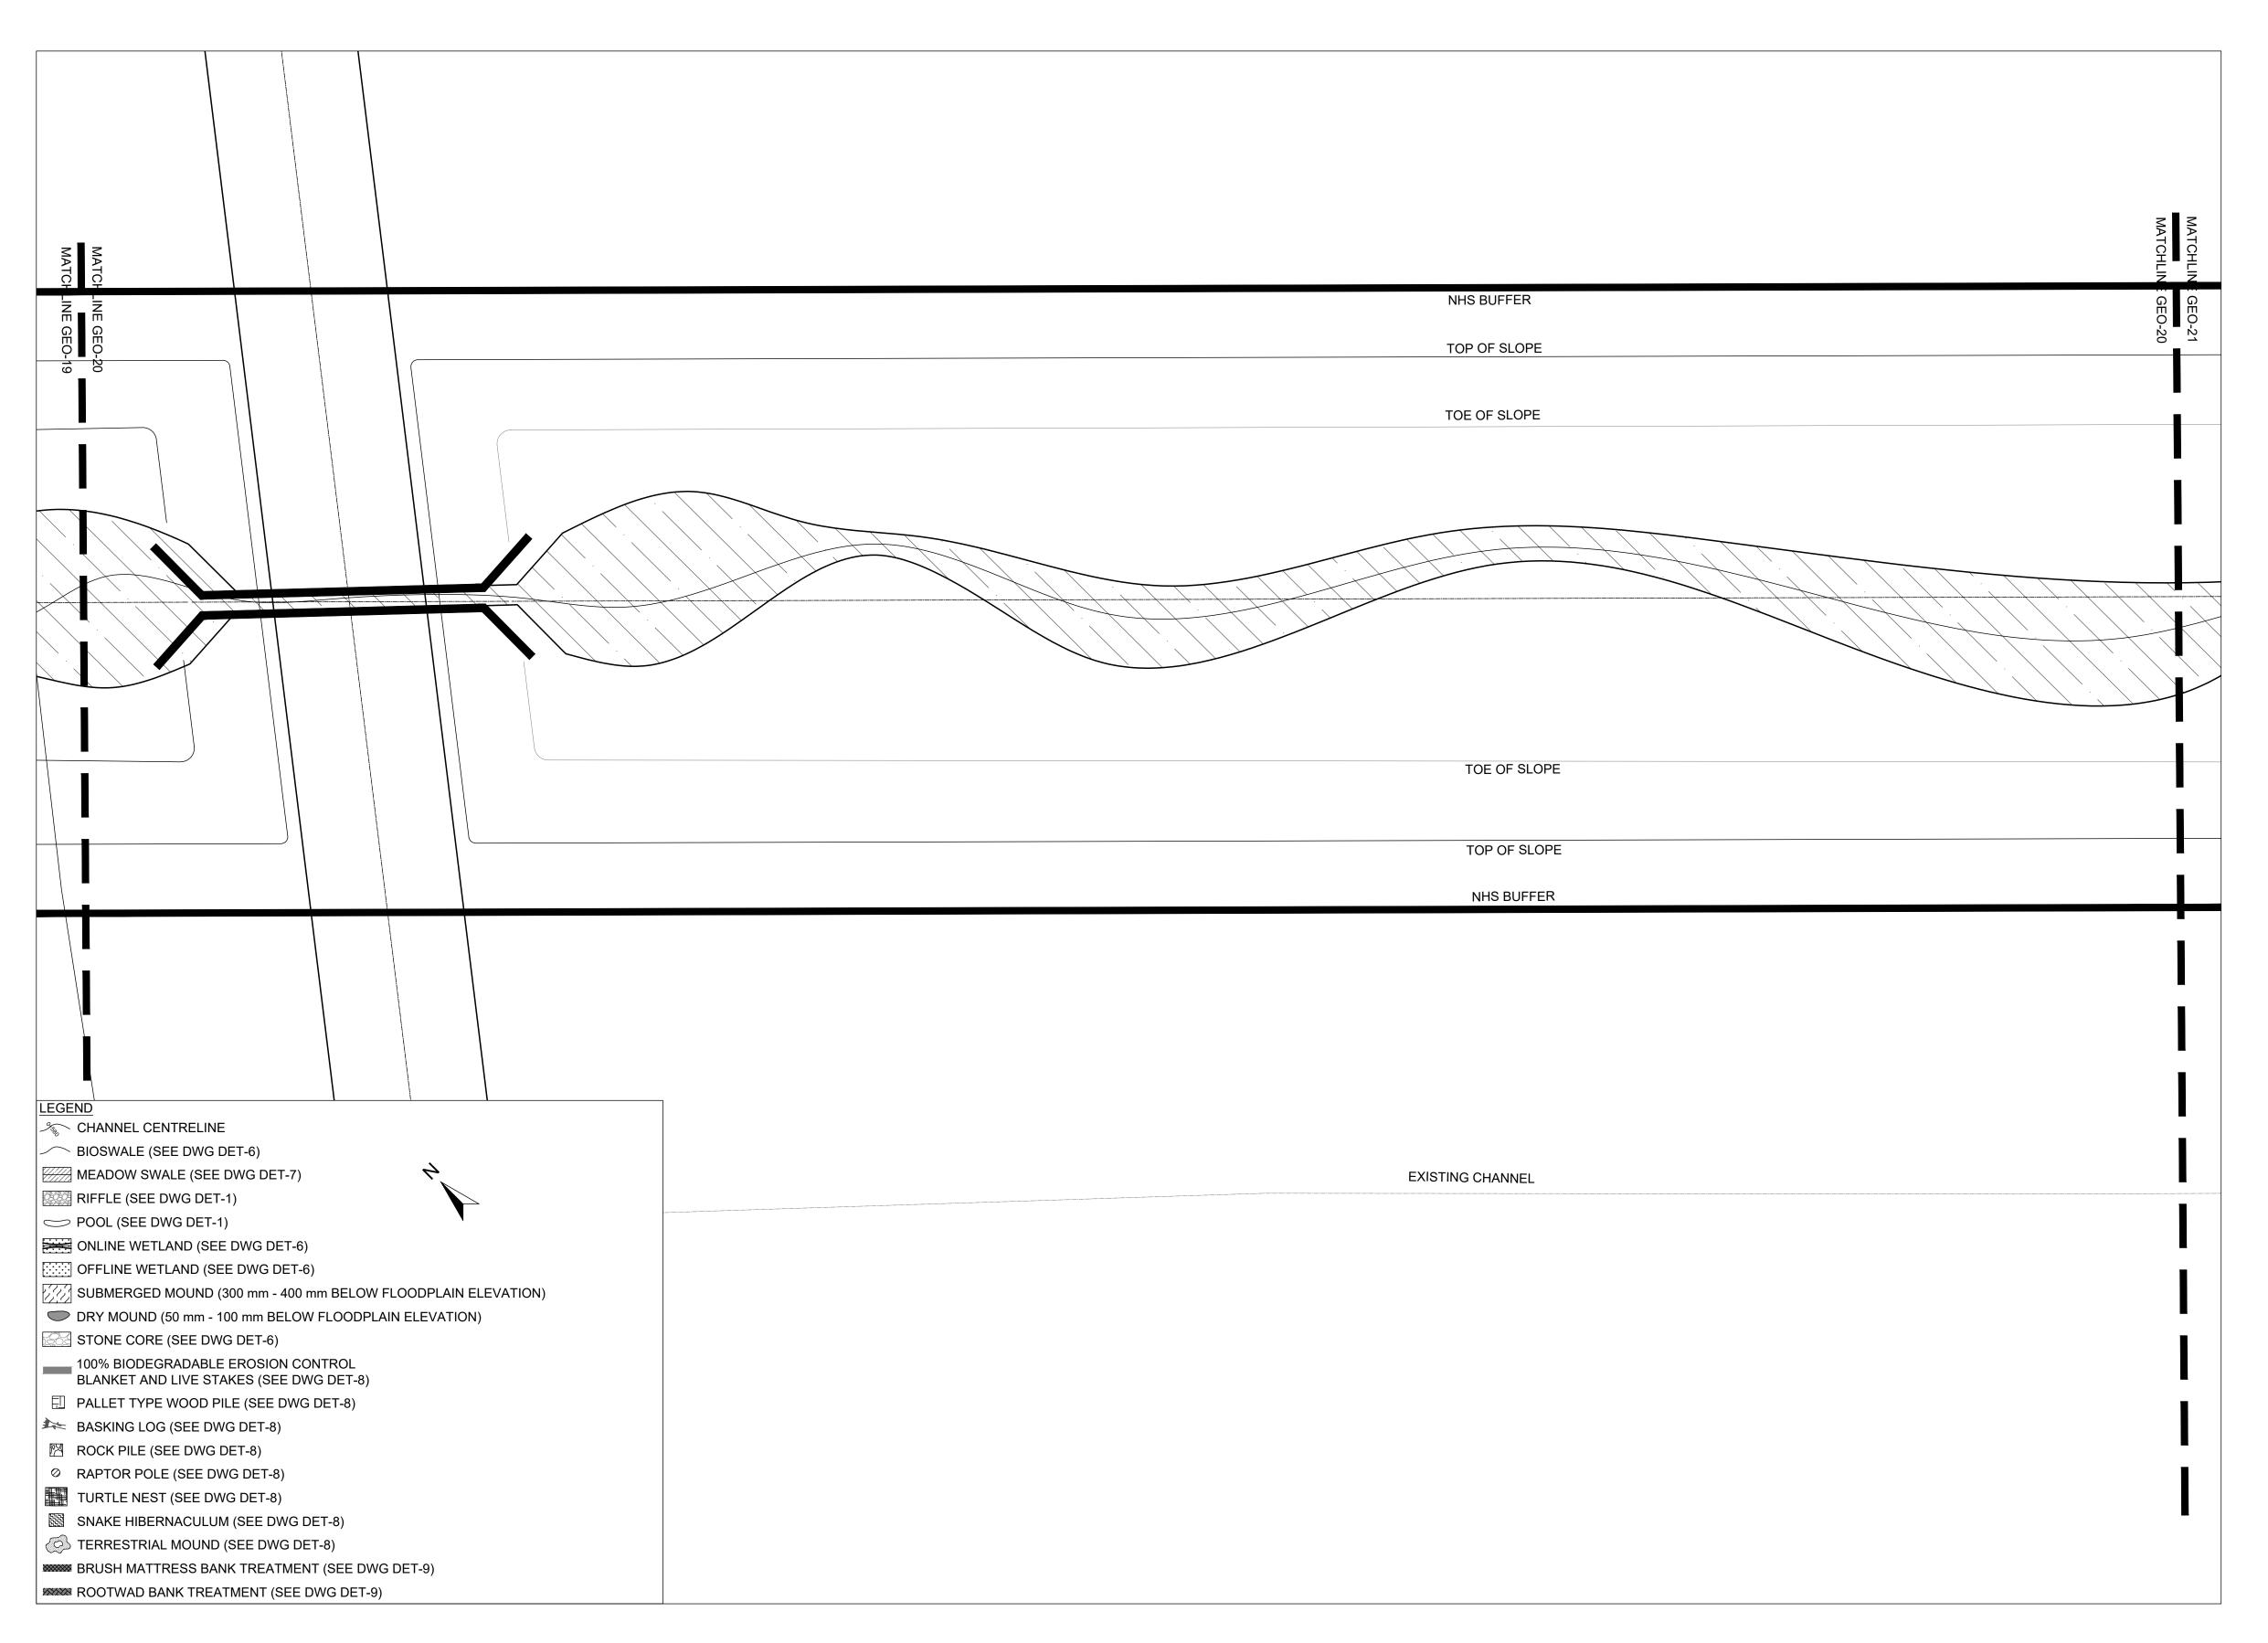

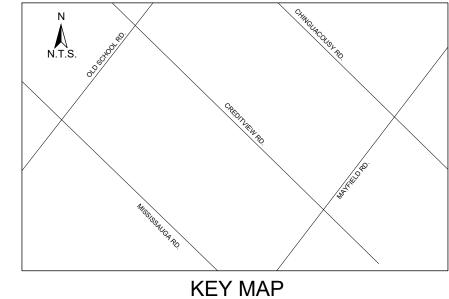

CONJUNCTION WITH THIS DRAWING SET.

- 1. THE ACCOMPANYING CHANNEL REALIGNMENT TECHNICAL DESIGN BRIEF PREPARED BY GEO MORPHIX LTD. (2023) PROVIDES ADDITIONAL DESIGN DETAILS AND DIRECTION FOR IMPLEMENTATION AND IS TO BE REVIEWED IN
- 2. ALL CONTRACT DRAWINGS, SPECIFICATIONS AND APPLICABLE PERMITS MUST BE KEPT ON SITE DURING CONSTRUCTION FOR REFERENCE.

 3. THE CONTRACTOR MUST NOTIFY THE DESIGNER AND CONTRACT ADMINISTRATOR OF THE INTENT TO COMMENCE
- WORK AT LEAST 48 HOURS IN ADVANCE.
- 4. THE CONTRACTOR IS RESPONSIBLE FOR ALL UTILITY LOCATES.
 5. LAYOUT MUST BE REVIEWED AND APPROVED BY THE DESIGNER / DESIGNER REPRESENTATIVE, DESIGNATED
- ENGINEER, AND THE CONTRACT ADMINISTRATOR. CONSTRUCTION OBSERVATION IS TO BE PERFORMED BY A CERTIFIED FLUVIAL GEOMORPHOLOGIST OR EXPERIENCED ENVIRONMENTAL INSPECTOR UNDER DIRECTION FROM THE DESIGNER.
- 7. ON-SITE SUPPORT FROM PROJECT ENGINEER (E.G., GEOTECHNICAL, HYDROGEOLOGICAL, AND/OR WATER
- RESOURCES ENGINEER) REQUIRED TO ASSESS AND ENSURE FAVOURABLE SURFICIAL AND SUBSURFACE CONDITIONS TO SUPPORT CHANNEL REALIGNMENT CONSTRUCTION. 8. BE ADVISED THAT THE LOCAL REGULATORY BODY MAY, AT ANY TIME, WITHDRAW THIS PERMISSION, IF, IN THE
- OPINION OF THE AUTHORITY, THE CONDITIONS OF THE PERMIT ARE NOT BEING COMPLIED WITH. THIS APPROVAL DOES NOT EXEMPT THE PROPERTY OWNER/APPLICANT/AGENT FROM THE PROVISIONS OF ANY OTHER FEDERAL, PROVINCIAL OR MUNICIPAL STATUTES, REGULATIONS OR BY-LAWS, OR ANY RIGHTS UNDER COMMON LAW.

TIMING OF WORKS

- 2. TREE CLEARING IS TO BE COMPLETED OUTSIDE THE BIRD NESTING SEASON (APRIL 1ST TO AUGUST 1ST) TO COMPLY WITH THE FEDERAL MIGRATORY BIRDS CONVENTION ACT. ANY TREES THAT REQUIRE REMOVAL OUTSIDE
- OF THIS TIMING WINDOW MUST FIRST BE INSPECTED BY A QUALIFIED BIOLOGIST TO DETERMINE THE PRESENCE OF

1. WORKS SHALL BE COMPLETED DURING THE DESIGNATED IN-WATER WORKS WINDOW SET OUT BY MNRF/DFO.

- 3. THE WEATHER FORECAST SHOULD BE CONTINUALLY MONITORED TO ENSURE THAT WORKS ARE UNDERTAKEN
- ONLY DURING FAVOURABLE WEATHER CONDITIONS. 4. COMPLETE THE WORKS WITH MINIMAL AVOIDABLE INTERRUPTIONS ONCE THEY COMMENCE.

SITE AND MATERIAL MANAGEMENT

- 1. ALL CONSTRUCTION EQUIPMENT AND MATERIALS (IMPORTED OR EXCAVATED) MUST BE STORED AT LEAST 30 m AWAY FROM ANY WATERBODY IN A STABLE AREA ABOVE THE ACTIVE FLOODPLAIN, OR IN A DESIGNATED
- 2. IN THE EVENT OF AN UNEXPECTED STORM, ALL UNFIXED ITEMS THAT HAVE THE POTENTIAL TO CAUSE A SPILL OR AN OBSTRUCTION TO FLOW MUST BE MOVED A STABLE AREA ABOVE ACTIVE FLOODPLAIN. 3. STOCKPILES MUST BE LOCATED OUTSIDE THE ISOLATED WORK AREAS.
- 4. STABILIZE, TEMPORARILY OR PERMANENTLY, ANY DISTURBED AREAS AS WORK PROGRESSES, OR SOON AS CONDITIONS ALLOW. 5. MINIMIZE THE AREA OF DISTURBANCE TO THE EXTENT POSSIBLE. ALL DISTURBED GROUND LEFT INACTIVE FOR
- MORE THAN 30 DAYS SHALL BE STABILIZED USING APPROPRIATE EROSION CONTROL MEASURES AND AN APPROPRIATE SEED MIX AS NOTED WITHIN THE FINAL APPROVED RESTORATION PLAN.
- 6. ALL VEGETATION, ADJACENT TO THE WORK AREA, MUST BE PROTECTED AND DELINEATED WITH CONSTRUCTION FENCING OR TREE PROTECTION BARRIERS.
- 7. ALL GRADES IN THE AREA REGULATED BY THE CONSERVATION AUTHORITY MUST BE MAINTAINED OR MATCHED,
- UNLESS OTHERWISE AUTHORIZED IN THE APPLICABLE PERMIT.

 8. AN AFTER-HOURS CONTACT NUMBER IS TO BE VISIBLY POSTED ONSITE FOR EMERGENCIES. ALL THE PLANS SHOULD HAVE NAME AND CONTACT INFO OF THE PERSON RESPONSIBLE FOR ESC MEASURES.

EROSION AND SEDIMENT CONTROL

- ALL TEMPORARY EROSION AND SEDIMENT CONTROL MEASURES MUST BE INSTALLED PRIOR TO START OF WORKS.
 FOLLOWING INSTALLATION OF THE PROPOSED ESC MEASURES, A QUALIFIED AGENT OF THE PROPONENT (E.G. CAN-CISEC CERTIFIED MONITOR) WILL CONDUCT REGULAR SITÉ VISITS TO MONITOR ALL WORKS, PARTICULARLY THE CONDITION OF THE ESC MEASURES, DEWATERING, AND IN- OR NEAR-WATER WORKS. SHOULD CONCERNS ARISE; THE ENVIRONMENTAL MONITOR WILL CONTACT THE PROPONENT, THE CONSERVATION AUTHORITY, AND
- ANY OTHER APPROPRIATE PARTIES. 3. EROSION AND SEDIMENT CONTROLS MUST BE MAINTAINED DURING CONSTRUCTION, AND ANY REQUIRED REPAIRS OR REPLACEMENTS MUST BE COMPLETED WITHIN 24 HOURS AFTER THEY HAVE BEEN IDENTIFIED DURING THE
- 4. EROSION AND SEDIMENT CONTROLS MAY REQUIRE PERIODIC ADJUSTMENTS TO REFLECT CHANGING SITE CONDITIONS. THE CONTRACTOR WILL BE RESPONSIBLE FOR THESE ADJUSTMENTS TO ENSURE PROPER
- ANY CHANGES TO THE EROSION AND SEDIMENT CONTROL PLAN BEYOND MINOR ADJUSTMENTS MUST BE APPROVED BY THE CONTRACT ADMINISTRATOR.
- 6. ADDITIONAL EROSION AND SEDIMENT CONTROL SUPPLIES MUST BE KEPT ON SITE IN ORDER TO FACILITATE IMMEDIATE REPAIRS AND/OR UPGRADES AS NEEDED.
- 7. ALL TEMPORARY SEDIMENT CONTROLS MUST BE REMOVED AFTER THE CONTRACT ADMINISTRATOR DEEMS THE 8. THE PROJECT PROPONENT OR THEIR REPRESENTATIVE IS ULTIMATELY RESPONSIBLE FOR CONTROLLING
- SEDIMENT AND EROSION WITHIN THE CONSTRUCTION SITE FOR THE TOTAL PERIOD OF THE CONSTRUCTION. 9. IF EXCESSIVE SILTATION RESULTS FROM THE CONSTRUCTION ACTIVITIES, THE ONSITE SUPERVISOR/INSPECTOR
- AND/OR THE LOCAL REGULATORY BODY RESERVE THE RIGHT TO REQUEST ADDITIONAL ESC MEASURES WHICH WOULD BE INSTALLED PRIOR TO FURTHER CONSTRUCTION ACTIVITIES.

DELETERIOUS SUBSTANCE CONTROL/SPILL MANAGEMENT

- 1. PREVENT THE RELEASE OF SEDIMENT, SEDIMENT-LADEN WATER, RAW CONCRETE, CONCRETE LEACHATE OR ANY OTHER DELETERIOUS SUBSTANCES INTO ANY WATERBODY. RAVINE OR STORM SEWER SYSTEM. 2. ENSURE EQUIPMENT AND MACHINERY ARE IN GOOD OPERATING CONDITION (POWER WASHED), FREE OF LEAKS,
- EXCESS OIL, AND GREASE. 3. NO EQUIPMENT REFUELLING OR SERVICING SHOULD BE UNDERTAKEN WITHIN 30 m OF ANY WATERCOURSE OR
- SURFACE WATER DRAINAGE. A SPILL CONTAINMENT KIT MUST BE READILY ACCESSIBLE ON SITE IN THE EVENT OF A RELEASE OF A DELETERIOUS SUBSTANCE TO THE ENVIRONMENT. ONSITE STAFF MUST BE TRAINED IN ITS USE.
- 5. THE CONTRACT ADMINISTRATOR MUST BE NOTIFIED IMMEDIATELY IN THE EVENT OF A SPILL OF DELETERIOUS SUBSTANCE. ANY SEDIMENT SPILL FROM THE SITE SHOULD BE REPORTED TO MINISTRY OF ENVIRONMENT (SPILL ACTION CENTER) AT 1-800-268-6060.

WORK AREA ISOLATION

- 1. ALL WORK IN ISOLATED WORK AREAS MUST BE COMPLETED IN THE DRY. AN ADEQUATE NUMBER OF PUMPS MUST
- BE USED FOR UNWATERING.
 2. CROSSING AN ACTIVE WATERCOURSE OR WETLAND BY EQUIPMENT, VEHICLES, PERSONNEL, ETC. IS NOT PERMITTED UNLESS APPROVED BY THE CONSERVATION AUTHORITY. ALL ACCESS TO WORK SITES SHALL BE FROM
- EITHER SIDES OF THE WATERCOURSE OR WETLAND. 3. THE UNWATERING DISCHARGE LOCATION MUST BE LOCATED AT LEAST 30 M FROM ANY WATERCOURSE OR WETLAND IN AN AREA WITH DENSE VEGETATIVE GROUNDCOVER, AND WHERE THE DISCHARGE CAN RETURN TO
- THE WATERBODY DOWNSTREAM OF THE WORK AREA OVER THE GROUNDCOVER. 4. FISH MUST BE REMOVED FROM THE WORK AREA ONCE ISOLATED. FISH SALVAGE MUST BE COMPLETED BY A
- QUALIFIED TECHNICIAN WITH A LICENSE FROM THE ONTARIO MINISTRY OF NATURAL RESOURCES AND FORESTRY

DATE BY REVISIONS CHECKED BY: PV DESIGNED BY: LD/AS

DRAWN BY: AL/CP/SC DATE: JUNE 2024

DRAFT FOR **INTERNAL** DISCUSSION

 $M O R P H I X^{\mathsf{m}}$

NOT FOR CONSTRUCTION

36 Main St N., P.O. Box 205 Campbellville, Ontario L0P 1B0 T: 416.920.0926 www.geomorphix.com


ALLOA SPA TOWN OF CALEDON


ETOBICOKE CREEK - ALLOA DRAIN CONCEPTUAL CHANNEL DESIGN DRY SWALE PLANFORM

PROJECT No.: PN24009 DRAWING No.: GEO-20

SCALED FOR PLOT ON 'ARCH D'

SCALE: AS NOTED SHEET 21 OF 35

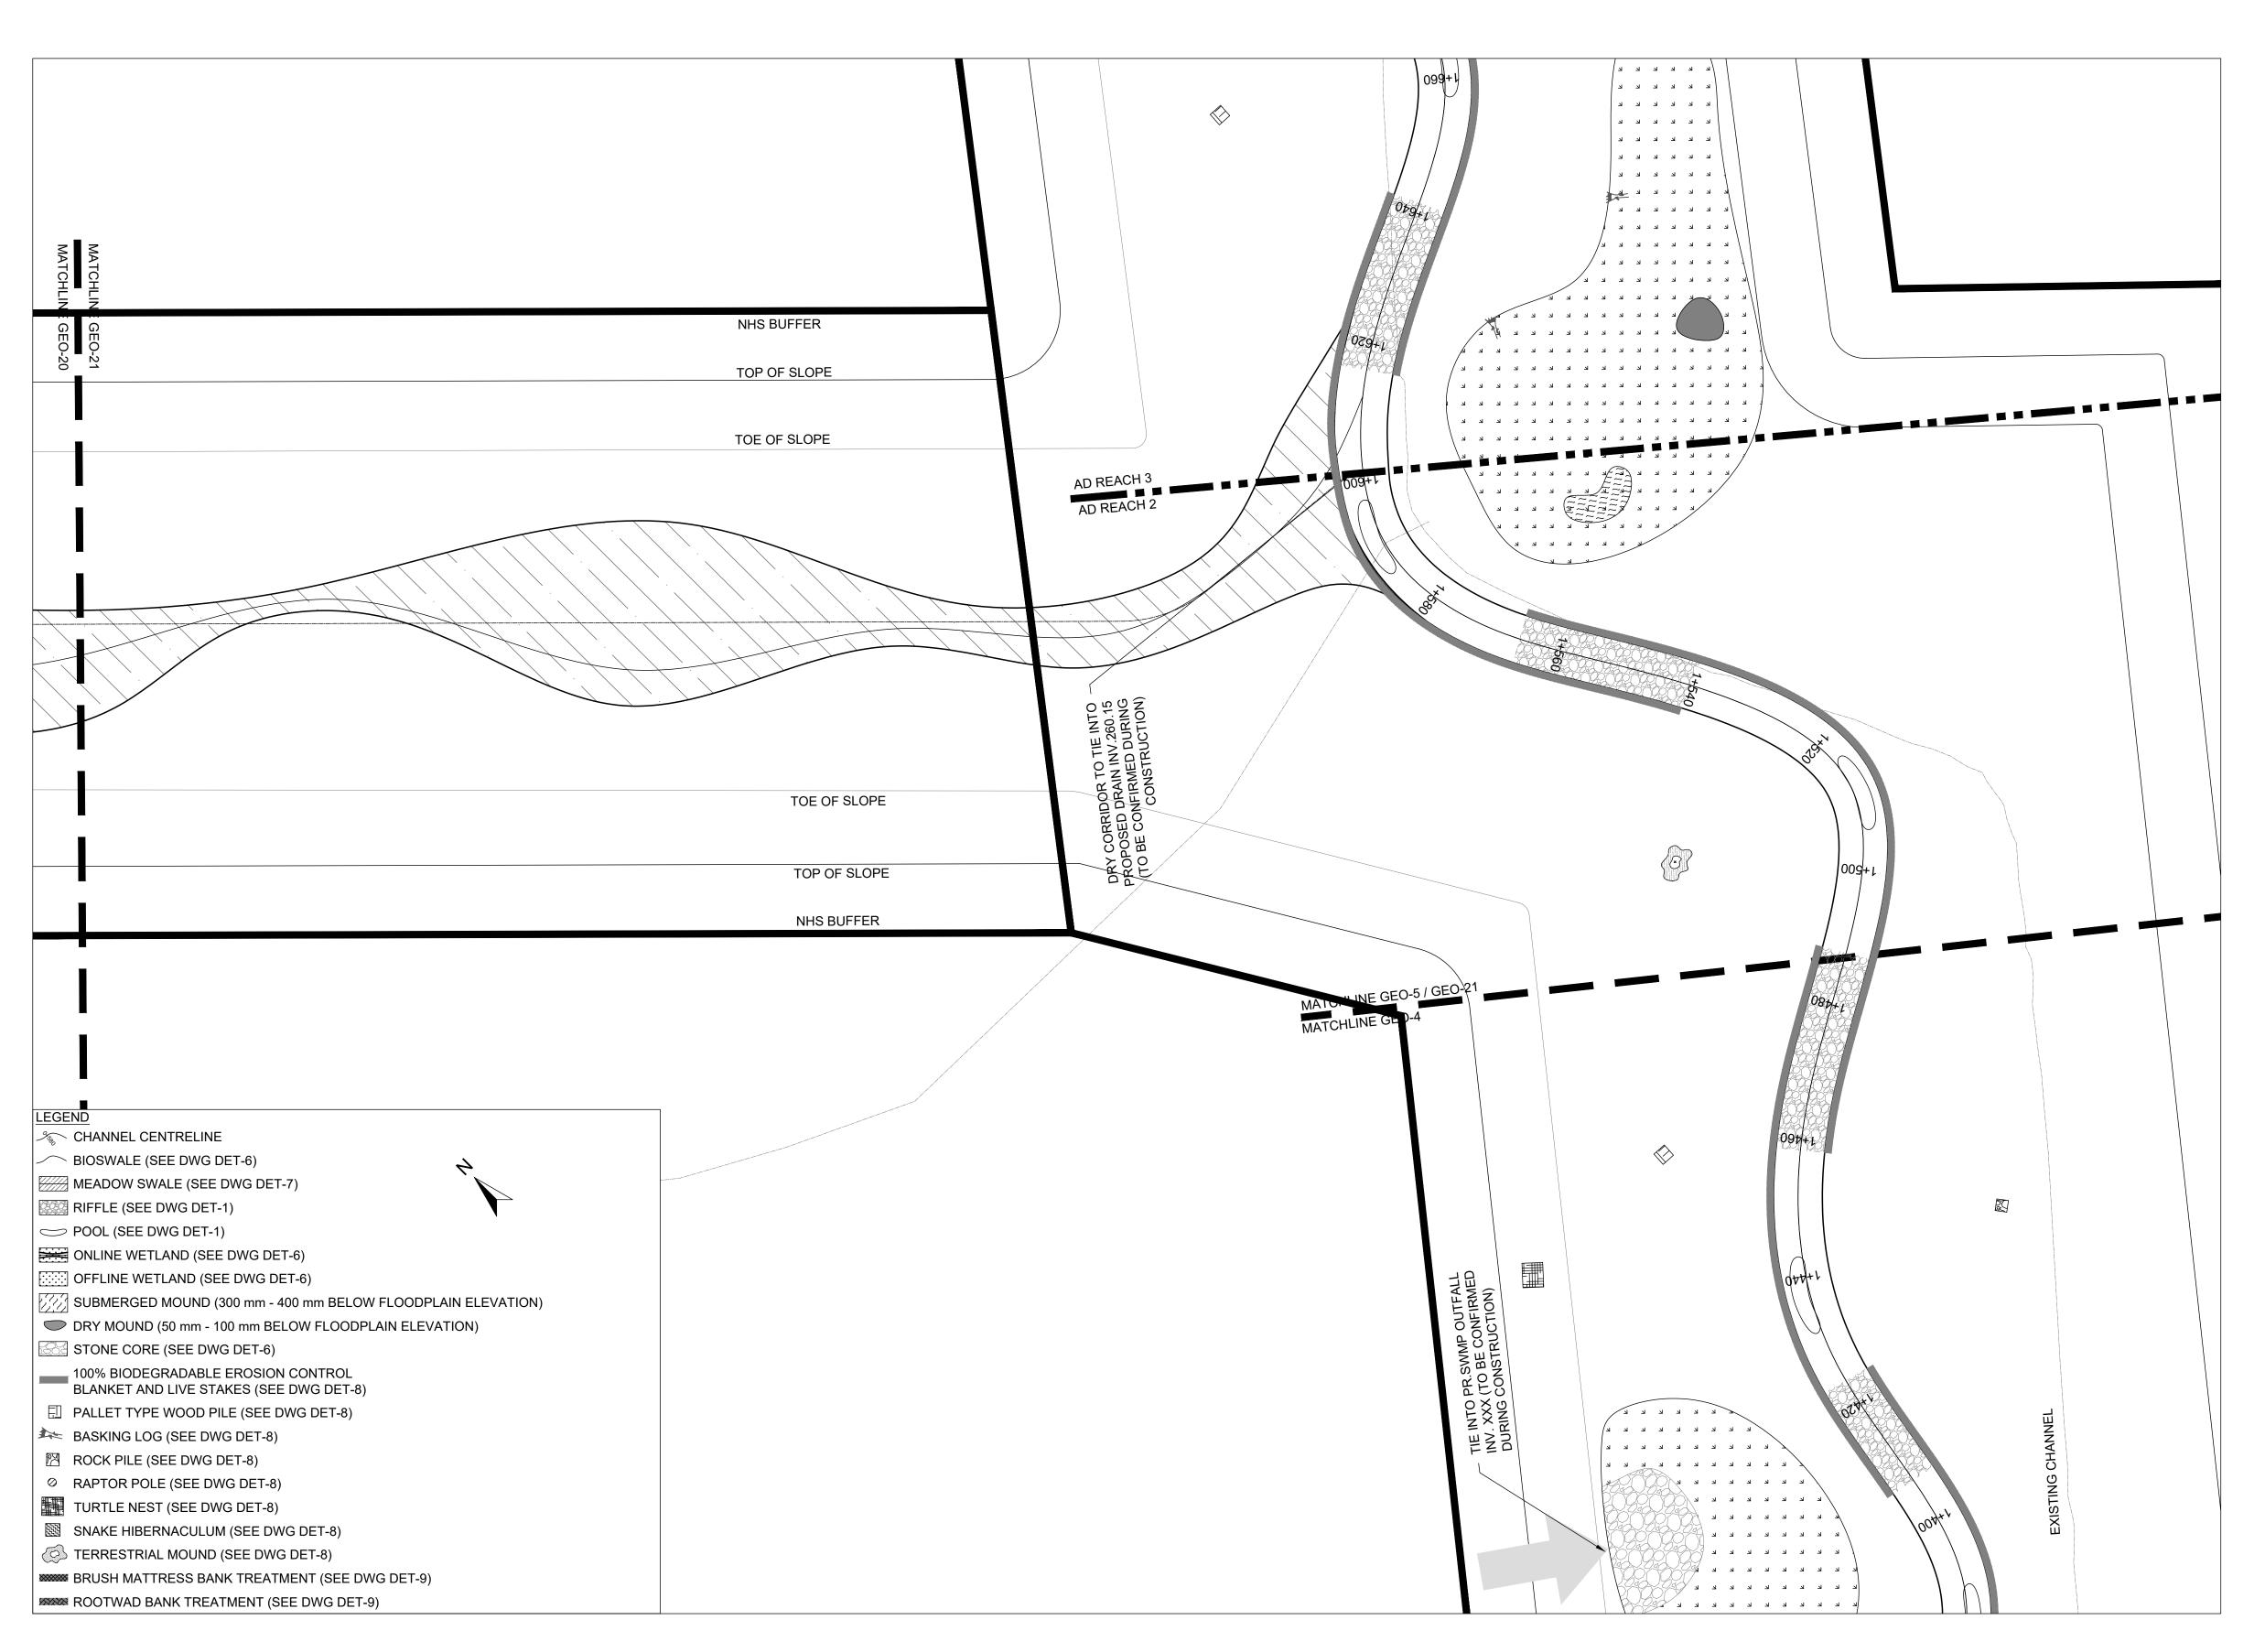

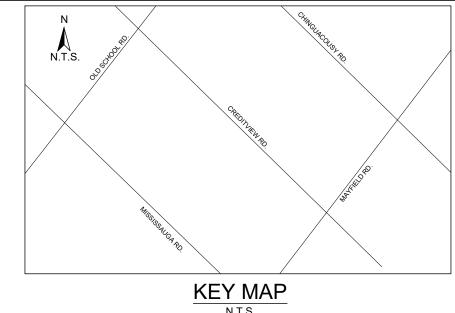

- 1. THE ACCOMPANYING CHANNEL REALIGNMENT TECHNICAL DESIGN BRIEF PREPARED BY GEO MORPHIX LTD. (2023) PROVIDES ADDITIONAL DESIGN DETAILS AND DIRECTION FOR IMPLEMENTATION AND IS TO BE REVIEWED IN CONJUNCTION WITH THIS DRAWING SET.
- 2. ALL CONTRACT DRAWINGS, SPECIFICATIONS AND APPLICABLE PERMITS MUST BE KEPT ON SITE DURING CONSTRUCTION FOR REFERENCE.

 3. THE CONTRACTOR MUST NOTIFY THE DESIGNER AND CONTRACT ADMINISTRATOR OF THE INTENT TO COMMENCE
- WORK AT LEAST 48 HOURS IN ADVANCE.
- 4. THE CONTRACTOR IS RESPONSIBLE FOR ALL UTILITY LOCATES.
 5. LAYOUT MUST BE REVIEWED AND APPROVED BY THE DESIGNER / DESIGNER REPRESENTATIVE, DESIGNATED ENGINEER, AND THE CONTRACT ADMINISTRATOR.
- CONSTRUCTION OBSERVATION IS TO BE PERFORMED BY A CERTIFIED FLUVIAL GEOMORPHOLOGIST OR EXPERIENCED ENVIRONMENTAL INSPECTOR UNDER DIRECTION FROM THE DESIGNER.
- 7. ON-SITE SUPPORT FROM PROJECT ENGINEER (E.G., GEOTECHNICAL, HYDROGEOLOGICAL, AND/OR WATER
- RESOURCES ENGINEER) REQUIRED TO ASSESS AND ENSURE FAVOURABLE SURFICIAL AND SUBSURFACE CONDITIONS TO SUPPORT CHANNEL REALIGNMENT CONSTRUCTION. 8. BE ADVISED THAT THE LOCAL REGULATORY BODY MAY, AT ANY TIME, WITHDRAW THIS PERMISSION, IF, IN THE
- OPINION OF THE AUTHORITY. THE CONDITIONS OF THE PERMIT ARE NOT BEING COMPLIED WITH. THIS APPROVAL DOES NOT EXEMPT THE PROPERTY OWNER/APPLICANT/AGENT FROM THE PROVISIONS OF ANY OTHER FEDERAL, PROVINCIAL OR MUNICIPAL STATUTES, REGULATIONS OR BY-LAWS, OR ANY RIGHTS UNDER COMMON LAW.

TIMING OF WORKS

- 1. WORKS SHALL BE COMPLETED DURING THE DESIGNATED IN-WATER WORKS WINDOW SET OUT BY MNRF/DFO. TREE CLEARING IS TO BE COMPLETED OUTSIDE THE BIRD NESTING SEASON (APRIL 1ST TO AUGUST 1ST) TO COMPLY WITH THE FEDERAL MIGRATORY BIRDS CONVENTION ACT. ANY TREES THAT REQUIRE REMOVAL OUTSIDE
- OF THIS TIMING WINDOW MUST FIRST BE INSPECTED BY A QUALIFIED BIOLOGIST TO DETERMINE THE PRESENCE OF 3. THE WEATHER FORECAST SHOULD BE CONTINUALLY MONITORED TO ENSURE THAT WORKS ARE UNDERTAKEN
- ONLY DURING FAVOURABLE WEATHER CONDITIONS. 4. COMPLETE THE WORKS WITH MINIMAL AVOIDABLE INTERRUPTIONS ONCE THEY COMMENCE.

SITE AND MATERIAL MANAGEMENT

- 1. ALL CONSTRUCTION EQUIPMENT AND MATERIALS (IMPORTED OR EXCAVATED) MUST BE STORED AT LEAST 30 m
- AWAY FROM ANY WATERBODY IN A STABLE AREA ABOVE THE ACTIVE FLOODPLAIN, OR IN A DESIGNATED
- 2. IN THE EVENT OF AN UNEXPECTED STORM, ALL UNFIXED ITEMS THAT HAVE THE POTENTIAL TO CAUSE A SPILL OR AN OBSTRUCTION TO FLOW MUST BE MOVED A STABLE AREA ABOVE ACTIVE FLOODPLAIN. 3. STOCKPILES MUST BE LOCATED OUTSIDE THE ISOLATED WORK AREAS.
- 4. STABILIZE, TEMPORARILY OR PERMANENTLY, ANY DISTURBED AREAS AS WORK PROGRESSES, OR SOON AS CONDITIONS ALLOW. 5. MINIMIZE THE AREA OF DISTURBANCE TO THE EXTENT POSSIBLE. ALL DISTURBED GROUND LEFT INACTIVE FOR MORE THAN 30 DAYS SHALL BE STABILIZED USING APPROPRIATE EROSION CONTROL MEASURES AND AN
- APPROPRIATE SEED MIX AS NOTED WITHIN THE FINAL APPROVED RESTORATION PLAN. 6. ALL VEGETATION, ADJACENT TO THE WORK AREA, MUST BE PROTECTED AND DELINEATED WITH CONSTRUCTION
- FENCING OR TREE PROTECTION BARRIERS. 7. ALL GRADES IN THE AREA REGULATED BY THE CONSERVATION AUTHORITY MUST BE MAINTAINED OR MATCHED,
- UNLESS OTHERWISE AUTHORIZED IN THE APPLICABLE PERMIT.

 8. AN AFTER-HOURS CONTACT NUMBER IS TO BE VISIBLY POSTED ONSITE FOR EMERGENCIES. ALL THE PLANS SHOULD HAVE NAME AND CONTACT INFO OF THE PERSON RESPONSIBLE FOR ESC MEASURES.

EROSION AND SEDIMENT CONTROL

- ALL TEMPORARY EROSION AND SEDIMENT CONTROL MEASURES MUST BE INSTALLED PRIOR TO START OF WORKS.
 FOLLOWING INSTALLATION OF THE PROPOSED ESC MEASURES, A QUALIFIED AGENT OF THE PROPONENT (E.G. CAN-CISEC CERTIFIED MONITOR) WILL CONDUCT REGULAR SITÉ VISITS TO MONITOR ALL WORKS, PARTICULARLY THE CONDITION OF THE ESC MEASURES, DEWATERING, AND IN- OR NEAR-WATER WORKS. SHOULD CONCERNS ARISE; THE ENVIRONMENTAL MONITOR WILL CONTACT THE PROPONENT, THE CONSERVATION AUTHORITY, AND
- ANY OTHER APPROPRIATE PARTIES. 3. EROSION AND SEDIMENT CONTROLS MUST BE MAINTAINED DURING CONSTRUCTION, AND ANY REQUIRED REPAIRS OR REPLACEMENTS MUST BE COMPLETED WITHIN 24 HOURS AFTER THEY HAVE BEEN IDENTIFIED DURING THE
- 4. EROSION AND SEDIMENT CONTROLS MAY REQUIRE PERIODIC ADJUSTMENTS TO REFLECT CHANGING SITE CONDITIONS. THE CONTRACTOR WILL BE RESPONSIBLE FOR THESE ADJUSTMENTS TO ENSURE PROPER
- ANY CHANGES TO THE EROSION AND SEDIMENT CONTROL PLAN BEYOND MINOR ADJUSTMENTS MUST BE APPROVED BY THE CONTRACT ADMINISTRATOR.
- 6. ADDITIONAL EROSION AND SEDIMENT CONTROL SUPPLIES MUST BE KEPT ON SITE IN ORDER TO FACILITATE
- IMMEDIATE REPAIRS AND/OR UPGRADES AS NEEDED. 7. ALL TEMPORARY SEDIMENT CONTROLS MUST BE REMOVED AFTER THE CONTRACT ADMINISTRATOR DEEMS THE
- 8. THE PROJECT PROPONENT OR THEIR REPRESENTATIVE IS ULTIMATELY RESPONSIBLE FOR CONTROLLING SEDIMENT AND EROSION WITHIN THE CONSTRUCTION SITE FOR THE TOTAL PERIOD OF THE CONSTRUCTION.
- 9. IF EXCESSIVE SILTATION RESULTS FROM THE CONSTRUCTION ACTIVITIES, THE ONSITE SUPERVISOR/INSPECTOR AND/OR THE LOCAL REGULATORY BODY RESERVE THE RIGHT TO REQUEST ADDITIONAL ESC MEASURES WHICH WOULD BE INSTALLED PRIOR TO FURTHER CONSTRUCTION ACTIVITIES.

DELETERIOUS SUBSTANCE CONTROL/SPILL MANAGEMENT

- 1. PREVENT THE RELEASE OF SEDIMENT, SEDIMENT-LADEN WATER, RAW CONCRETE, CONCRETE LEACHATE OR ANY OTHER DELETERIOUS SUBSTANCES INTO ANY WATERBODY. RAVINE OR STORM SEWER SYSTEM. 2. ENSURE EQUIPMENT AND MACHINERY ARE IN GOOD OPERATING CONDITION (POWER WASHED), FREE OF LEAKS, EXCESS OIL, AND GREASE.

 3. NO EQUIPMENT REFUELLING OR SERVICING SHOULD BE UNDERTAKEN WITHIN 30 m OF ANY WATERCOURSE OR
- SURFACE WATER DRAINAGE. A SPILL CONTAINMENT KIT MUST BE READILY ACCESSIBLE ON SITE IN THE EVENT OF A RELEASE OF A DELETERIOUS SUBSTANCE TO THE ENVIRONMENT. ONSITE STAFF MUST BE TRAINED IN ITS USE.
- 5. THE CONTRACT ADMINISTRATOR MUST BE NOTIFIED IMMEDIATELY IN THE EVENT OF A SPILL OF DELETERIOUS SUBSTANCE. ANY SEDIMENT SPILL FROM THE SITE SHOULD BE REPORTED TO MINISTRY OF ENVIRONMENT (SPILL ACTION CENTER) AT 1-800-268-6060.

WORK AREA ISOLATION

- 1. ALL WORK IN ISOLATED WORK AREAS MUST BE COMPLETED IN THE DRY. AN ADEQUATE NUMBER OF PUMPS MUST BE USED FOR UNWATERING.
 2. CROSSING AN ACTIVE WATERCOURSE OR WETLAND BY EQUIPMENT, VEHICLES, PERSONNEL, ETC. IS NOT
- PERMITTED UNLESS APPROVED BY THE CONSERVATION AUTHORITY. ALL ACCESS TO WORK SITES SHALL BE FROM
- EITHER SIDES OF THE WATERCOURSE OR WETLAND. 3. THE UNWATERING DISCHARGE LOCATION MUST BE LOCATED AT LEAST 30 M FROM ANY WATERCOURSE OR WETLAND IN AN AREA WITH DENSE VEGETATIVE GROUNDCOVER, AND WHERE THE DISCHARGE CAN RETURN TO THE WATERBODY DOWNSTREAM OF THE WORK AREA OVER THE GROUNDCOVER.
- 4. FISH MUST BE REMOVED FROM THE WORK AREA ONCE ISOLATED. FISH SALVAGE MUST BE COMPLETED BY A QUALIFIED TECHNICIAN WITH A LICENSE FROM THE ONTARIO MINISTRY OF NATURAL RESOURCES AND FORESTRY

DATE BY **REVISIONS** CHECKED BY: PV DESIGNED BY: LD/AS

DRAWN BY: AL/CP/SC DATE: JUNE 2024

DRAFT FOR **INTERNAL** DISCUSSION

 $M O R P H I X^{\mathsf{m}}$


NOT FOR CONSTRUCTION


36 Main St N., P.O. Box 205 Campbellville, Ontario L0P 1B0 T: 416.920.0926 www.geomorphix.com

ALLOA SPA **TOWN OF CALEDON**

ETOBICOKE CREEK - ALLOA DRAIN CONCEPTUAL CHANNEL DESIGN DRY SWALE PLANFORM

PROJECT No.: PN24009 DRAWING No.: GEO-21 SCALE: AS NOTED SHEET 22 OF 35

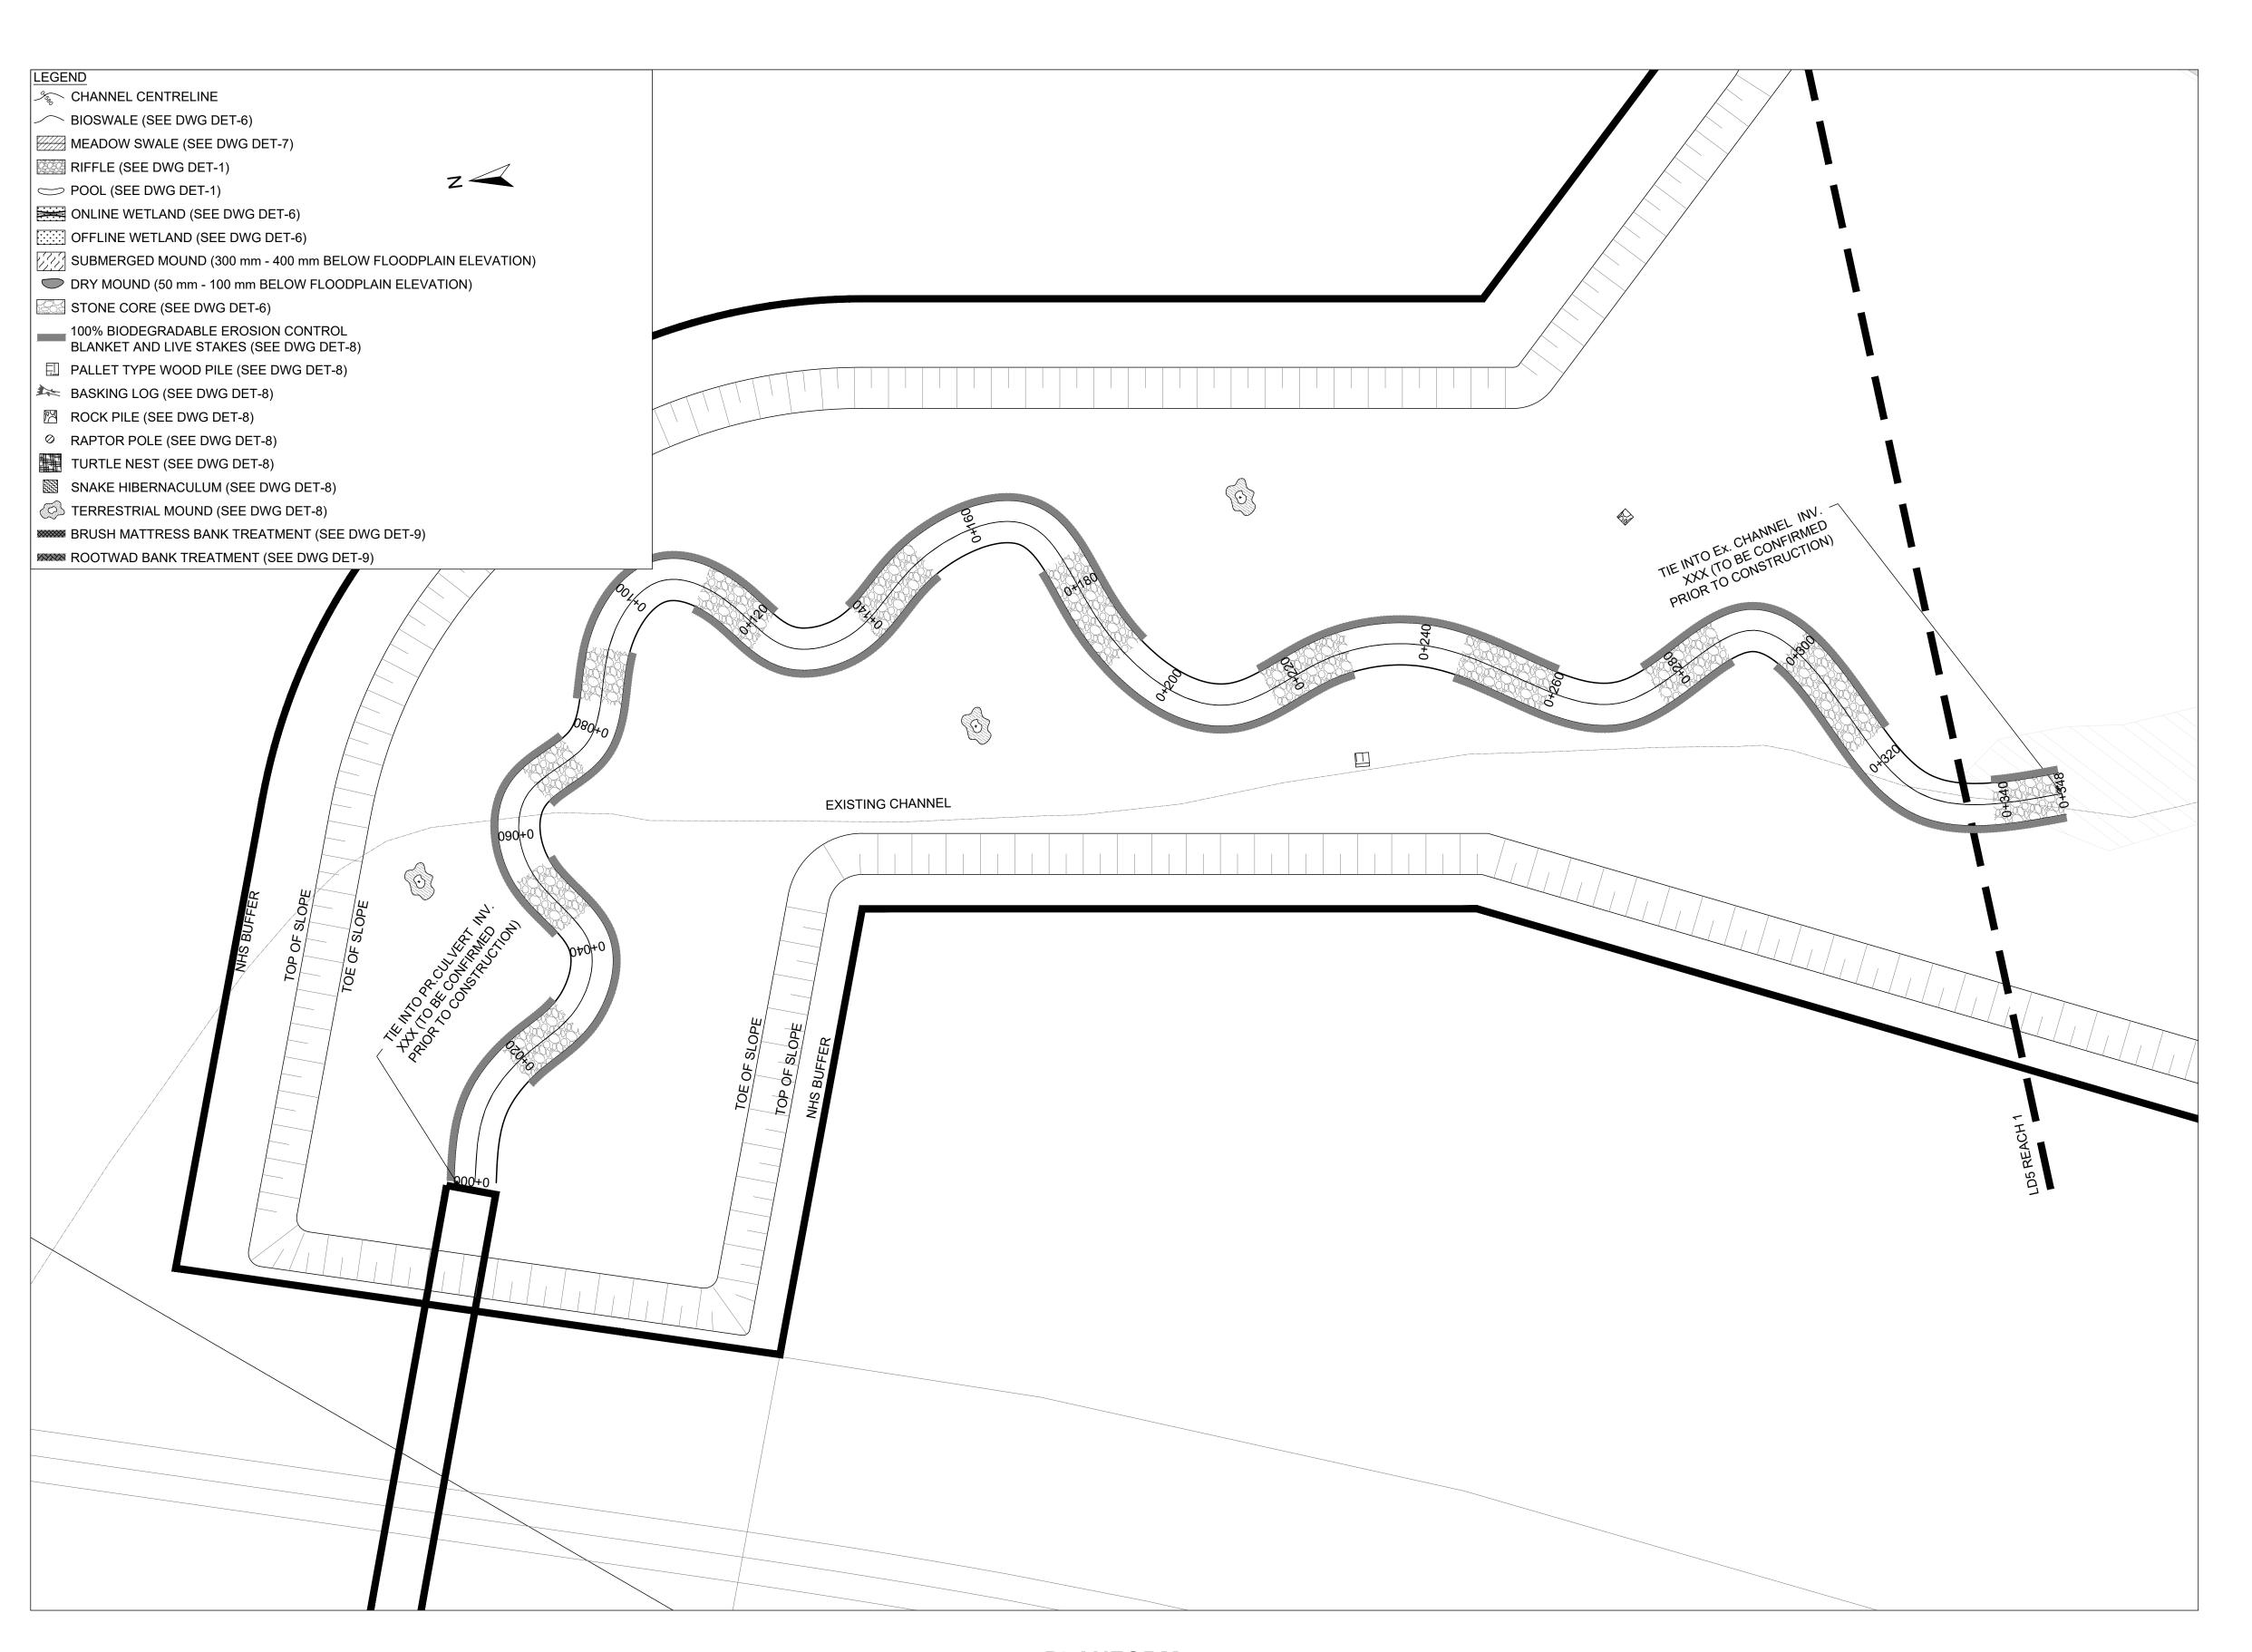

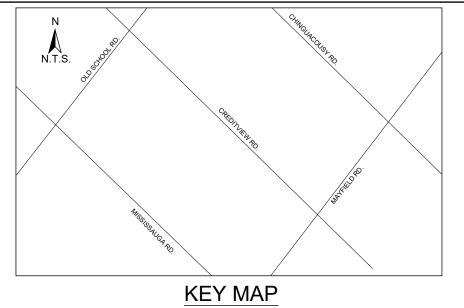

- 1. THE ACCOMPANYING CHANNEL REALIGNMENT TECHNICAL DESIGN BRIEF PREPARED BY GEO MORPHIX LTD. (2023) PROVIDES ADDITIONAL DESIGN DETAILS AND DIRECTION FOR IMPLEMENTATION AND IS TO BE REVIEWED IN CONJUNCTION WITH THIS DRAWING SET.
- 2. ALL CONTRACT DRAWINGS, SPECIFICATIONS AND APPLICABLE PERMITS MUST BE KEPT ON SITE DURING
- CONSTRUCTION FOR REFERENCE.

 3. THE CONTRACTOR MUST NOTIFY THE DESIGNER AND CONTRACT ADMINISTRATOR OF THE INTENT TO COMMENCE WORK AT LEAST 48 HOURS IN ADVANCE.
- 4. THE CONTRACTOR IS RESPONSIBLE FOR ALL UTILITY LOCATES.
 5. LAYOUT MUST BE REVIEWED AND APPROVED BY THE DESIGNER / DESIGNER REPRESENTATIVE, DESIGNATED
- ENGINEER, AND THE CONTRACT ADMINISTRATOR.
- CONSTRUCTION OBSERVATION IS TO BE PERFORMED BY A CERTIFIED FLUVIAL GEOMORPHOLOGIST OR EXPERIENCED ENVIRONMENTAL INSPECTOR UNDER DIRECTION FROM THE DESIGNER.
- 7. ON-SITE SUPPORT FROM PROJECT ENGINEER (E.G., GEOTECHNICAL, HYDROGEOLOGICAL, AND/OR WATER RESOURCES ENGINEER) REQUIRED TO ASSESS AND ENSURE FAVOURABLE SURFICIAL AND SUBSURFACE
- CONDITIONS TO SUPPORT CHANNEL REALIGNMENT CONSTRUCTION. 8. BE ADVISED THAT THE LOCAL REGULATORY BODY MAY, AT ANY TIME, WITHDRAW THIS PERMISSION, IF, IN THE OPINION OF THE AUTHORITY, THE CONDITIONS OF THE PERMIT ARE NOT BEING COMPLIED WITH. THIS APPROVAL DOES NOT EXEMPT THE PROPERTY OWNER/APPLICANT/AGENT FROM THE PROVISIONS OF ANY OTHER FEDERAL,

TIMING OF WORKS

- 1. WORKS SHALL BE COMPLETED DURING THE DESIGNATED IN-WATER WORKS WINDOW SET OUT BY MNRF/DFO. 2. TREE CLEARING IS TO BE COMPLETED OUTSIDE THE BIRD NESTING SEASON (APRIL 1ST TO AUGUST 1ST) TO COMPLY WITH THE FEDERAL MIGRATORY BIRDS CONVENTION ACT. ANY TREES THAT REQUIRE REMOVAL OUTSIDE OF THIS TIMING WINDOW MUST FIRST BE INSPECTED BY A QUALIFIED BIOLOGIST TO DETERMINE THE PRESENCE OF
- 3. THE WEATHER FORECAST SHOULD BE CONTINUALLY MONITORED TO ENSURE THAT WORKS ARE UNDERTAKEN ONLY DURING FAVOURABLE WEATHER CONDITIONS.

PROVINCIAL OR MUNICIPAL STATUTES, REGULATIONS OR BY-LAWS, OR ANY RIGHTS UNDER COMMON LAW.

4. COMPLETE THE WORKS WITH MINIMAL AVOIDABLE INTERRUPTIONS ONCE THEY COMMENCE.

SITE AND MATERIAL MANAGEMENT

- 1. ALL CONSTRUCTION EQUIPMENT AND MATERIALS (IMPORTED OR EXCAVATED) MUST BE STORED AT LEAST 30 m
- AWAY FROM ANY WATERBODY IN A STABLE AREA ABOVE THE ACTIVE FLOODPLAIN, OR IN A DESIGNATED
- 2. IN THE EVENT OF AN UNEXPECTED STORM, ALL UNFIXED ITEMS THAT HAVE THE POTENTIAL TO CAUSE A SPILL OR AN OBSTRUCTION TO FLOW MUST BE MOVED A STABLE AREA ABOVE ACTIVE FLOODPLAIN.
- 3. STOCKPILES MUST BE LOCATED OUTSIDE THE ISOLATED WORK AREAS. 4. STABILIZE, TEMPORARILY OR PERMANENTLY, ANY DISTURBED AREAS AS WORK PROGRESSES, OR SOON AS
- CONDITIONS ALLOW. 5. MINIMIZE THE AREA OF DISTURBANCE TO THE EXTENT POSSIBLE. ALL DISTURBED GROUND LEFT INACTIVE FOR
- MORE THAN 30 DAYS SHALL BE STABILIZED USING APPROPRIATE EROSION CONTROL MEASURES AND AN APPROPRIATE SEED MIX AS NOTED WITHIN THE FINAL APPROVED RESTORATION PLAN.
- 6. ALL VEGETATION, ADJACENT TO THE WORK AREA, MUST BE PROTECTED AND DELINEATED WITH CONSTRUCTION FENCING OR TREE PROTECTION BARRIERS.
- 7. ALL GRADES IN THE AREA REGULATED BY THE CONSERVATION AUTHORITY MUST BE MAINTAINED OR MATCHED,
- UNLESS OTHERWISE AUTHORIZED IN THE APPLICABLE PERMIT.

 8. AN AFTER-HOURS CONTACT NUMBER IS TO BE VISIBLY POSTED ONSITE FOR EMERGENCIES. ALL THE PLANS SHOULD HAVE NAME AND CONTACT INFO OF THE PERSON RESPONSIBLE FOR ESC MEASURES.

EROSION AND SEDIMENT CONTROL

- ALL TEMPORARY EROSION AND SEDIMENT CONTROL MEASURES MUST BE INSTALLED PRIOR TO START OF WORKS.
 FOLLOWING INSTALLATION OF THE PROPOSED ESC MEASURES, A QUALIFIED AGENT OF THE PROPONENT (E.G. CAN-CISEC CERTIFIED MONITOR) WILL CONDUCT REGULAR SITÉ VISITS TO MONITOR ALL WORKS, PARTICULARLY THE CONDITION OF THE ESC MEASURES, DEWATERING, AND IN- OR NEAR-WATER WORKS. SHOULD CONCERNS ARISE; THE ENVIRONMENTAL MONITOR WILL CONTACT THE PROPONENT, THE CONSERVATION AUTHORITY, AND
- ANY OTHER APPROPRIATE PARTIES. 3. EROSION AND SEDIMENT CONTROLS MUST BE MAINTAINED DURING CONSTRUCTION, AND ANY REQUIRED REPAIRS OR REPLACEMENTS MUST BE COMPLETED WITHIN 24 HOURS AFTER THEY HAVE BEEN IDENTIFIED DURING THE
- 4. EROSION AND SEDIMENT CONTROLS MAY REQUIRE PERIODIC ADJUSTMENTS TO REFLECT CHANGING SITE CONDITIONS. THE CONTRACTOR WILL BE RESPONSIBLE FOR THESE ADJUSTMENTS TO ENSURE PROPER
- 5. ANY CHANGES TO THE EROSION AND SEDIMENT CONTROL PLAN BEYOND MINOR ADJUSTMENTS MUST BE APPROVED BY THE CONTRACT ADMINISTRATOR.
- 6. ADDITIONAL EROSION AND SEDIMENT CONTROL SUPPLIES MUST BE KEPT ON SITE IN ORDER TO FACILITATE
- IMMEDIATE REPAIRS AND/OR UPGRADES AS NEEDED.

 7. ALL TEMPORARY SEDIMENT CONTROLS MUST BE REMOVED AFTER THE CONTRACT ADMINISTRATOR DEEMS THE 8. THE PROJECT PROPONENT OR THEIR REPRESENTATIVE IS ULTIMATELY RESPONSIBLE FOR CONTROLLING
- SEDIMENT AND EROSION WITHIN THE CONSTRUCTION SITE FOR THE TOTAL PERIOD OF THE CONSTRUCTION. 9. IF EXCESSIVE SILTATION RESULTS FROM THE CONSTRUCTION ACTIVITIES, THE ONSITE SUPERVISOR/INSPECTOR AND/OR THE LOCAL REGULATORY BODY RESERVE THE RIGHT TO REQUEST ADDITIONAL ESC MEASURES WHICH WOULD BE INSTALLED PRIOR TO FURTHER CONSTRUCTION ACTIVITIES.

DELETERIOUS SUBSTANCE CONTROL/SPILL MANAGEMENT

- PREVENT THE RELEASE OF SEDIMENT, SEDIMENT-LADEN WATER, RAW CONCRETE, CONCRETE LEACHATE OR ANY OTHER DELETERIOUS SUBSTANCES INTO ANY WATERBODY, RAVINE OR STORM SEWER SYSTEM. 2. ENSURE EQUIPMENT AND MACHINERY ARE IN GOOD OPERATING CONDITION (POWER WASHED), FREE OF LEAKS, EXCESS OIL, AND GREASE.

 3. NO EQUIPMENT REFUELLING OR SERVICING SHOULD BE UNDERTAKEN WITHIN 30 m OF ANY WATERCOURSE OR
- SURFACE WATER DRAINAGE.
- 4. A SPILL CONTAINMENT KIT MUST BE READILY ACCESSIBLE ON SITE IN THE EVENT OF A RELEASE OF A DELETERIOUS SUBSTANCE TO THE ENVIRONMENT. ONSITE STAFF MUST BE TRAINED IN ITS USE.
- 5. THE CONTRACT ADMINISTRATOR MUST BE NOTIFIED IMMEDIATELY IN THE EVENT OF A SPILL OF DELETERIOUS SUBSTANCE. ANY SEDIMENT SPILL FROM THE SITE SHOULD BE REPORTED TO MINISTRY OF ENVIRONMENT (SPILL ACTION CENTER) AT 1-800-268-6060.

WORK AREA ISOLATION

- 1. ALL WORK IN ISOLATED WORK AREAS MUST BE COMPLETED IN THE DRY. AN ADEQUATE NUMBER OF PUMPS MUST BE USED FOR UNWATERING.
 2. CROSSING AN ACTIVE WATERCOURSE OR WETLAND BY EQUIPMENT, VEHICLES, PERSONNEL, ETC. IS NOT
- PERMITTED UNLESS APPROVED BY THE CONSERVATION AUTHORITY. ALL ACCESS TO WORK SITES SHALL BE FROM
- EITHER SIDES OF THE WATERCOURSE OR WETLAND.

 3. THE UNWATERING DISCHARGE LOCATION MUST BE LOCATED AT LEAST 30 M FROM ANY WATERCOURSE OR WETLAND IN AN AREA WITH DENSE VEGETATIVE GROUNDCOVER, AND WHERE THE DISCHARGE CAN RETURN TO THE WATERBODY DOWNSTREAM OF THE WORK AREA OVER THE GROUNDCOVER.
- 4. FISH MUST BE REMOVED FROM THE WORK AREA ONCE ISOLATED. FISH SALVAGE MUST BE COMPLETED BY A QUALIFIED TECHNICIAN WITH A LICENSE FROM THE ONTARIO MINISTRY OF NATURAL RESOURCES AND FORESTRY

	DATE BY		REVISIONS	
DESIGNED BY: LD/AS			CHECKED BY: PV	

DRAWN BY: AL/CP/SC DATE: JUNE 2024

INTERNAL DISCUSSION

CONSTRUCTION

DRAFT FOR

 $M O R P H I X^{\mathsf{m}}$ 36 Main St N., P.O. Box 205 NOT FOR

Campbellville, Ontario L0P 1B0 T: 416.920.0926


www.geomorphix.com


ALLOA SPA **TOWN OF CALEDON**

ETOBICOKE CREEK - ALLOA DRAIN CONCEPTUAL CHANNEL DESIGN CHANNEL PLANFORM

PROJECT No.: PN24009 DRAWING No.: GEO-22 SHEET 23 OF 35

PLANFORM 1:500

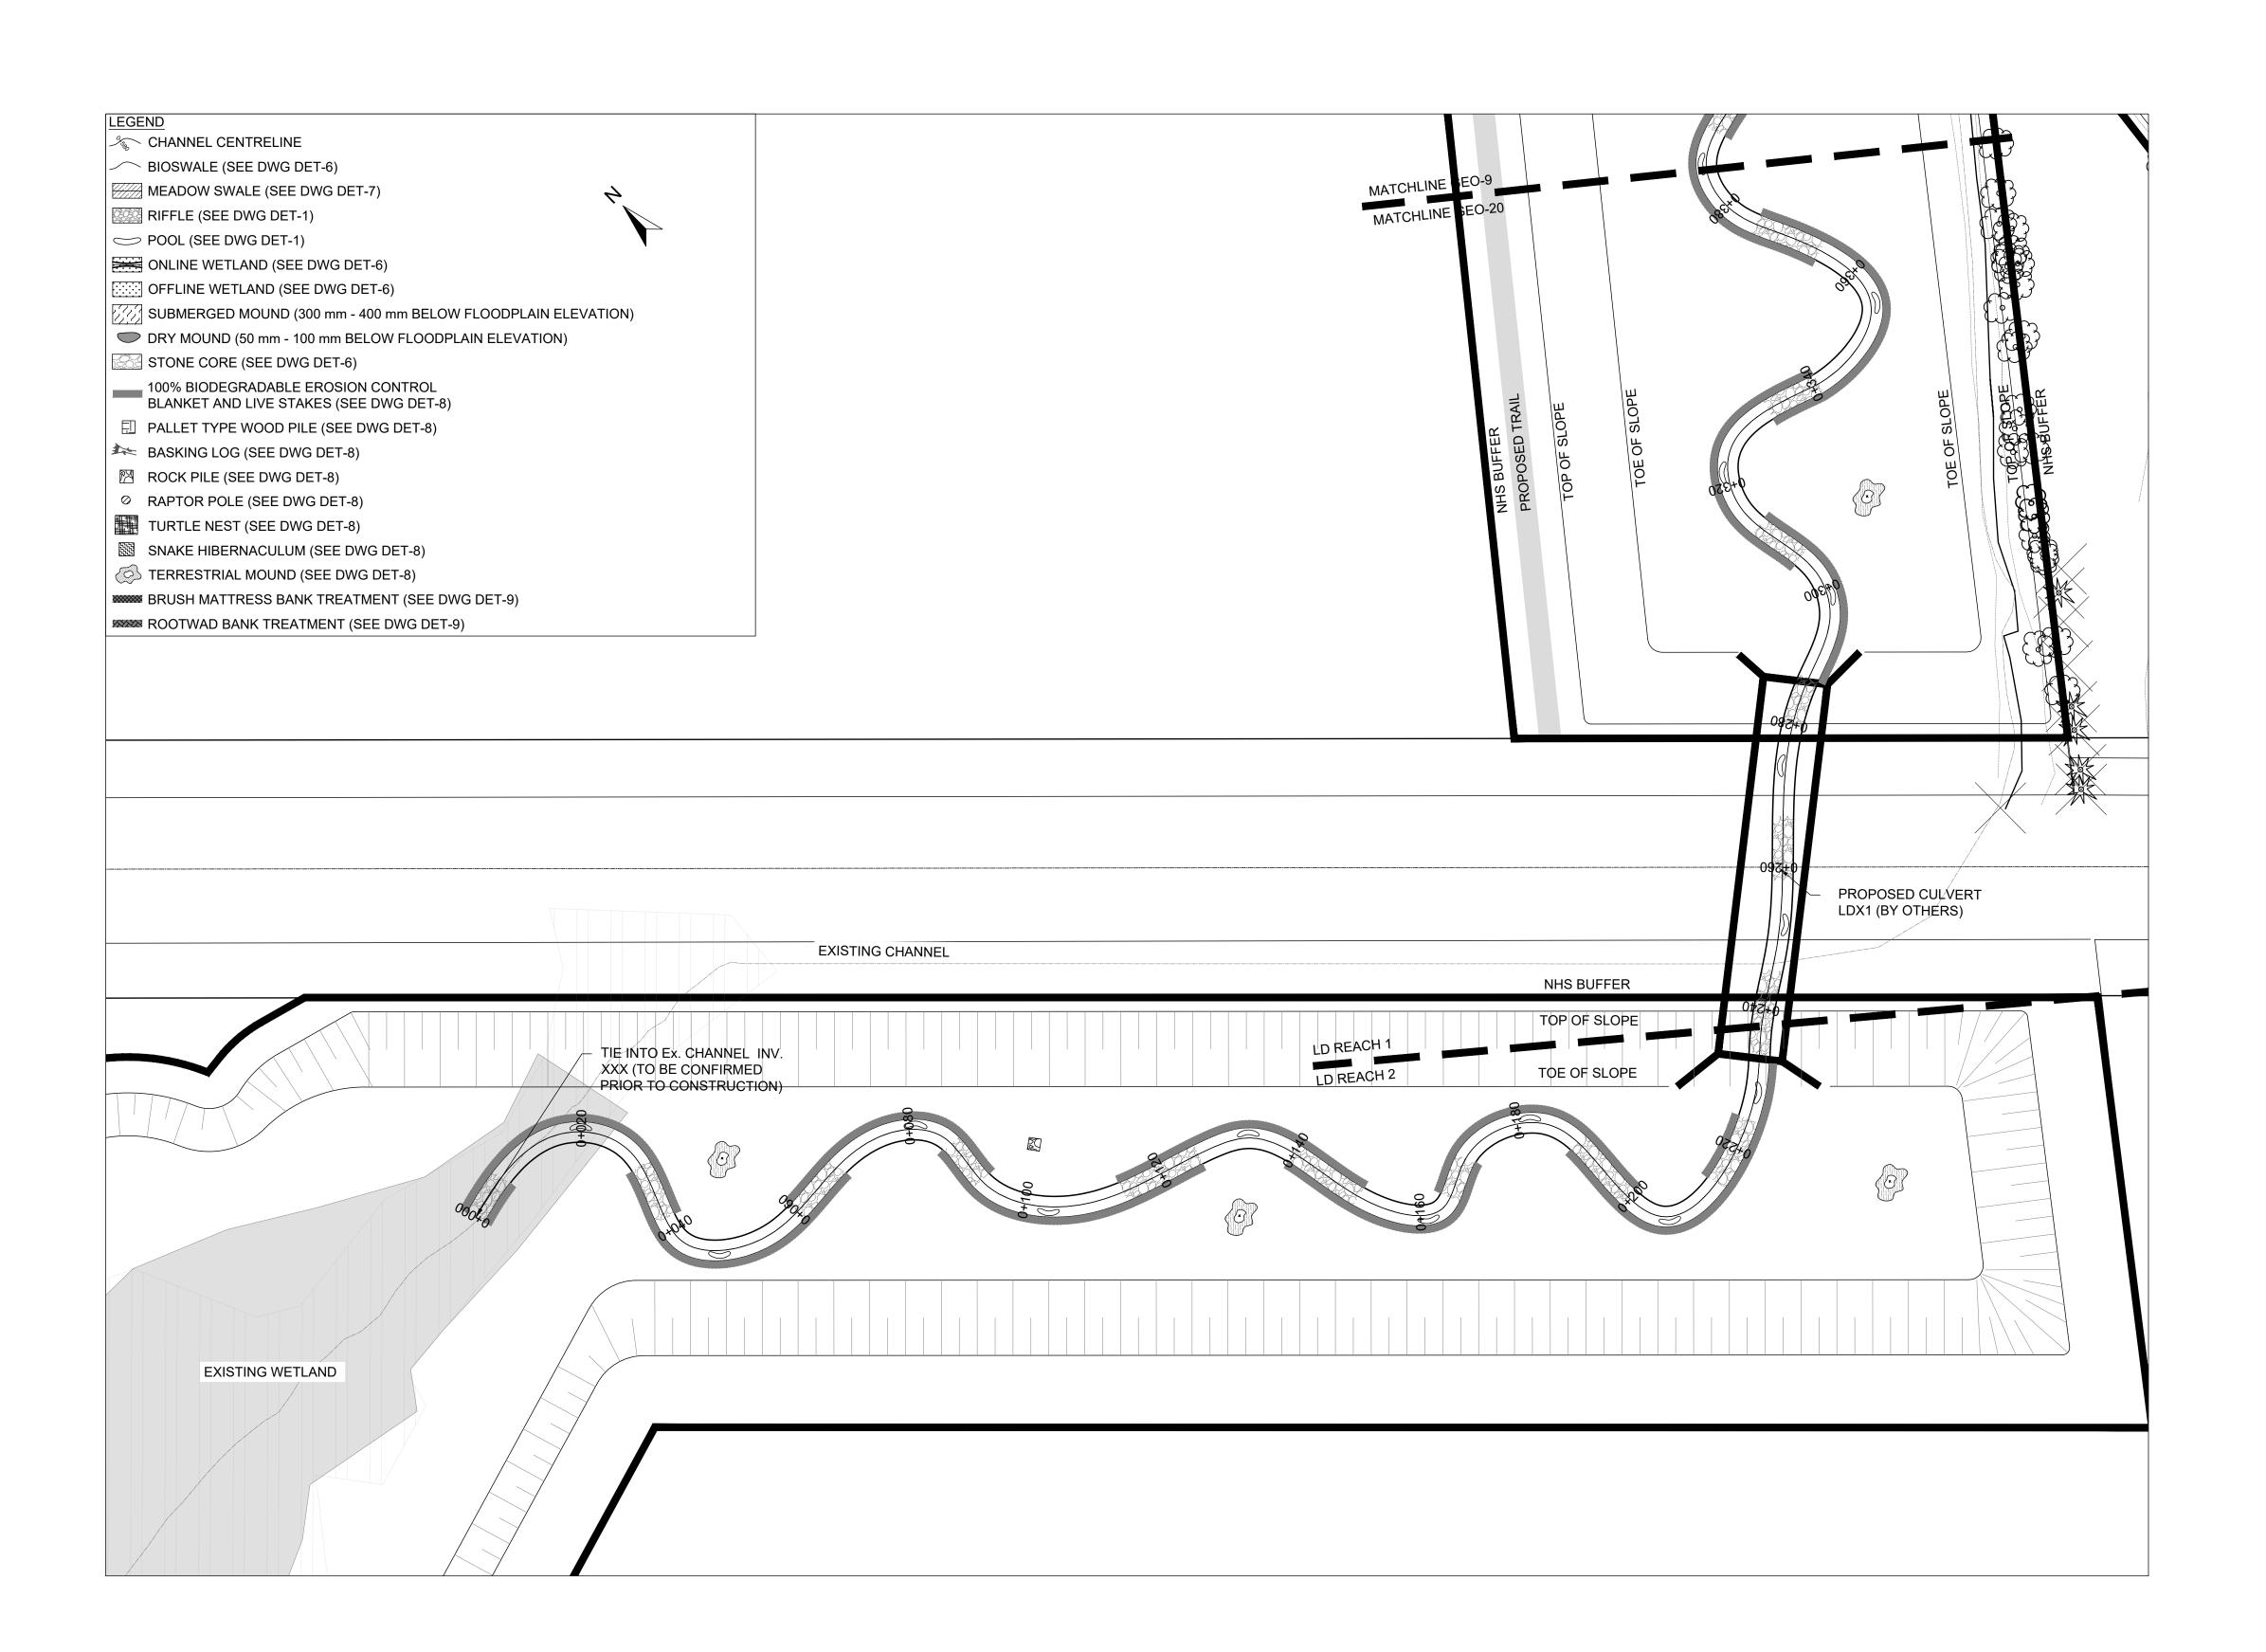

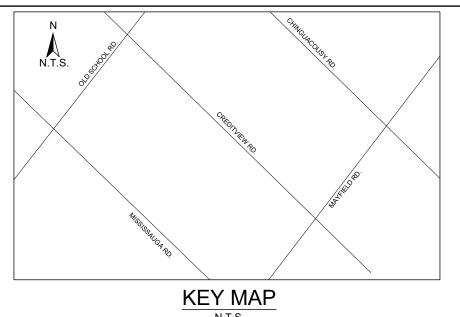

1. THE ACCOMPANYING CHANNEL REALIGNMENT TECHNICAL DESIGN BRIEF PREPARED BY GEO MORPHIX LTD. (2023) PROVIDES ADDITIONAL DESIGN DETAILS AND DIRECTION FOR IMPLEMENTATION AND IS TO BE REVIEWED IN

CONJUNCTION WITH THIS DRAWING SET. 2. ALL CONTRACT DRAWINGS, SPECIFICATIONS AND APPLICABLE PERMITS MUST BE KEPT ON SITE DURING

CONSTRUCTION FOR REFERENCE.

3. THE CONTRACTOR MUST NOTIFY THE DESIGNER AND CONTRACT ADMINISTRATOR OF THE INTENT TO COMMENCE WORK AT LEAST 48 HOURS IN ADVANCE.

 THE CONTRACTOR IS RESPONSIBLE FOR ALL UTILITY LOCATES.
 LAYOUT MUST BE REVIEWED AND APPROVED BY THE DESIGNER / DESIGNER REPRESENTATIVE, DESIGNATED ENGINEER, AND THE CONTRACT ADMINISTRATOR.

CONSTRUCTION OBSERVATION IS TO BE PERFORMED BY A CERTIFIED FLUVIAL GEOMORPHOLOGIST OR EXPERIENCED ENVIRONMENTAL INSPECTOR UNDER DIRECTION FROM THE DESIGNER.

7. ON-SITE SUPPORT FROM PROJECT ENGINEER (E.G., GEOTECHNICAL, HYDROGEOLOGICAL, AND/OR WATER

RESOURCES ENGINEER) REQUIRED TO ASSESS AND ENSURE FAVOURABLE SURFICIAL AND SUBSURFACE CONDITIONS TO SUPPORT CHANNEL REALIGNMENT CONSTRUCTION. 8. BE ADVISED THAT THE LOCAL REGULATORY BODY MAY, AT ANY TIME, WITHDRAW THIS PERMISSION, IF, IN THE OPINION OF THE AUTHORITY, THE CONDITIONS OF THE PERMIT ARE NOT BEING COMPLIED WITH. THIS APPROVAL DOES NOT EXEMPT THE PROPERTY OWNER/APPLICANT/AGENT FROM THE PROVISIONS OF ANY OTHER FEDERAL,

PROVINCIAL OR MUNICIPAL STATUTES, REGULATIONS OR BY-LAWS, OR ANY RIGHTS UNDER COMMON LAW.

TIMING OF WORKS

1. WORKS SHALL BE COMPLETED DURING THE DESIGNATED IN-WATER WORKS WINDOW SET OUT BY MNRF/DFO. TREE CLEARING IS TO BE COMPLETED OUTSIDE THE BIRD NESTING SEASON (APRIL 1ST TO AUGUST 1ST) TO COMPLY WITH THE FEDERAL MIGRATORY BIRDS CONVENTION ACT. ANY TREES THAT REQUIRE REMOVAL OUTSIDE OF THIS TIMING WINDOW MUST FIRST BE INSPECTED BY A QUALIFIED BIOLOGIST TO DETERMINE THE PRESENCE OF

3. THE WEATHER FORECAST SHOULD BE CONTINUALLY MONITORED TO ENSURE THAT WORKS ARE UNDERTAKEN

ONLY DURING FAVOURABLE WEATHER CONDITIONS. 4. COMPLETE THE WORKS WITH MINIMAL AVOIDABLE INTERRUPTIONS ONCE THEY COMMENCE.

SITE AND MATERIAL MANAGEMENT

1. ALL CONSTRUCTION EQUIPMENT AND MATERIALS (IMPORTED OR EXCAVATED) MUST BE STORED AT LEAST 30 m AWAY FROM ANY WATERBODY IN A STABLE AREA ABOVE THE ACTIVE FLOODPLAIN, OR IN A DESIGNATED

2. IN THE EVENT OF AN UNEXPECTED STORM, ALL UNFIXED ITEMS THAT HAVE THE POTENTIAL TO CAUSE A SPILL OR AN OBSTRUCTION TO FLOW MUST BE MOVED A STABLE AREA ABOVE ACTIVE FLOODPLAIN.

3. STOCKPILES MUST BE LOCATED OUTSIDE THE ISOLATED WORK AREAS. 4. STABILIZE, TEMPORARILY OR PERMANENTLY, ANY DISTURBED AREAS AS WORK PROGRESSES, OR SOON AS

CONDITIONS ALLOW. 5. MINIMIZE THE AREA OF DISTURBANCE TO THE EXTENT POSSIBLE. ALL DISTURBED GROUND LEFT INACTIVE FOR MORE THAN 30 DAYS SHALL BE STABILIZED USING APPROPRIATE EROSION CONTROL MEASURES AND AN

APPROPRIATE SEED MIX AS NOTED WITHIN THE FINAL APPROVED RESTORATION PLAN. 6. ALL VEGETATION, ADJACENT TO THE WORK AREA, MUST BE PROTECTED AND DELINEATED WITH CONSTRUCTION

FENCING OR TREE PROTECTION BARRIERS. 7. ALL GRADES IN THE AREA REGULATED BY THE CONSERVATION AUTHORITY MUST BE MAINTAINED OR MATCHED,

UNLESS OTHERWISE AUTHORIZED IN THE APPLICABLE PERMIT.

8. AN AFTER-HOURS CONTACT NUMBER IS TO BE VISIBLY POSTED ONSITE FOR EMERGENCIES. ALL THE PLANS SHOULD HAVE NAME AND CONTACT INFO OF THE PERSON RESPONSIBLE FOR ESC MEASURES.

EROSION AND SEDIMENT CONTROL

 ALL TEMPORARY EROSION AND SEDIMENT CONTROL MEASURES MUST BE INSTALLED PRIOR TO START OF WORKS.
 FOLLOWING INSTALLATION OF THE PROPOSED ESC MEASURES, A QUALIFIED AGENT OF THE PROPONENT (E.G. CAN-CISEC CERTIFIED MONITOR) WILL CONDUCT REGULAR SITÉ VISITS TO MONITOR ALL WORKS, PARTICULARLY THE CONDITION OF THE ESC MEASURES, DEWATERING, AND IN- OR NEAR-WATER WORKS. SHOULD CONCERNS ARISE; THE ENVIRONMENTAL MONITOR WILL CONTACT THE PROPONENT, THE CONSERVATION AUTHORITY, AND

ANY OTHER APPROPRIATE PARTIES. 3. EROSION AND SEDIMENT CONTROLS MUST BE MAINTAINED DURING CONSTRUCTION, AND ANY REQUIRED REPAIRS OR REPLACEMENTS MUST BE COMPLETED WITHIN 24 HOURS AFTER THEY HAVE BEEN IDENTIFIED DURING THE

4. EROSION AND SEDIMENT CONTROLS MAY REQUIRE PERIODIC ADJUSTMENTS TO REFLECT CHANGING SITE CONDITIONS. THE CONTRACTOR WILL BE RESPONSIBLE FOR THESE ADJUSTMENTS TO ENSURE PROPER

5. ANY CHANGES TO THE EROSION AND SEDIMENT CONTROL PLAN BEYOND MINOR ADJUSTMENTS MUST BE APPROVED BY THE CONTRACT ADMINISTRATOR.

6. ADDITIONAL EROSION AND SEDIMENT CONTROL SUPPLIES MUST BE KEPT ON SITE IN ORDER TO FACILITATE IMMEDIATE REPAIRS AND/OR UPGRADES AS NEEDED.
7. ALL TEMPORARY SEDIMENT CONTROLS MUST BE REMOVED AFTER THE CONTRACT ADMINISTRATOR DEEMS THE

8. THE PROJECT PROPONENT OR THEIR REPRESENTATIVE IS ULTIMATELY RESPONSIBLE FOR CONTROLLING SEDIMENT AND EROSION WITHIN THE CONSTRUCTION SITE FOR THE TOTAL PERIOD OF THE CONSTRUCTION.

9. IF EXCESSIVE SILTATION RESULTS FROM THE CONSTRUCTION ACTIVITIES, THE ONSITE SUPERVISOR/INSPECTOR AND/OR THE LOCAL REGULATORY BODY RESERVE THE RIGHT TO REQUEST ADDITIONAL ESC MEASURES WHICH WOULD BE INSTALLED PRIOR TO FURTHER CONSTRUCTION ACTIVITIES.

DELETERIOUS SUBSTANCE CONTROL/SPILL MANAGEMENT

 PREVENT THE RELEASE OF SEDIMENT, SEDIMENT-LADEN WATER, RAW CONCRETE, CONCRETE LEACHATE OR ANY OTHER DELETERIOUS SUBSTANCES INTO ANY WATERBODY, RAVINE OR STORM SEWER SYSTEM. 2. ENSURE EQUIPMENT AND MACHINERY ARE IN GOOD OPERATING CONDITION (POWER WASHED), FREE OF LEAKS, EXCESS OIL, AND GREASE.

3. NO EQUIPMENT REFUELLING OR SERVICING SHOULD BE UNDERTAKEN WITHIN 30 m OF ANY WATERCOURSE OR

SURFACE WATER DRAINAGE.

 A SPILL CONTAINMENT KIT MUST BE READILY ACCESSIBLE ON SITE IN THE EVENT OF A RELEASE OF A DELETERIOUS SUBSTANCE TO THE ENVIRONMENT. ONSITE STAFF MUST BE TRAINED IN ITS USE. 5. THE CONTRACT ADMINISTRATOR MUST BE NOTIFIED IMMEDIATELY IN THE EVENT OF A SPILL OF DELETERIOUS SUBSTANCE. ANY SEDIMENT SPILL FROM THE SITE SHOULD BE REPORTED TO MINISTRY OF ENVIRONMENT (SPILL ACTION CENTER) AT 1-800-268-6060.

WORK AREA ISOLATION

1. ALL WORK IN ISOLATED WORK AREAS MUST BE COMPLETED IN THE DRY. AN ADEQUATE NUMBER OF PUMPS MUST BE USED FOR UNWATERING.
2. CROSSING AN ACTIVE WATERCOURSE OR WETLAND BY EQUIPMENT, VEHICLES, PERSONNEL, ETC. IS NOT

PERMITTED UNLESS APPROVED BY THE CONSERVATION AUTHORITY. ALL ACCESS TO WORK SITES SHALL BE FROM

EITHER SIDES OF THE WATERCOURSE OR WETLAND.

3. THE UNWATERING DISCHARGE LOCATION MUST BE LOCATED AT LEAST 30 M FROM ANY WATERCOURSE OR WETLAND IN AN AREA WITH DENSE VEGETATIVE GROUNDCOVER, AND WHERE THE DISCHARGE CAN RETURN TO THE WATERBODY DOWNSTREAM OF THE WORK AREA OVER THE GROUNDCOVER.

4. FISH MUST BE REMOVED FROM THE WORK AREA ONCE ISOLATED. FISH SALVAGE MUST BE COMPLETED BY A QUALIFIED TECHNICIAN WITH A LICENSE FROM THE ONTARIO MINISTRY OF NATURAL RESOURCES AND FORESTRY

DATE BY **REVISIONS** CHECKED BY: PV DESIGNED BY: LD/AS DRAWN BY: AL/CP/SC DATE: JUNE 2024

DRAFT FOR INTERNAL DISCUSSION

NOT FOR CONSTRUCTION


 $M O R P H I X^{\mathsf{m}}$ 36 Main St N., P.O. Box 205


Campbellville, Ontario L0P 1B0 T: 416.920.0926 www.geomorphix.com

ALLOA SPA TOWN OF CALEDON

ETOBICOKE CREEK - ALLOA DRAIN CONCEPTUAL CHANNEL DESIGN CHANNEL PLANFORM

PROJECT No.: PN24009 DRAWING No.: GEO-23 SCALE: AS NOTED SHEET 24 OF 35

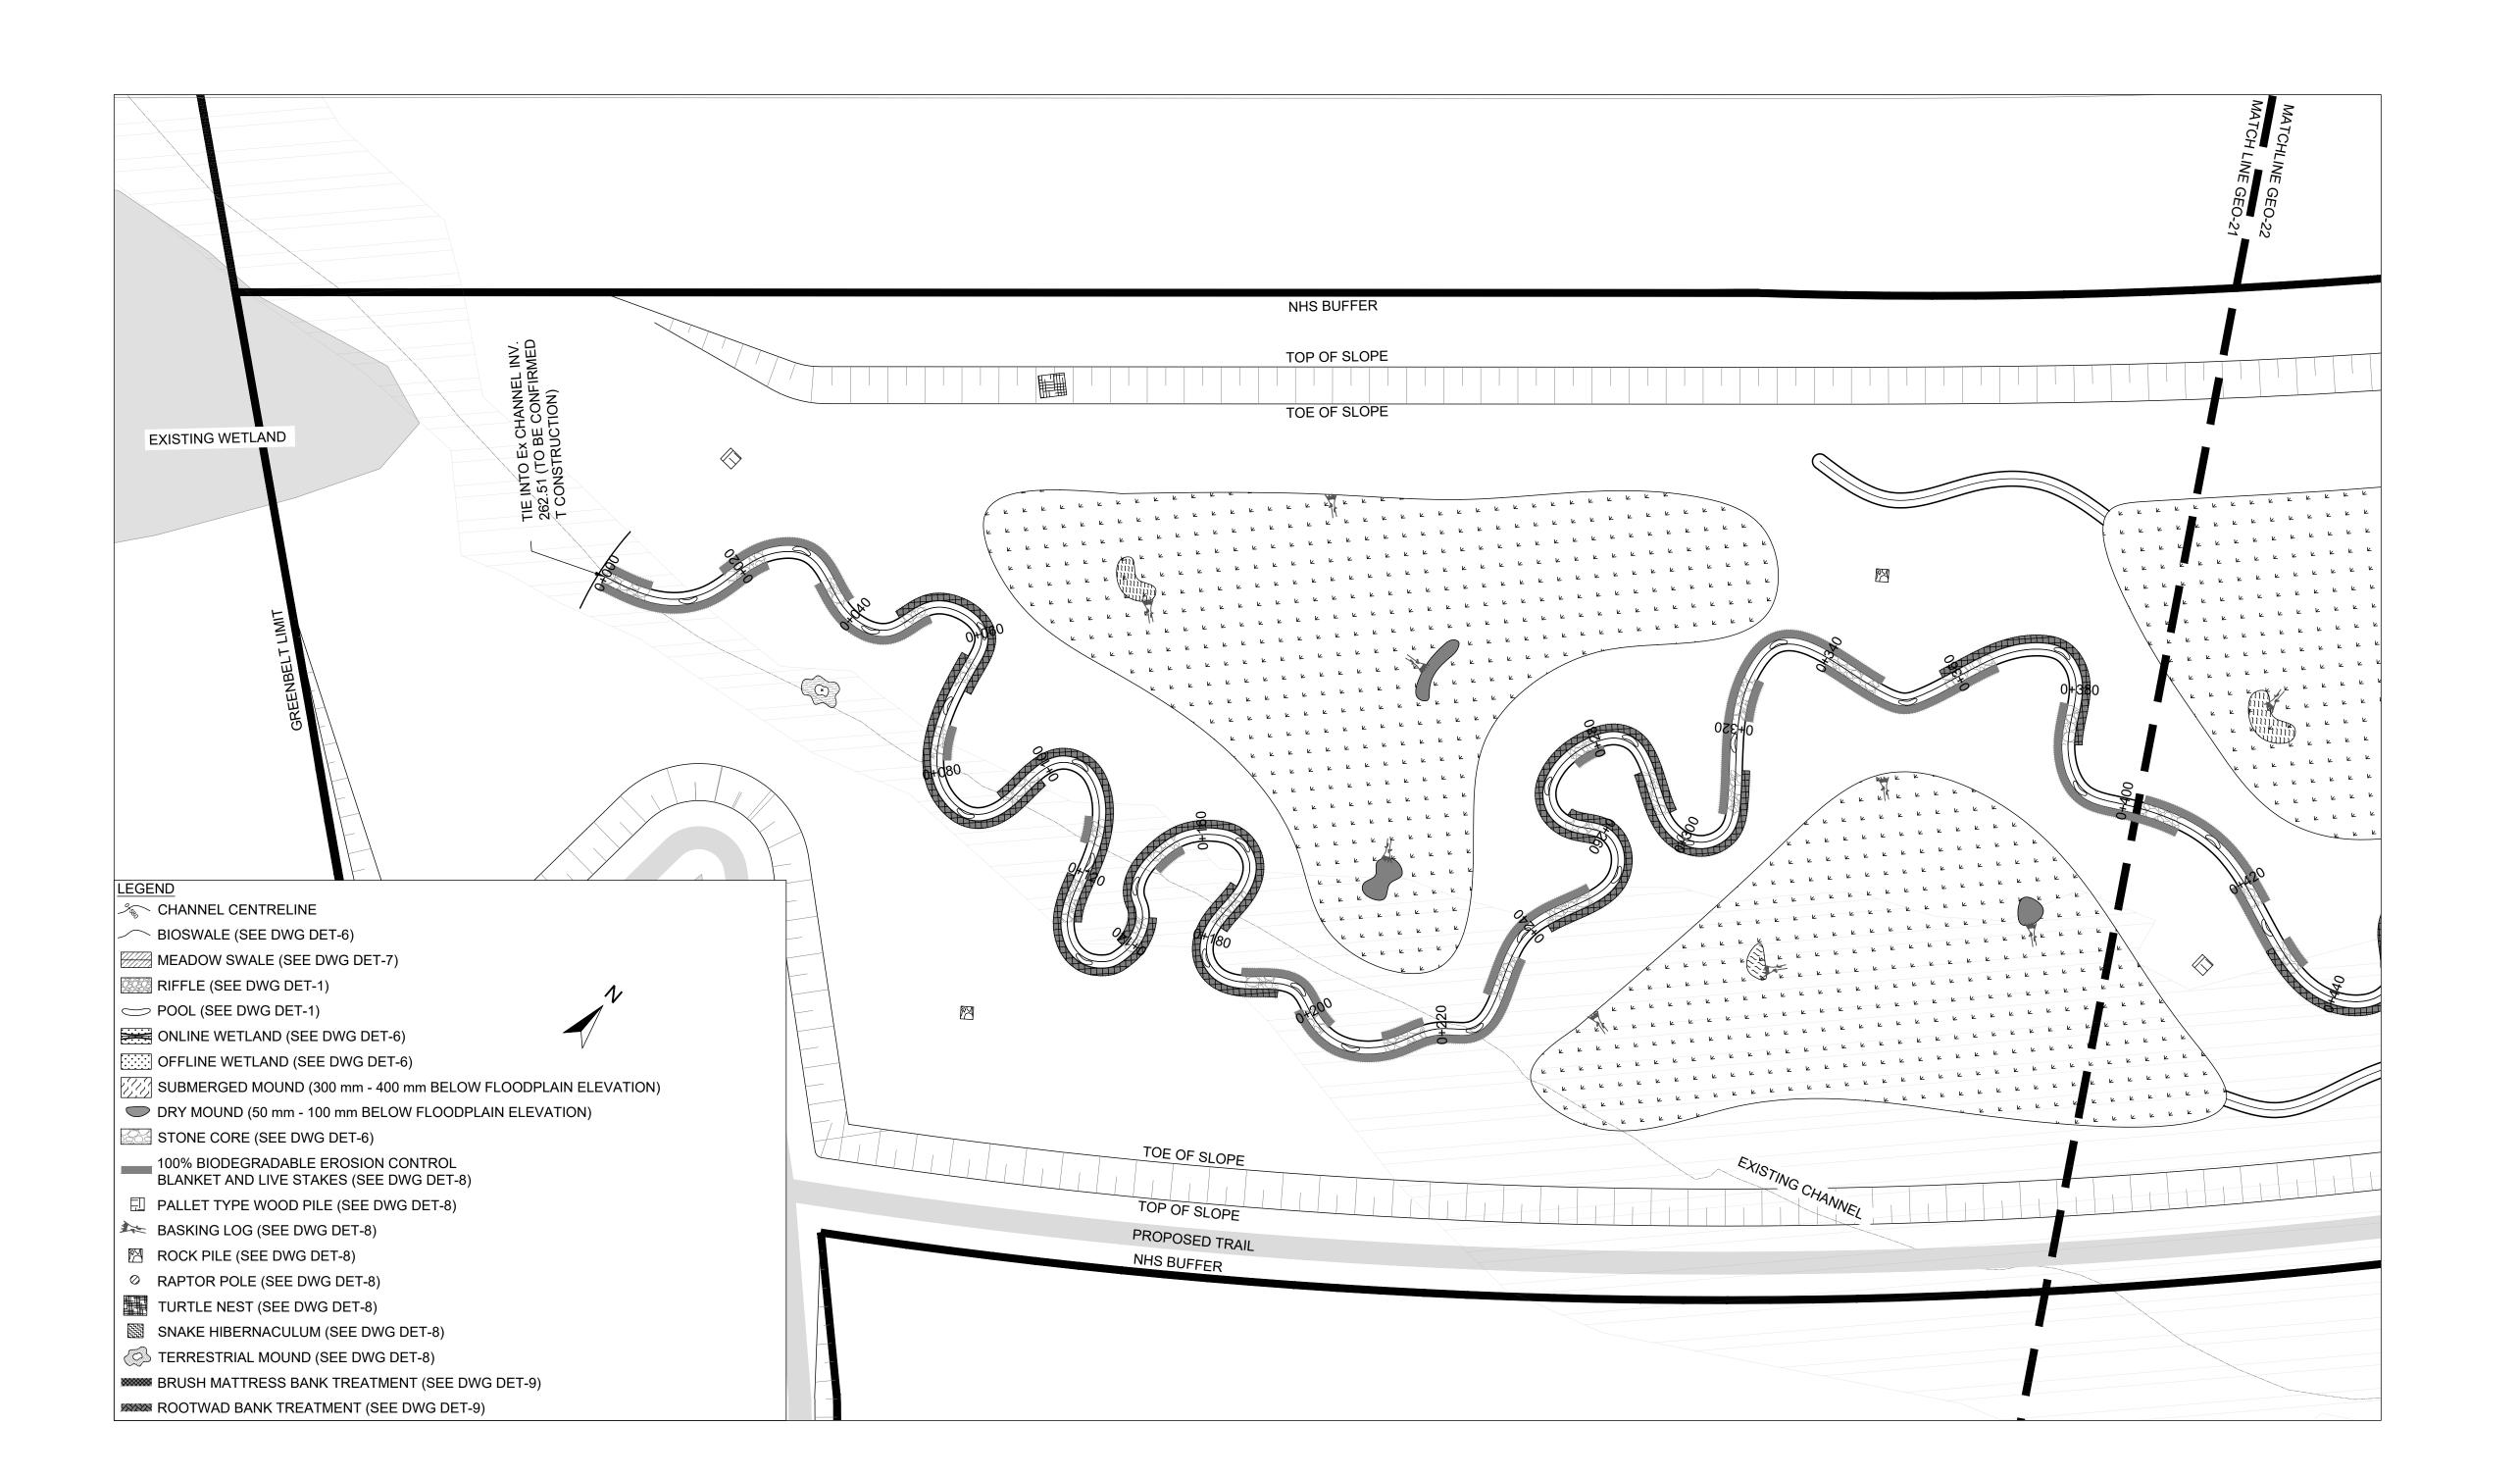

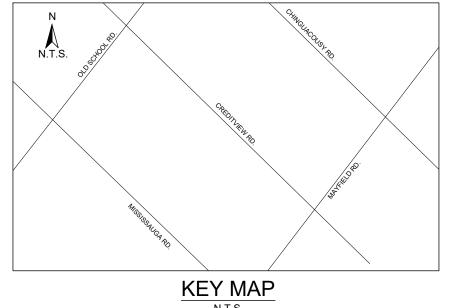

1. THE ACCOMPANYING CHANNEL REALIGNMENT TECHNICAL DESIGN BRIEF PREPARED BY GEO MORPHIX LTD. (2023) PROVIDES ADDITIONAL DESIGN DETAILS AND DIRECTION FOR IMPLEMENTATION AND IS TO BE REVIEWED IN

CONJUNCTION WITH THIS DRAWING SET. 2. ALL CONTRACT DRAWINGS, SPECIFICATIONS AND APPLICABLE PERMITS MUST BE KEPT ON SITE DURING CONSTRUCTION FOR REFERENCE.

3. THE CONTRACTOR MUST NOTIFY THE DESIGNER AND CONTRACT ADMINISTRATOR OF THE INTENT TO COMMENCE

WORK AT LEAST 48 HOURS IN ADVANCE.

4. THE CONTRACTOR IS RESPONSIBLE FOR ALL UTILITY LOCATES. 5. LAYOUT MUST BE REVIEWED AND APPROVED BY THE DESIGNER / DESIGNER REPRESENTATIVE, DESIGNATED ENGINEER, AND THE CONTRACT ADMINISTRATOR.

CONSTRUCTION OBSERVATION IS TO BE PERFORMED BY A CERTIFIED FLUVIAL GEOMORPHOLOGIST OR EXPERIENCED ENVIRONMENTAL INSPECTOR UNDER DIRECTION FROM THE DESIGNER.

7. ON-SITE SUPPORT FROM PROJECT ENGINEER (E.G., GEOTECHNICAL, HYDROGEOLOGICAL, AND/OR WATER

RESOURCES ENGINEER) REQUIRED TO ASSESS AND ENSURE FAVOURABLE SURFICIAL AND SUBSURFACE CONDITIONS TO SUPPORT CHANNEL REALIGNMENT CONSTRUCTION. 8. BE ADVISED THAT THE LOCAL REGULATORY BODY MAY, AT ANY TIME, WITHDRAW THIS PERMISSION, IF, IN THE

OPINION OF THE AUTHORITY. THE CONDITIONS OF THE PERMIT ARE NOT BEING COMPLIED WITH. THIS APPROVAL DOES NOT EXEMPT THE PROPERTY OWNER/APPLICANT/AGENT FROM THE PROVISIONS OF ANY OTHER FEDERAL, PROVINCIAL OR MUNICIPAL STATUTES, REGULATIONS OR BY-LAWS, OR ANY RIGHTS UNDER COMMON LAW.

TIMING OF WORKS

1. WORKS SHALL BE COMPLETED DURING THE DESIGNATED IN-WATER WORKS WINDOW SET OUT BY MNRF/DFO. 2. TREE CLEARING IS TO BE COMPLETED OUTSIDE THE BIRD NESTING SEASON (APRIL 1ST TO AUGUST 1ST) TO COMPLY WITH THE FEDERAL MIGRATORY BIRDS CONVENTION ACT. ANY TREES THAT REQUIRE REMOVAL OUTSIDE OF THIS TIMING WINDOW MUST FIRST BE INSPECTED BY A QUALIFIED BIOLOGIST TO DETERMINE THE PRESENCE OF

3. THE WEATHER FORECAST SHOULD BE CONTINUALLY MONITORED TO ENSURE THAT WORKS ARE UNDERTAKEN

ONLY DURING FAVOURABLE WEATHER CONDITIONS. 4. COMPLETE THE WORKS WITH MINIMAL AVOIDABLE INTERRUPTIONS ONCE THEY COMMENCE.

SITE AND MATERIAL MANAGEMENT

1. ALL CONSTRUCTION EQUIPMENT AND MATERIALS (IMPORTED OR EXCAVATED) MUST BE STORED AT LEAST 30 m AWAY FROM ANY WATERBODY IN A STABLE AREA ABOVE THE ACTIVE FLOODPLAIN, OR IN A DESIGNATED

2. IN THE EVENT OF AN UNEXPECTED STORM, ALL UNFIXED ITEMS THAT HAVE THE POTENTIAL TO CAUSE A SPILL OR AN OBSTRUCTION TO FLOW MUST BE MOVED A STABLE AREA ABOVE ACTIVE FLOODPLAIN.

3. STOCKPILES MUST BE LOCATED OUTSIDE THE ISOLATED WORK AREAS. 4. STABILIZE, TEMPORARILY OR PERMANENTLY, ANY DISTURBED AREAS AS WORK PROGRESSES, OR SOON AS CONDITIONS ALLOW.

5. MINIMIZE THE AREA OF DISTURBANCE TO THE EXTENT POSSIBLE. ALL DISTURBED GROUND LEFT INACTIVE FOR MORE THAN 30 DAYS SHALL BE STABILIZED USING APPROPRIATE EROSION CONTROL MEASURES AND AN APPROPRIATE SEED MIX AS NOTED WITHIN THE FINAL APPROVED RESTORATION PLAN.

6. ALL VEGETATION, ADJACENT TO THE WORK AREA, MUST BE PROTECTED AND DELINEATED WITH CONSTRUCTION FENCING OR TREE PROTECTION BARRIERS.

7. ALL GRADES IN THE AREA REGULATED BY THE CONSERVATION AUTHORITY MUST BE MAINTAINED OR MATCHED,

UNLESS OTHERWISE AUTHORIZED IN THE APPLICABLE PERMIT.

8. AN AFTER-HOURS CONTACT NUMBER IS TO BE VISIBLY POSTED ONSITE FOR EMERGENCIES. ALL THE PLANS SHOULD HAVE NAME AND CONTACT INFO OF THE PERSON RESPONSIBLE FOR ESC MEASURES.

EROSION AND SEDIMENT CONTROL

1. ALL TEMPORARY EROSION AND SEDIMENT CONTROL MEASURES MUST BE INSTALLED PRIOR TO START OF WORKS. 2. FOLLOWING INSTALLATION OF THE PROPOSED ESC MEASURES, A QUALIFIED AGENT OF THE PROPONENT (E.G. CAN-CISEC CERTIFIED MONITOR) WILL CONDUCT REGULAR SITÉ VISITS TO MONITOR ALL WORKS, PARTICULARLY THE CONDITION OF THE ESC MEASURES, DEWATERING, AND IN- OR NEAR-WATER WORKS. SHOULD CONCERNS ARISE; THE ENVIRONMENTAL MONITOR WILL CONTACT THE PROPONENT, THE CONSERVATION AUTHORITY, AND

3. EROSION AND SEDIMENT CONTROLS MUST BE MAINTAINED DURING CONSTRUCTION, AND ANY REQUIRED REPAIRS OR REPLACEMENTS MUST BE COMPLETED WITHIN 24 HOURS AFTER THEY HAVE BEEN IDENTIFIED DURING THE

4. EROSION AND SEDIMENT CONTROLS MAY REQUIRE PERIODIC ADJUSTMENTS TO REFLECT CHANGING SITE CONDITIONS. THE CONTRACTOR WILL BE RESPONSIBLE FOR THESE ADJUSTMENTS TO ENSURE PROPER

5. ANY CHANGES TO THE EROSION AND SEDIMENT CONTROL PLAN BEYOND MINOR ADJUSTMENTS MUST BE APPROVED BY THE CONTRACT ADMINISTRATOR. 6. ADDITIONAL EROSION AND SEDIMENT CONTROL SUPPLIES MUST BE KEPT ON SITE IN ORDER TO FACILITATE

IMMEDIATE REPAIRS AND/OR UPGRADES AS NEEDED. 7. ALL TEMPORARY SEDIMENT CONTROLS MUST BE REMOVED AFTER THE CONTRACT ADMINISTRATOR DEEMS THE

8. THE PROJECT PROPONENT OR THEIR REPRESENTATIVE IS ULTIMATELY RESPONSIBLE FOR CONTROLLING SEDIMENT AND EROSION WITHIN THE CONSTRUCTION SITE FOR THE TOTAL PERIOD OF THE CONSTRUCTION.

9. IF EXCESSIVE SILTATION RESULTS FROM THE CONSTRUCTION ACTIVITIES, THE ONSITE SUPERVISOR/INSPECTOR AND/OR THE LOCAL REGULATORY BODY RESERVE THE RIGHT TO REQUEST ADDITIONAL ESC MEASURES WHICH WOULD BE INSTALLED PRIOR TO FURTHER CONSTRUCTION ACTIVITIES.

DELETERIOUS SUBSTANCE CONTROL/SPILL MANAGEMENT

 PREVENT THE RELEASE OF SEDIMENT, SEDIMENT-LADEN WATER, RAW CONCRETE, CONCRETE LEACHATE OR ANY OTHER DELETERIOUS SUBSTANCES INTO ANY WATERBODY, RAVINE OR STORM SEWER SYSTEM. 2. ENSURE EQUIPMENT AND MACHINERY ARE IN GOOD OPERATING CONDITION (POWER WASHED), FREE OF LEAKS, EXCESS OIL, AND GREASE.

3. NO EQUIPMENT REFUELLING OR SERVICING SHOULD BE UNDERTAKEN WITHIN 30 m OF ANY WATERCOURSE OR

SURFACE WATER DRAINAGE. 4. A SPILL CONTAINMENT KIT MUST BE READILY ACCESSIBLE ON SITE IN THE EVENT OF A RELEASE OF A DELETERIOUS SUBSTANCE TO THE ENVIRONMENT. ONSITE STAFF MUST BE TRAINED IN ITS USE.

5. THE CONTRACT ADMINISTRATOR MUST BE NOTIFIED IMMEDIATELY IN THE EVENT OF A SPILL OF DELETERIOUS SUBSTANCE. ANY SEDIMENT SPILL FROM THE SITE SHOULD BE REPORTED TO MINISTRY OF ENVIRONMENT (SPILL ACTION CENTER) AT 1-800-268-6060.

WORK AREA ISOLATION

1. ALL WORK IN ISOLATED WORK AREAS MUST BE COMPLETED IN THE DRY. AN ADEQUATE NUMBER OF PUMPS MUST BE USED FOR UNWATERING.
2. CROSSING AN ACTIVE WATERCOURSE OR WETLAND BY EQUIPMENT, VEHICLES, PERSONNEL, ETC. IS NOT

PERMITTED UNLESS APPROVED BY THE CONSERVATION AUTHORITY. ALL ACCESS TO WORK SITES SHALL BE FROM

EITHER SIDES OF THE WATERCOURSE OR WETLAND. 3. THE UNWATERING DISCHARGE LOCATION MUST BE LOCATED AT LEAST 30 M FROM ANY WATERCOURSE OR WETLAND IN AN AREA WITH DENSE VEGETATIVE GROUNDCOVER, AND WHERE THE DISCHARGE CAN RETURN TO

THE WATERBODY DOWNSTREAM OF THE WORK AREA OVER THE GROUNDCOVER. 4. FISH MUST BE REMOVED FROM THE WORK AREA ONCE ISOLATED. FISH SALVAGE MUST BE COMPLETED BY A

DATE BY **REVISIONS** CHECKED BY: PV DESIGNED BY: LD/AS

DRAWN BY: AL/CP/SC DATE: JUNE 2024

DRAFT FOR INTERNAL DISCUSSION

NOT FOR


 $M O R P H I X^{\mathsf{m}}$ 36 Main St N., P.O. Box 205 Campbellville, Ontario L0P 1B0 CONSTRUCTION


T: 416.920.0926 www.geomorphix.com

ALLOA SPA **TOWN OF CALEDON**

ETOBICOKE CREEK - ALLOA DRAIN CONCEPTUAL CHANNEL DESIGN CHANNEL PLANFORM

PROJECT No.: PN24009 DRAWING No.: GEO-24 SCALE: AS NOTED SHEET 25 OF 35

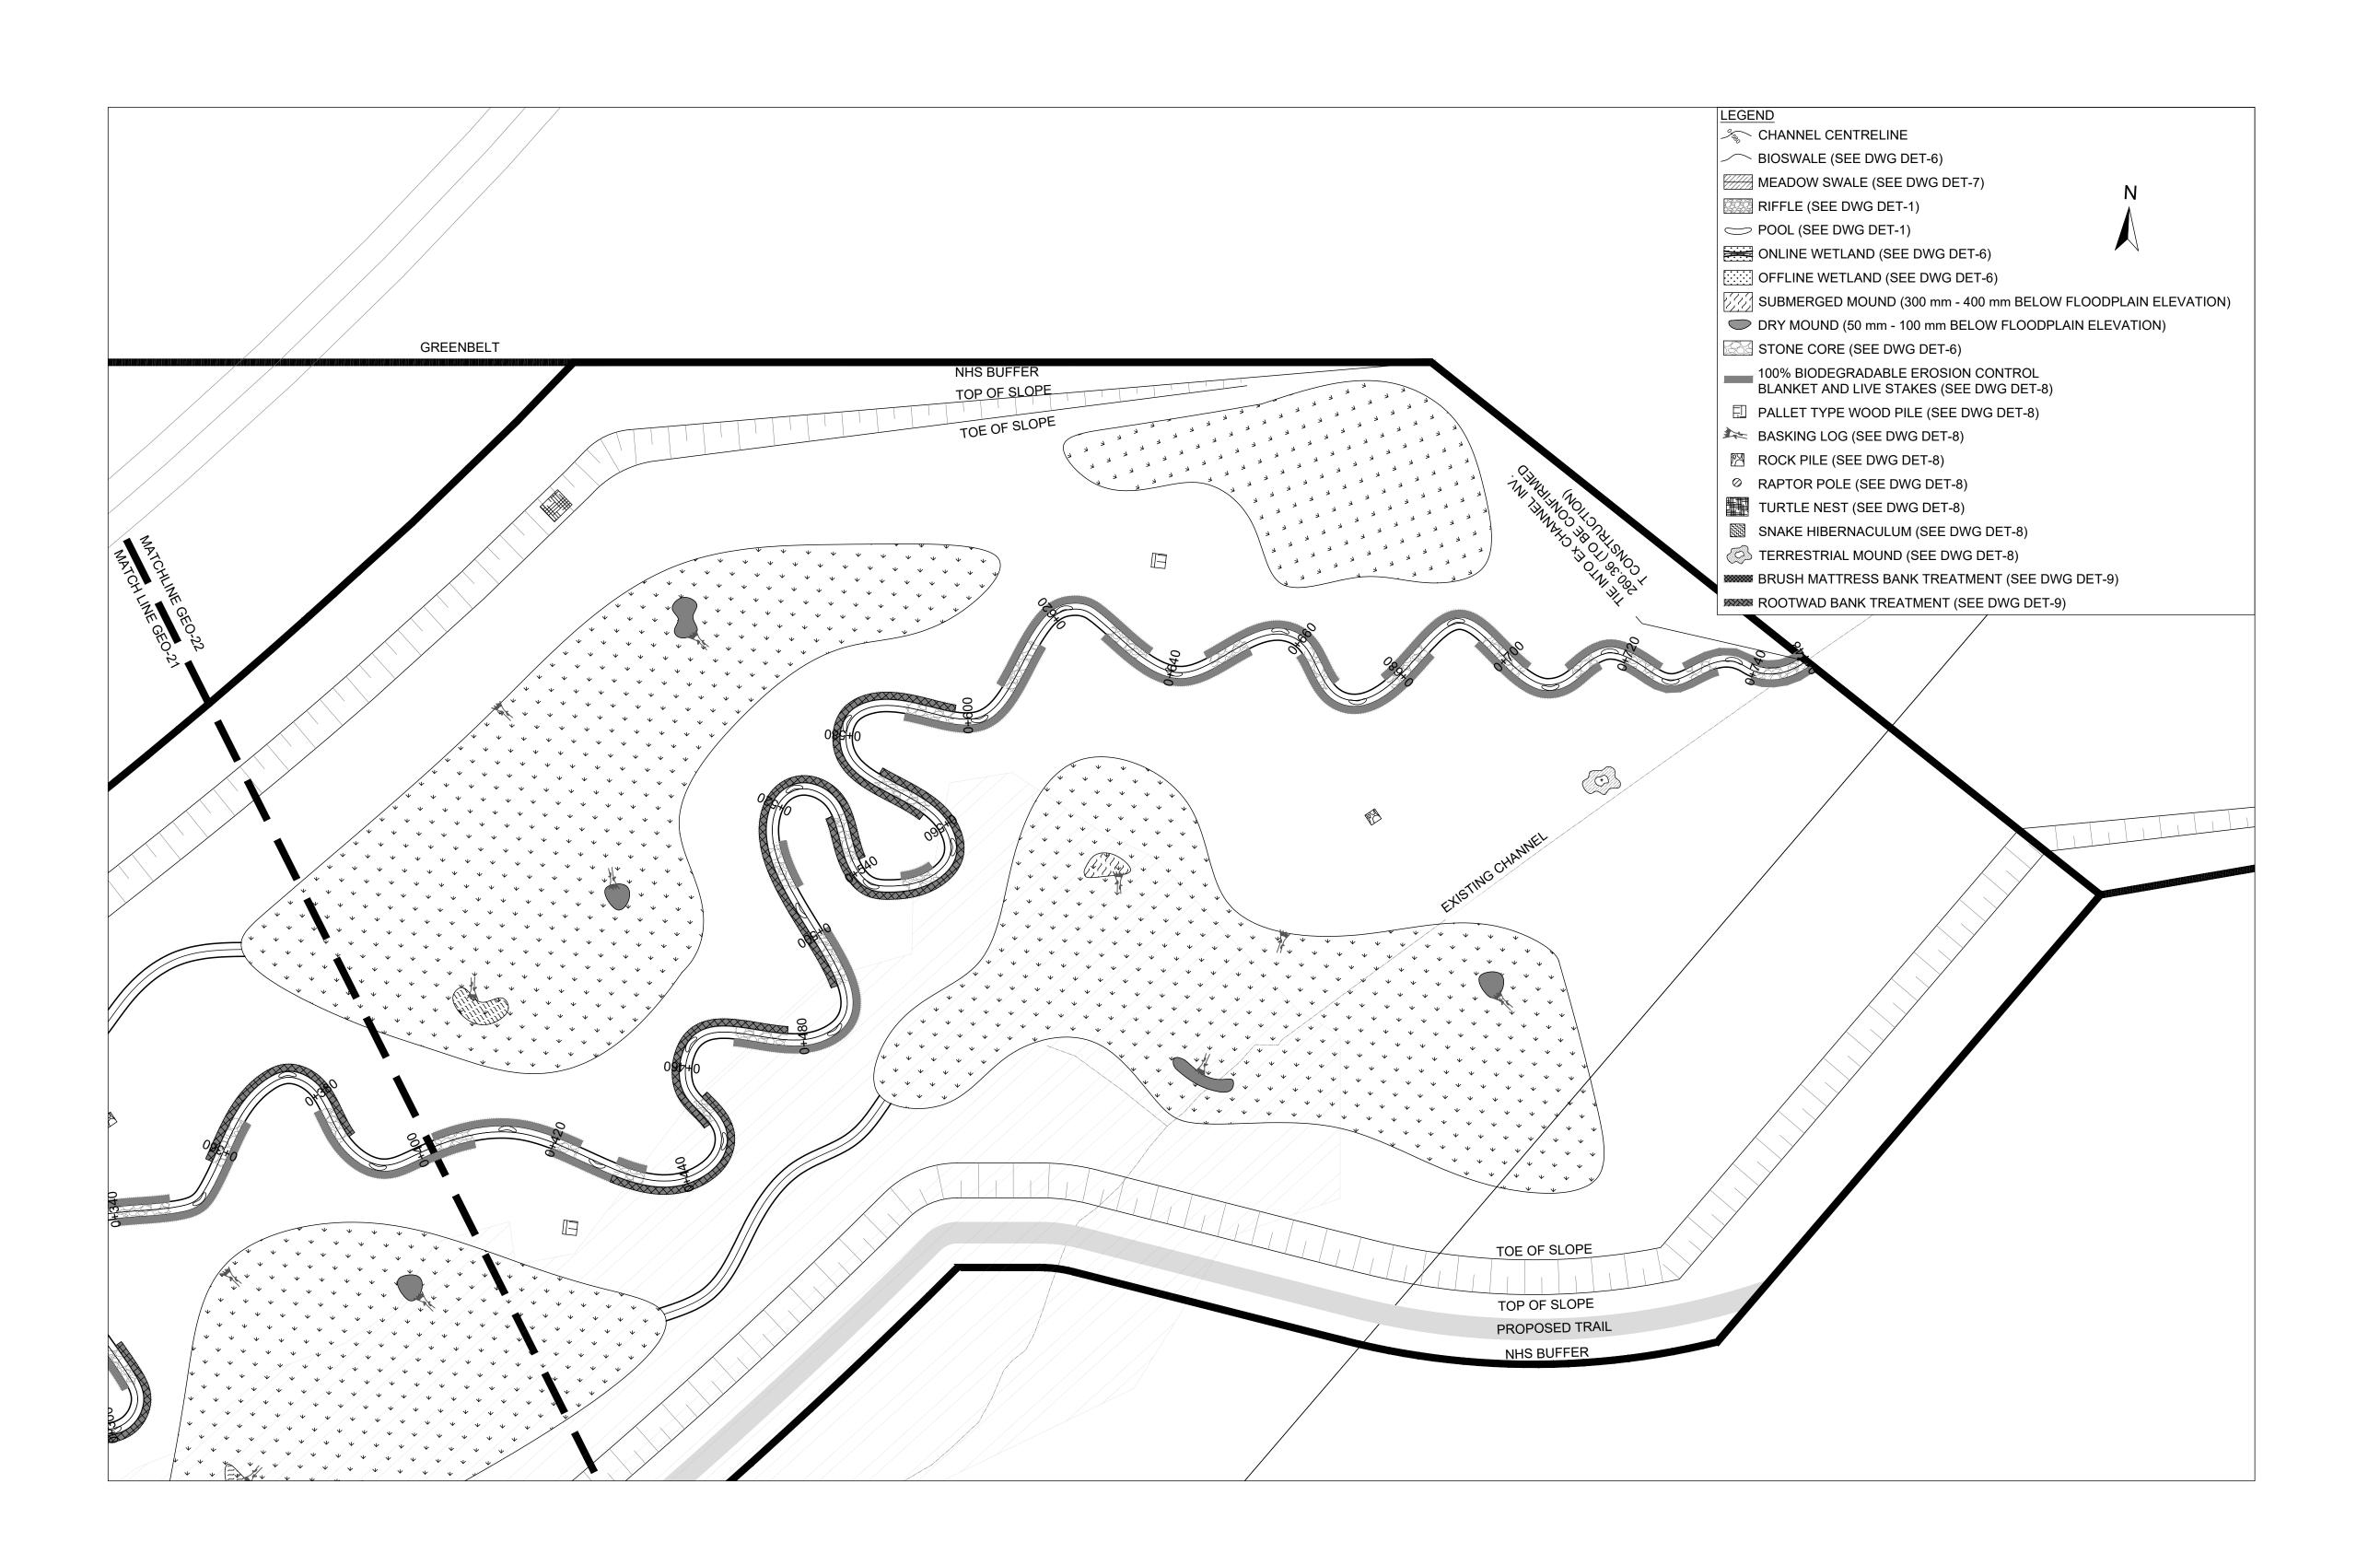

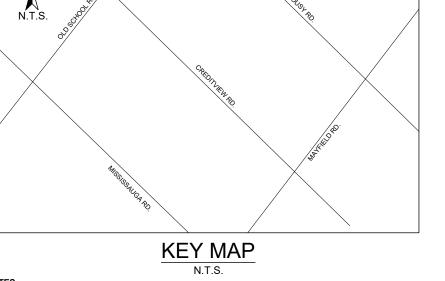

1. THE ACCOMPANYING CHANNEL REALIGNMENT TECHNICAL DESIGN BRIEF PREPARED BY GEO MORPHIX LTD. (2023) PROVIDES ADDITIONAL DESIGN DETAILS AND DIRECTION FOR IMPLEMENTATION AND IS TO BE REVIEWED IN

CONJUNCTION WITH THIS DRAWING SET. 2. ALL CONTRACT DRAWINGS, SPECIFICATIONS AND APPLICABLE PERMITS MUST BE KEPT ON SITE DURING

CONSTRUCTION FOR REFERENCE.

3. THE CONTRACTOR MUST NOTIFY THE DESIGNER AND CONTRACT ADMINISTRATOR OF THE INTENT TO COMMENCE WORK AT LEAST 48 HOURS IN ADVANCE.

THE CONTRACTOR IS RESPONSIBLE FOR ALL UTILITY LOCATES.
 LAYOUT MUST BE REVIEWED AND APPROVED BY THE DESIGNER / DESIGNER REPRESENTATIVE, DESIGNATED

ENGINEER, AND THE CONTRACT ADMINISTRATOR.

 CONSTRUCTION OBSERVATION IS TO BE PERFORMED BY A CERTIFIED FLUVIAL GEOMORPHOLOGIST OR EXPERIENCED ENVIRONMENTAL INSPECTOR UNDER DIRECTION FROM THE DESIGNER. 7. ON-SITE SUPPORT FROM PROJECT ENGINEER (E.G., GEOTECHNICAL, HYDROGEOLOGICAL, AND/OR WATER

RESOURCES ENGINEER) REQUIRED TO ASSESS AND ENSURE FAVOURABLE SURFICIAL AND SUBSURFACE CONDITIONS TO SUPPORT CHANNEL REALIGNMENT CONSTRUCTION. 8. BE ADVISED THAT THE LOCAL REGULATORY BODY MAY, AT ANY TIME, WITHDRAW THIS PERMISSION, IF, IN THE

OPINION OF THE AUTHORITY, THE CONDITIONS OF THE PERMIT ARE NOT BEING COMPLIED WITH. THIS APPROVAL DOES NOT EXEMPT THE PROPERTY OWNER/APPLICANT/AGENT FROM THE PROVISIONS OF ANY OTHER FEDERAL, PROVINCIAL OR MUNICIPAL STATUTES, REGULATIONS OR BY-LAWS, OR ANY RIGHTS UNDER COMMON LAW.

TIMING OF WORKS

1 WORKS SHALL BE COMPLETED DURING THE DESIGNATED IN-WATER WORKS WINDOW SET OUT BY MNRE/DEO TREE CLEARING IS TO BE COMPLETED OUTSIDE THE BIRD NESTING SEASON (APRIL 1ST TO AUGUST 1ST) TO COMPLY WITH THE FEDERAL MIGRATORY BIRDS CONVENTION ACT. ANY TREES THAT REQUIRE REMOVAL OUTSIDE OF THIS TIMING WINDOW MUST FIRST BE INSPECTED BY A QUALIFIED BIOLOGIST TO DETERMINE THE PRESENCE OF

3. THE WEATHER FORECAST SHOULD BE CONTINUALLY MONITORED TO ENSURE THAT WORKS ARE UNDERTAKEN

ONLY DURING FAVOURABLE WEATHER CONDITIONS. 4. COMPLETE THE WORKS WITH MINIMAL AVOIDABLE INTERRUPTIONS ONCE THEY COMMENCE.

SITE AND MATERIAL MANAGEMENT

1. ALL CONSTRUCTION EQUIPMENT AND MATERIALS (IMPORTED OR EXCAVATED) MUST BE STORED AT LEAST 30 m

AWAY FROM ANY WATERBODY IN A STABLE AREA ABOVE THE ACTIVE FLOODPLAIN, OR IN A DESIGNATED 2. IN THE EVENT OF AN UNEXPECTED STORM, ALL UNFIXED ITEMS THAT HAVE THE POTENTIAL TO CAUSE A SPILL OR AN OBSTRUCTION TO FLOW MUST BE MOVED A STABLE AREA ABOVE ACTIVE FLOODPLAIN.

3. STOCKPILES MUST BE LOCATED OUTSIDE THE ISOLATED WORK AREAS.

4. STABILIZE, TEMPORARILY OR PERMANENTLY, ANY DISTURBED AREAS AS WORK PROGRESSES, OR SOON AS CONDITIONS ALLOW. 5. MINIMIZE THE AREA OF DISTURBANCE TO THE EXTENT POSSIBLE. ALL DISTURBED GROUND LEFT INACTIVE FOR

MORE THAN 30 DAYS SHALL BE STABILIZED USING APPROPRIATE EROSION CONTROL MEASURES AND AN APPROPRIATE SEED MIX AS NOTED WITHIN THE FINAL APPROVED RESTORATION PLAN.

6. ALL VEGETATION, ADJACENT TO THE WORK AREA, MUST BE PROTECTED AND DELINEATED WITH CONSTRUCTION FENCING OR TREE PROTECTION BARRIERS.

7. ALL GRADES IN THE AREA REGULATED BY THE CONSERVATION AUTHORITY MUST BE MAINTAINED OR MATCHED,

UNLESS OTHERWISE AUTHORIZED IN THE APPLICABLE PERMIT.

8. AN AFTER-HOURS CONTACT NUMBER IS TO BE VISIBLY POSTED ONSITE FOR EMERGENCIES. ALL THE PLANS SHOULD HAVE NAME AND CONTACT INFO OF THE PERSON RESPONSIBLE FOR ESC MEASURES.

EROSION AND SEDIMENT CONTROL

1. ALL TEMPORARY EROSION AND SEDIMENT CONTROL MEASURES MUST BE INSTALLED PRIOR TO START OF WORKS. 2. FOLLOWING INSTALLATION OF THE PROPOSED ESC MEASURES, A QUALIFIED AGENT OF THE PROPONENT (E.G. CAN-CISEC CERTIFIED MONITOR) WILL CONDUCT REGULAR SITÉ VISITS TO MONITOR ALL WORKS, PARTICULARLY THE CONDITION OF THE ESC MEASURES, DEWATERING, AND IN- OR NEAR-WATER WORKS. SHOULD CONCERNS ARISE; THE ENVIRONMENTAL MONITOR WILL CONTACT THE PROPONENT, THE CONSERVATION AUTHORITY, AND ANY OTHER APPROPRIATE PARTIES.

3. EROSION AND SEDIMENT CONTROLS MUST BE MAINTAINED DURING CONSTRUCTION, AND ANY REQUIRED REPAIRS OR REPLACEMENTS MUST BE COMPLETED WITHIN 24 HOURS AFTER THEY HAVE BEEN IDENTIFIED DURING THE

4. EROSION AND SEDIMENT CONTROLS MAY REQUIRE PERIODIC ADJUSTMENTS TO REFLECT CHANGING SITE CONDITIONS. THE CONTRACTOR WILL BE RESPONSIBLE FOR THESE ADJUSTMENTS TO ENSURE PROPER

5. ANY CHANGES TO THE EROSION AND SEDIMENT CONTROL PLAN BEYOND MINOR ADJUSTMENTS MUST BE APPROVED BY THE CONTRACT ADMINISTRATOR. 6. ADDITIONAL EROSION AND SEDIMENT CONTROL SUPPLIES MUST BE KEPT ON SITE IN ORDER TO FACILITATE

IMMEDIATE REPAIRS AND/OR UPGRADES AS NEEDED.
7. ALL TEMPORARY SEDIMENT CONTROLS MUST BE REMOVED AFTER THE CONTRACT ADMINISTRATOR DEEMS THE

8. THE PROJECT PROPONENT OR THEIR REPRESENTATIVE IS ULTIMATELY RESPONSIBLE FOR CONTROLLING SEDIMENT AND EROSION WITHIN THE CONSTRUCTION SITE FOR THE TOTAL PERIOD OF THE CONSTRUCTION.

9. IF EXCESSIVE SILTATION RESULTS FROM THE CONSTRUCTION ACTIVITIES, THE ONSITE SUPERVISOR/INSPECTOR AND/OR THE LOCAL REGULATORY BODY RESERVE THE RIGHT TO REQUEST ADDITIONAL ESC MEASURES WHICH WOULD BE INSTALLED PRIOR TO FURTHER CONSTRUCTION ACTIVITIES.

DELETERIOUS SUBSTANCE CONTROL/SPILL MANAGEMENT

 PREVENT THE RELEASE OF SEDIMENT, SEDIMENT-LADEN WATER, RAW CONCRETE, CONCRETE LEACHATE OR ANY OTHER DELETERIOUS SUBSTANCES INTO ANY WATERBODY, RAVINE OR STORM SEWER SYSTEM. 2. ENSURE EQUIPMENT AND MACHINERY ARE IN GOOD OPERATING CONDITION (POWER WASHED), FREE OF LEAKS, EXCESS OIL, AND GREASE.

3. NO EQUIPMENT REFUELLING OR SERVICING SHOULD BE UNDERTAKEN WITHIN 30 m OF ANY WATERCOURSE OR

SURFACE WATER DRAINAGE. 4. A SPILL CONTAINMENT KIT MUST BE READILY ACCESSIBLE ON SITE IN THE EVENT OF A RELEASE OF A DELETERIOUS SUBSTANCE TO THE ENVIRONMENT. ONSITE STAFF MUST BE TRAINED IN ITS USE.

5. THE CONTRACT ADMINISTRATOR MUST BE NOTIFIED IMMEDIATELY IN THE EVENT OF A SPILL OF DELETERIOUS SUBSTANCE. ANY SEDIMENT SPILL FROM THE SITE SHOULD BE REPORTED TO MINISTRY OF ENVIRONMENT (SPILL ACTION CENTER) AT 1-800-268-6060.

WORK AREA ISOLATION 1. ALL WORK IN ISOLATED WORK AREAS MUST BE COMPLETED IN THE DRY. AN ADEQUATE NUMBER OF PUMPS MUST

BE USED FOR UNWATERING.
2. CROSSING AN ACTIVE WATERCOURSE OR WETLAND BY EQUIPMENT, VEHICLES, PERSONNEL, ETC. IS NOT

PERMITTED UNLESS APPROVED BY THE CONSERVATION AUTHORITY. ALL ACCESS TO WORK SITES SHALL BE FROM EITHER SIDES OF THE WATERCOURSE OR WETLAND. 3. THE UNWATERING DISCHARGE LOCATION MUST BE LOCATED AT LEAST 30 M FROM ANY WATERCOURSE OR

WETLAND IN AN AREA WITH DENSE VEGETATIVE GROUNDCOVER, AND WHERE THE DISCHARGE CAN RETURN TO THE WATERBODY DOWNSTREAM OF THE WORK AREA OVER THE GROUNDCOVER. 4. FISH MUST BE REMOVED FROM THE WORK AREA ONCE ISOLATED. FISH SALVAGE MUST BE COMPLETED BY A

QUALIFIED TECHNICIAN WITH A LICENSE FROM THE ONTARIO MINISTRY OF NATURAL RESOURCES AND FORESTRY

DATE BY **REVISIONS**

CHECKED BY: PV DESIGNED BY: LD/AS

DRAFT FOR **INTERNAL**

DRAWN BY: AL/CP/SC

DISCUSSION M O R P H I X TM

NOT FOR CONSTRUCTION


36 Main St N., P.O. Box 205 Campbellville, Ontario L0P 1B0 T: 416.920.0926 www.geomorphix.com


DATE: JUNE 2024


ALLOA SPA **TOWN OF CALEDON**

ETOBICOKE CREEK - ALLOA DRAIN CONCEPTUAL CHANNEL DESIGN CHANNEL PLANFORM


PROJECT No.: PN24009 DRAWING No.: GEO-25 SHEET 26 OF 35

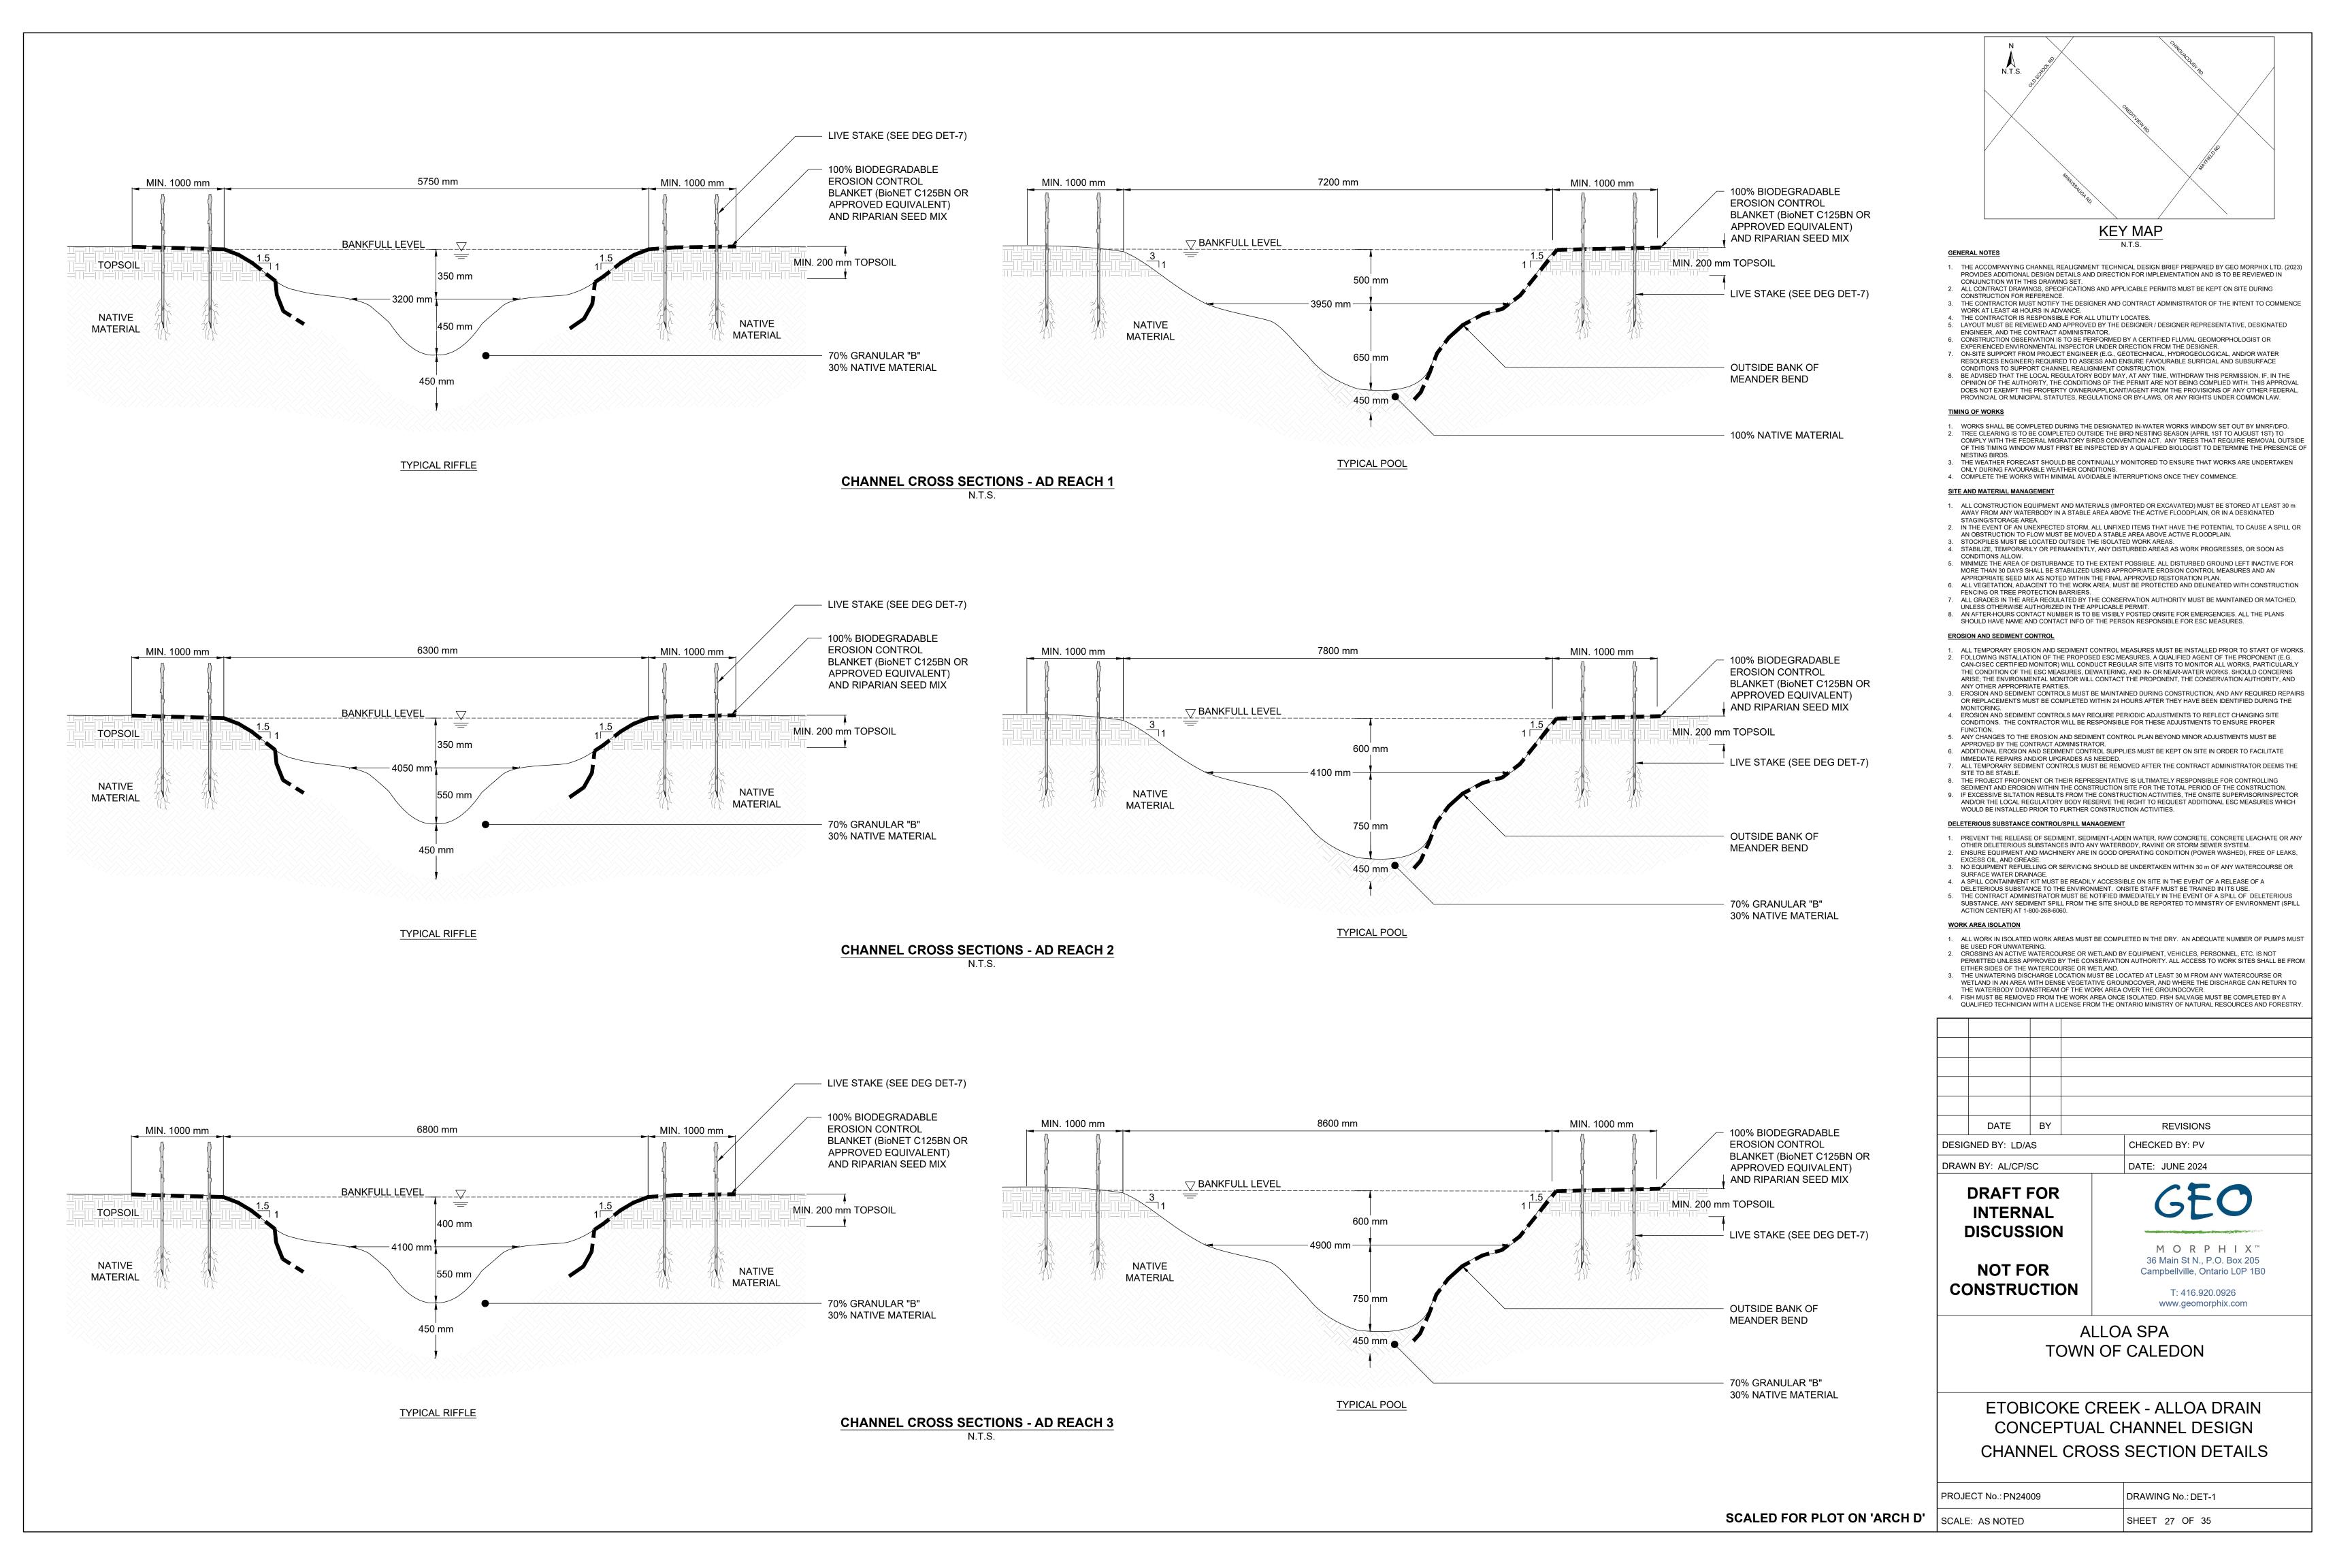

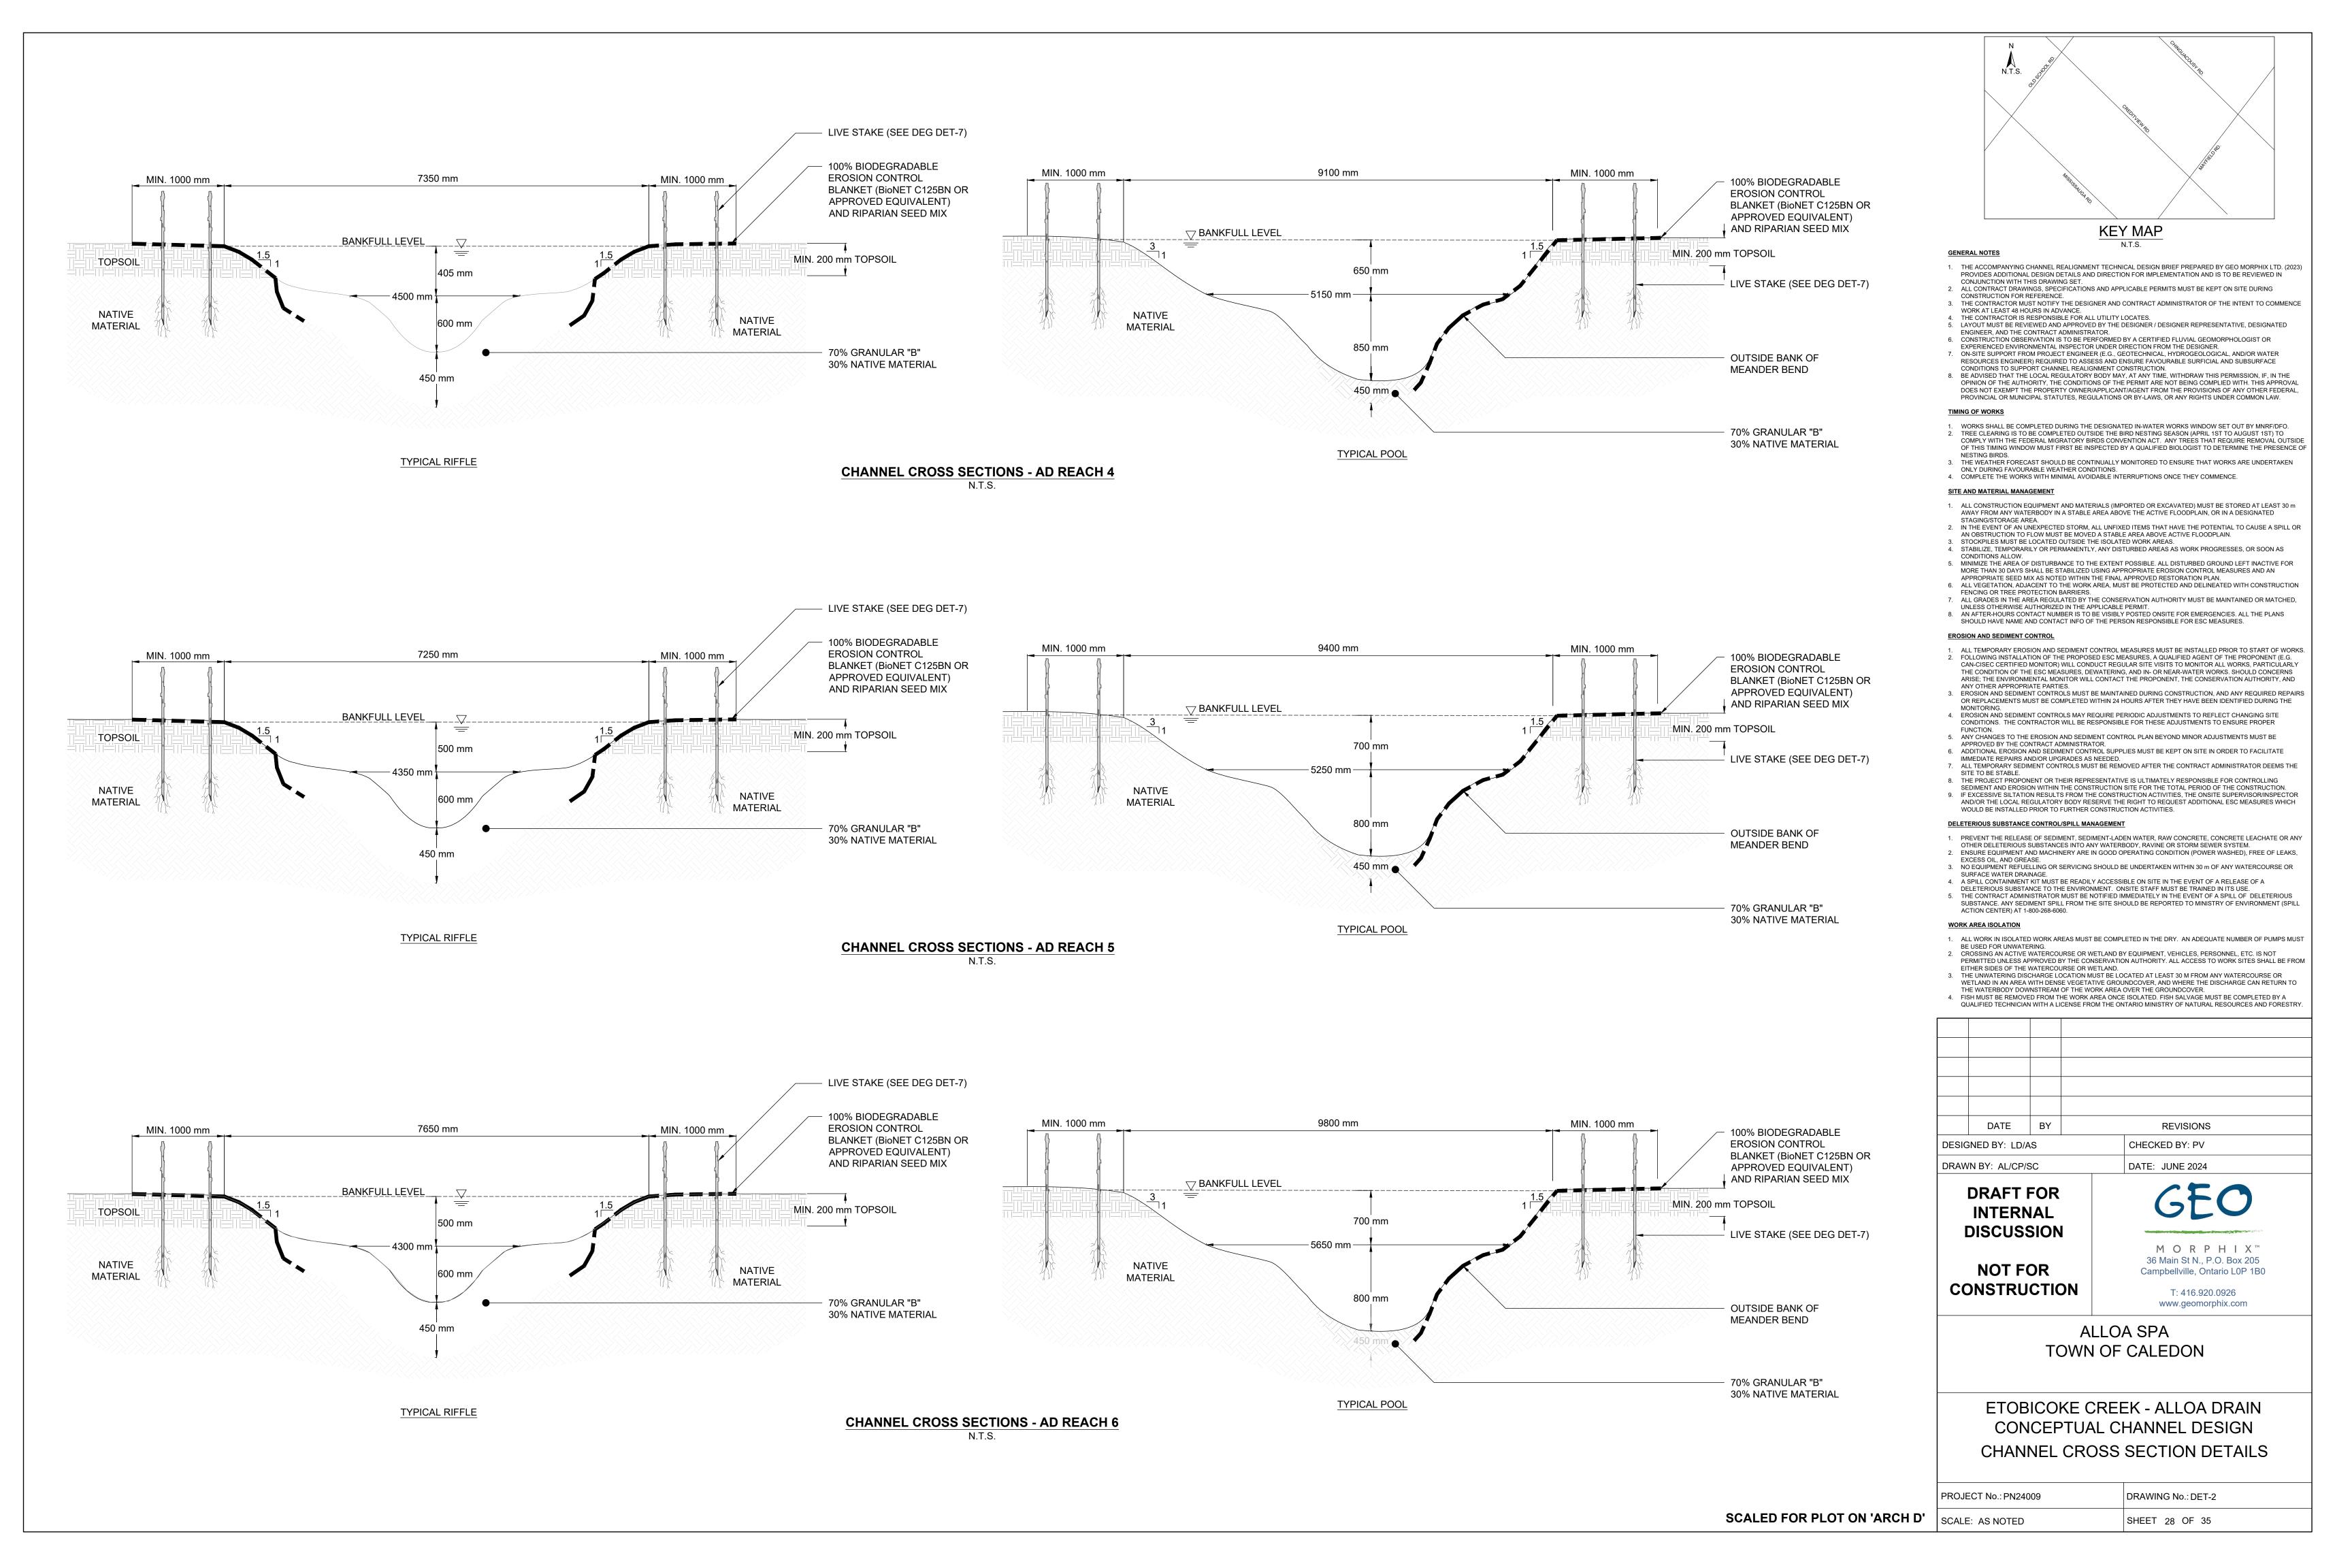

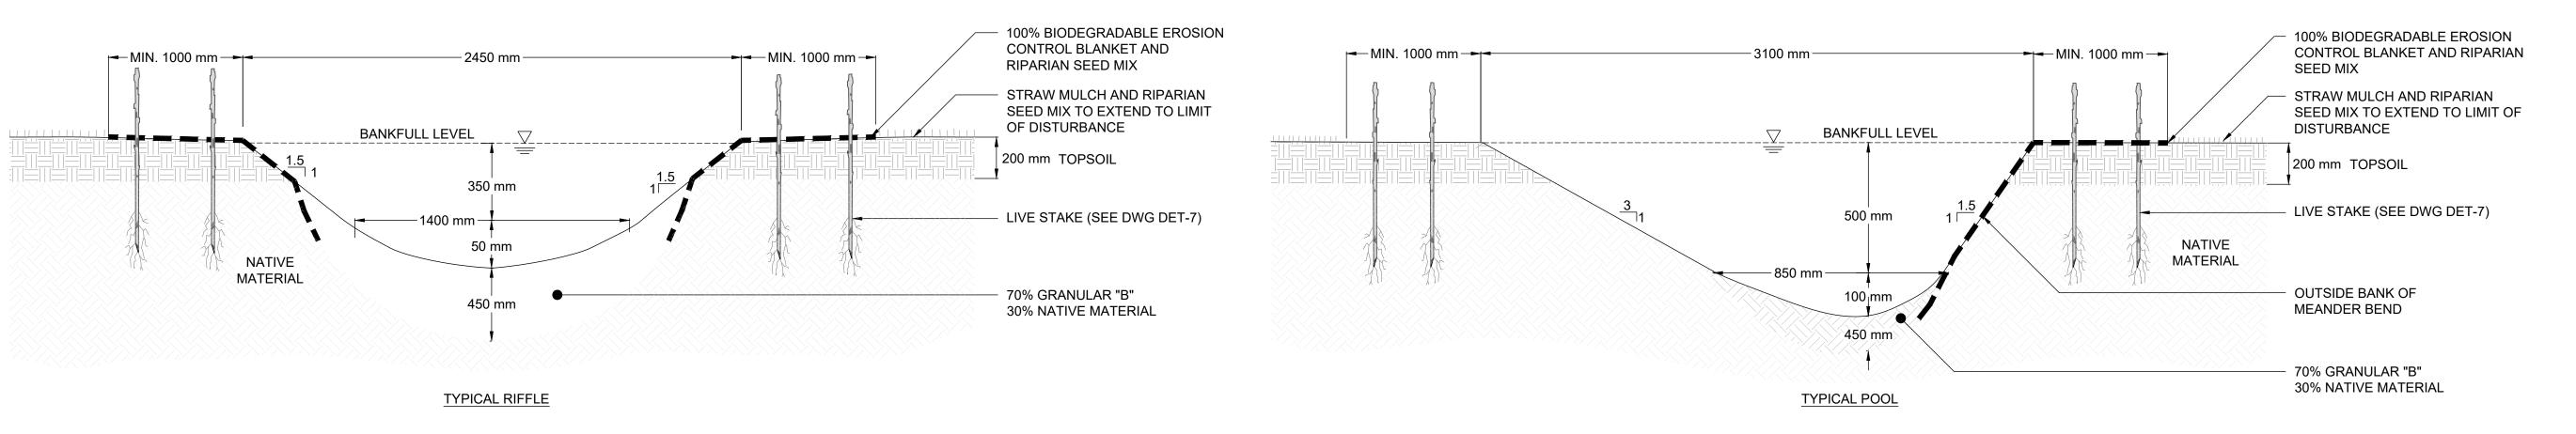

CHANNEL CROSS SECTIONS - AD5

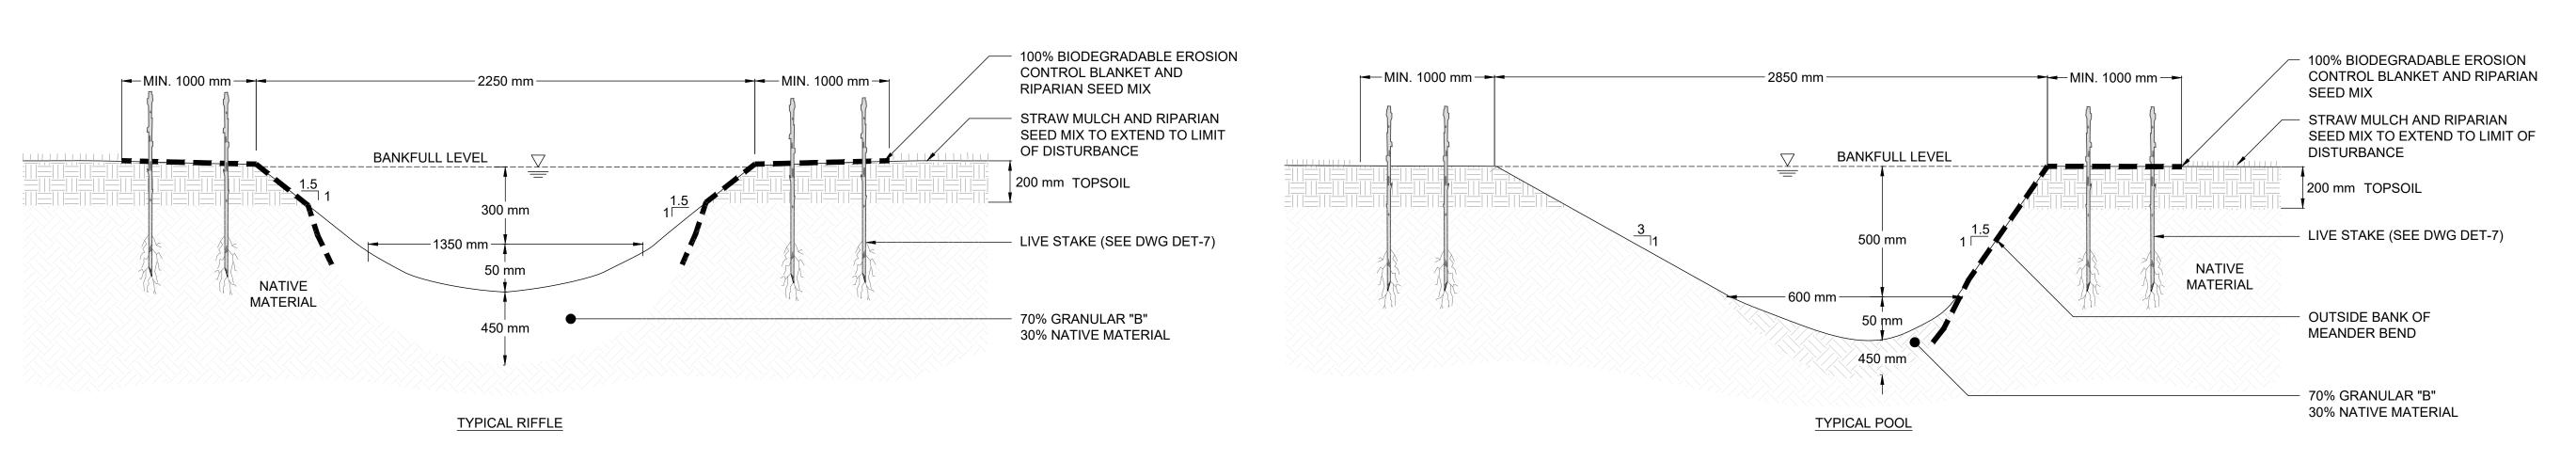


CHANNEL CROSS SECTIONS - LD4

100% BIODEGRADABLE EROSION 100% BIODEGRADABLE EROSION CONTROL BLANKET AND CONTROL BLANKET AND RIPARIAN MIN. 1000 mm → → MIN. 1000 mm → |**-** MIN. 1000 mm --►| - MIN. 1000 mm ---1500 mm -RIPARIAN SEED MIX SEED MIX STRAW MULCH AND RIPARIAN STRAW MULCH AND RIPARIAN SEED MIX TO EXTEND TO LIMIT SEED MIX TO EXTEND TO LIMIT OF OF DISTURBANCE DISTURBANCE BANKFULL LEVEL BANKFULL LEVEL 200 mm TOPSOIL 200 mm TOPSOIL 200 mm LIVE STAKE (SEE DWG DET-7) 400 mm LIVE STAKE (SEE DWG DET-7) NATIVE MATERIAL - 300 mm -MATERIAL OUTSIDE BANK OF 70% GRANULAR "B" 450 mm MEANDER BEND 30% NATIVE MATERIAL 450 mm 70% GRANULAR "B" 30% NATIVE MATERIAL TYPICAL RIFFLE TYPICAL POOL

CHANNEL CROSS SECTIONS - AD1

N.T.S.

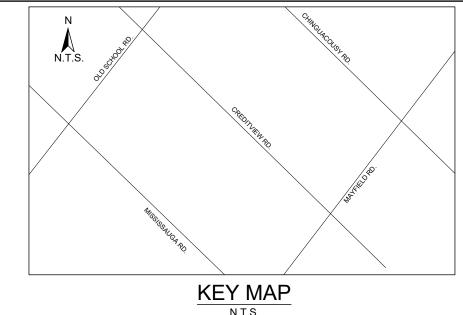

- 1. THE ACCOMPANYING CHANNEL REALIGNMENT TECHNICAL DESIGN BRIEF PREPARED BY GEO MORPHIX LTD. (2023) PROVIDES ADDITIONAL DESIGN DETAILS AND DIRECTION FOR IMPLEMENTATION AND IS TO BE REVIEWED IN
- CONJUNCTION WITH THIS DRAWING SET. 2. ALL CONTRACT DRAWINGS, SPECIFICATIONS AND APPLICABLE PERMITS MUST BE KEPT ON SITE DURING
- CONSTRUCTION FOR REFERENCE.

 3. THE CONTRACTOR MUST NOTIFY THE DESIGNER AND CONTRACT ADMINISTRATOR OF THE INTENT TO COMMENCE WORK AT LEAST 48 HOURS IN ADVANCE.
- THE CONTRACTOR IS RESPONSIBLE FOR ALL UTILITY LOCATES.
 LAYOUT MUST BE REVIEWED AND APPROVED BY THE DESIGNER / DESIGNER REPRESENTATIVE, DESIGNATED
- ENGINEER, AND THE CONTRACT ADMINISTRATOR.
- 6. CONSTRUCTION OBSERVATION IS TO BE PERFORMED BY A CERTIFIED FLUVIAL GEOMORPHOLOGIST OR EXPERIENCED ENVIRONMENTAL INSPECTOR UNDER DIRECTION FROM THE DESIGNER.
- 7. ON-SITE SUPPORT FROM PROJECT ENGINEER (E.G., GEOTECHNICAL, HYDROGEOLOGICAL, AND/OR WATER RESOURCES ENGINEER) REQUIRED TO ASSESS AND ENSURE FAVOURABLE SURFICIAL AND SUBSURFACE
- CONDITIONS TO SUPPORT CHANNEL REALIGNMENT CONSTRUCTION. 8. BE ADVISED THAT THE LOCAL REGULATORY BODY MAY, AT ANY TIME, WITHDRAW THIS PERMISSION, IF, IN THE OPINION OF THE AUTHORITY, THE CONDITIONS OF THE PERMIT ARE NOT BEING COMPLIED WITH. THIS APPROVAL DOES NOT EXEMPT THE PROPERTY OWNER/APPLICANT/AGENT FROM THE PROVISIONS OF ANY OTHER FEDERAL,

PROVINCIAL OR MUNICIPAL STATUTES, REGULATIONS OR BY-LAWS, OR ANY RIGHTS UNDER COMMON LAW.

- 1. WORKS SHALL BE COMPLETED DURING THE DESIGNATED IN-WATER WORKS WINDOW SET OUT BY MNRF/DFO. TREE CLEARING IS TO BE COMPLETED OUTSIDE THE BIRD NESTING SEASON (APRIL 1ST TO AUGUST 1ST) TO COMPLY WITH THE FEDERAL MIGRATORY BIRDS CONVENTION ACT. ANY TREES THAT REQUIRE REMOVAL OUTSIDE
- OF THIS TIMING WINDOW MUST FIRST BE INSPECTED BY A QUALIFIED BIOLOGIST TO DETERMINE THE PRESENCE OF
- 3. THE WEATHER FORECAST SHOULD BE CONTINUALLY MONITORED TO ENSURE THAT WORKS ARE UNDERTAKEN ONLY DURING FAVOURABLE WEATHER CONDITIONS.
- 4. COMPLETE THE WORKS WITH MINIMAL AVOIDABLE INTERRUPTIONS ONCE THEY COMMENCE.

SITE AND MATERIAL MANAGEMENT

- ALL CONSTRUCTION EQUIPMENT AND MATERIALS (IMPORTED OR EXCAVATED) MUST BE STORED AT LEAST 30 m AWAY FROM ANY WATERBODY IN A STABLE AREA ABOVE THE ACTIVE FLOODPLAIN, OR IN A DESIGNATED
- 2. IN THE EVENT OF AN UNEXPECTED STORM, ALL UNFIXED ITEMS THAT HAVE THE POTENTIAL TO CAUSE A SPILL OR AN OBSTRUCTION TO FLOW MUST BE MOVED A STABLE AREA ABOVE ACTIVE FLOODPLAIN.
- 3. STOCKPILES MUST BE LOCATED OUTSIDE THE ISOLATED WORK AREAS.
- STABILIZE, TEMPORARILY OR PERMANENTLY, ANY DISTURBED AREAS AS WORK PROGRESSES, OR SOON AS CONDITIONS ALLOW. 5. MINIMIZE THE AREA OF DISTURBANCE TO THE EXTENT POSSIBLE. ALL DISTURBED GROUND LEFT INACTIVE FOR
- MORE THAN 30 DAYS SHALL BE STABILIZED USING APPROPRIATE EROSION CONTROL MEASURES AND AN APPROPRIATE SEED MIX AS NOTED WITHIN THE FINAL APPROVED RESTORATION PLAN.
- 6. ALL VEGETATION, ADJACENT TO THE WORK AREA, MUST BE PROTECTED AND DELINEATED WITH CONSTRUCTION FENCING OR TREE PROTECTION BARRIERS.
- 7. ALL GRADES IN THE AREA REGULATED BY THE CONSERVATION AUTHORITY MUST BE MAINTAINED OR MATCHED, UNLESS OTHERWISE AUTHORIZED IN THE APPLICABLE PERMIT.
- AN AFTER-HOURS CONTACT NUMBER IS TO BE VISIBLY POSTED ONSITE FOR EMERGENCIES. ALL THE PLANS SHOULD HAVE NAME AND CONTACT INFO OF THE PERSON RESPONSIBLE FOR ESC MEASURES.

EROSION AND SEDIMENT CONTROL

- 1. ALL TEMPORARY EROSION AND SEDIMENT CONTROL MEASURES MUST BE INSTALLED PRIOR TO START OF WORKS. 2. FOLLOWING INSTALLATION OF THE PROPOSED ESC MEASURES, A QUALIFIED AGENT OF THE PROPONENT (E.G. CAN-CISEC CERTIFIED MONITOR) WILL CONDUCT REGULAR SITÉ VISITS TO MONITOR ALL WORKS, PARTICULARLY THE CONDITION OF THE ESC MEASURES, DEWATERING, AND IN- OR NEAR-WATER WORKS. SHOULD CONCERNS ARISE; THE ENVIRONMENTAL MONITOR WILL CONTACT THE PROPONENT, THE CONSERVATION AUTHORITY, AND
- ANY OTHER APPROPRIATE PARTIES. 3. EROSION AND SEDIMENT CONTROLS MUST BE MAINTAINED DURING CONSTRUCTION, AND ANY REQUIRED REPAIRS OR REPLACEMENTS MUST BE COMPLETED WITHIN 24 HOURS AFTER THEY HAVE BEEN IDENTIFIED DURING THE
- EROSION AND SEDIMENT CONTROLS MAY REQUIRE PERIODIC ADJUSTMENTS TO REFLECT CHANGING SITE CONDITIONS. THE CONTRACTOR WILL BE RESPONSIBLE FOR THESE ADJUSTMENTS TO ENSURE PROPER
- 5. ANY CHANGES TO THE EROSION AND SEDIMENT CONTROL PLAN BEYOND MINOR ADJUSTMENTS MUST BE APPROVED BY THE CONTRACT ADMINISTRATOR.
- 6. ADDITIONAL EROSION AND SEDIMENT CONTROL SUPPLIES MUST BE KEPT ON SITE IN ORDER TO FACILITATE
- IMMEDIATE REPAIRS AND/OR UPGRADES AS NEEDED.
 7. ALL TEMPORARY SEDIMENT CONTROLS MUST BE REMOVED AFTER THE CONTRACT ADMINISTRATOR DEEMS THE 8 THE PROJECT PROPONENT OR THEIR REPRESENTATIVE IS UI TIMATELY RESPONSIBLE FOR CONTROLLING
- SEDIMENT AND EROSION WITHIN THE CONSTRUCTION SITE FOR THE TOTAL PERIOD OF THE CONSTRUCTION. 9. IF EXCESSIVE SILTATION RESULTS FROM THE CONSTRUCTION ACTIVITIES, THE ONSITE SUPERVISOR/INSPECTOR AND/OR THE LOCAL REGULATORY BODY RESERVE THE RIGHT TO REQUEST ADDITIONAL ESC MEASURES WHICH
- WOULD BE INSTALLED PRIOR TO FURTHER CONSTRUCTION ACTIVITIES.

DELETERIOUS SUBSTANCE CONTROL/SPILL MANAGEMENT

- 1. PREVENT THE RELEASE OF SEDIMENT, SEDIMENT-LADEN WATER, RAW CONCRETE, CONCRETE LEACHATE OR ANY OTHER DELETERIOUS SUBSTANCES INTO ANY WATERBODY, RAVINE OR STORM SEWER SYSTEM. 2. ENSURE EQUIPMENT AND MACHINERY ARE IN GOOD OPERATING CONDITION (POWER WASHED), FREE OF LEAKS, EXCESS OIL, AND GREASE.

 3. NO EQUIPMENT REFUELLING OR SERVICING SHOULD BE UNDERTAKEN WITHIN 30 m OF ANY WATERCOURSE OR
- SURFACE WATER DRAINAGE.
- 4. A SPILL CONTAINMENT KIT MUST BE READILY ACCESSIBLE ON SITE IN THE EVENT OF A RELEASE OF A DELETERIOUS SUBSTANCE TO THE ENVIRONMENT. ONSITE STAFF MUST BE TRAINED IN ITS USE. 5. THE CONTRACT ADMINISTRATOR MUST BE NOTIFIED IMMEDIATELY IN THE EVENT OF A SPILL OF DELETERIOUS SUBSTANCE. ANY SEDIMENT SPILL FROM THE SITE SHOULD BE REPORTED TO MINISTRY OF ENVIRONMENT (SPILL ACTION CENTER) AT 1-800-268-6060.

WORK AREA ISOLATION

- 1. ALL WORK IN ISOLATED WORK AREAS MUST BE COMPLETED IN THE DRY. AN ADEQUATE NUMBER OF PUMPS MUST BE USED FOR UNWATERING.
 2. CROSSING AN ACTIVE WATERCOURSE OR WETLAND BY EQUIPMENT, VEHICLES, PERSONNEL, ETC. IS NOT
- PERMITTED UNLESS APPROVED BY THE CONSERVATION AUTHORITY. ALL ACCESS TO WORK SITES SHALL BE FROM EITHER SIDES OF THE WATERCOURSE OR WETLAND.
- 3. THE UNWATERING DISCHARGE LOCATION MUST BE LOCATED AT LEAST 30 M FROM ANY WATERCOURSE OR WETLAND IN AN AREA WITH DENSE VEGETATIVE GROUNDCOVER, AND WHERE THE DISCHARGE CAN RETURN TO THE WATERBODY DOWNSTREAM OF THE WORK AREA OVER THE GROUNDCOVER.
- 4. FISH MUST BE REMOVED FROM THE WORK AREA ONCE ISOLATED. FISH SALVAGE MUST BE COMPLETED BY A QUALIFIED TECHNICIAN WITH A LICENSE FROM THE ONTARIO MINISTRY OF NATURAL RESOURCES AND FORESTRY

	DATE	BY		REVISIONS
DESIG	DESIGNED BY: LD/AS			CHECKED BY: PV
DRAV	DRAWN BY: AL/CP/SC			DATE: JUNE 2024

DRAFT FOR INTERNAL DISCUSSION

NOT FOR **CONSTRUCTION**


 $M O R P H I X^{\mathsf{m}}$ 36 Main St N., P.O. Box 205 Campbellville, Ontario L0P 1B0 T: 416.920.0926

www.geomorphix.com

ALLOA SPA TOWN OF CALEDON

ETOBICOKE CREEK - ALLOA DRAIN CONCEPTUAL CHANNEL DESIGN CHANNEL CROSS SECTION DETAILS

DRAWING No.: DET-3 PROJECT No.: PN24009 SCALE: AS NOTED SHEET 29 OF 35

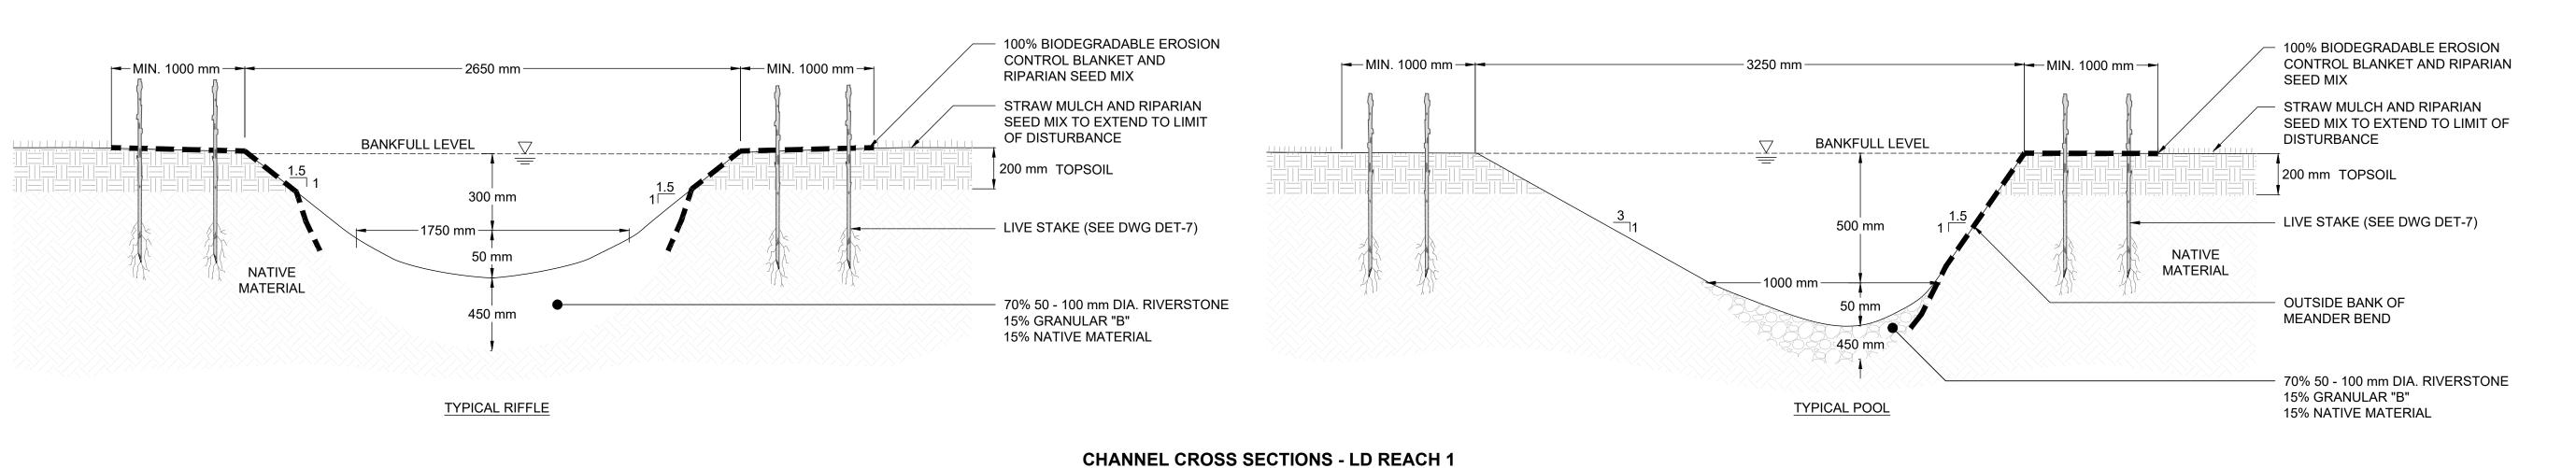

100% BIODEGRADABLE EROSION 100% BIODEGRADABLE EROSION CONTROL BLANKET AND CONTROL BLANKET AND RIPARIAN MIN. 1000 mm → -3200 mm -►|--- MIN. 1000 mm ---| | MIN. 1000 mm - - | - 2600 mm --|---- MIN. 1000 mm ---- RIPARIAN SEED MIX SEED MIX STRAW MULCH AND RIPARIAN STRAW MULCH AND RIPARIAN SEED MIX TO EXTEND TO LIMIT SEED MIX TO EXTEND TO LIMIT OF OF DISTURBANCE DISTURBANCE BANKFULL LEVEL BANKFULL LEVEL 200 mm TOPSOIL 200 mm TOPSOIL 300 mm LIVE STAKE (SEE DWG DET-7) 500 mm LIVE STAKE (SEE DWG DET-7) NATIVE MATERIAL – 950 mm – MATERIAL OUTSIDE BANK OF 70% 50 - 100 mm DIA. RIVERSTONE 50 mm 450 mm MEANDER BEND 15% GRANULAR "B" 15% NATIVE MATERIAL 450 mm 70% 50 - 100 mm DIA. RIVERSTONE 15% GRANULAR "B" TYPICAL RIFFLE TYPICAL POOL 15% NATIVE MATERIAL

CHANNEL CROSS SECTIONS - LD REACH 2

N.T.S.

100% BIODEGRADABLE EROSION 100% BIODEGRADABLE EROSION CONTROL BLANKET AND MIN. 1000 mm ---CONTROL BLANKET AND RIPARIAN | − MIN. 1000 mm - − −MIN. 1000 mm → RIPARIAN SEED MIX SEED MIX STRAW MULCH AND RIPARIAN STRAW MULCH AND RIPARIAN SEED MIX TO EXTEND TO LIMIT SEED MIX TO EXTEND TO LIMIT OF OF DISTURBANCE DISTURBANCE BANKFULL LEVEL BANKFULL LEVEL 200 mm TOPSOIL 200 mm TOPSOIL 300 mm LIVE STAKE (SEE DWG DET-7) 500 mm LIVE STAKE (SEE DWG DET-7) NATIVE MATERIAL NATIVE -1200 mm -MATERIAL OUTSIDE BANK OF 70% 50 - 100 mm DIA. RIVERSTONE 50 mm 450 mm MEANDER BEND 15% GRANULAR "B" 15% NATIVE MATERIAL 450 mm 70% 50 - 100 mm DIA. RIVERSTONE 15% GRANULAR "B" TYPICAL RIFFLE TYPICAL POOL 15% NATIVE MATERIAL

CHANNEL CROSS SECTIONS - LD5

- 1. THE ACCOMPANYING CHANNEL REALIGNMENT TECHNICAL DESIGN BRIEF PREPARED BY GEO MORPHIX LTD. (2023) PROVIDES ADDITIONAL DESIGN DETAILS AND DIRECTION FOR IMPLEMENTATION AND IS TO BE REVIEWED IN
- CONJUNCTION WITH THIS DRAWING SET. 2. ALL CONTRACT DRAWINGS, SPECIFICATIONS AND APPLICABLE PERMITS MUST BE KEPT ON SITE DURING
- CONSTRUCTION FOR REFERENCE.

 3. THE CONTRACTOR MUST NOTIFY THE DESIGNER AND CONTRACT ADMINISTRATOR OF THE INTENT TO COMMENCE
- WORK AT LEAST 48 HOURS IN ADVANCE. THE CONTRACTOR IS RESPONSIBLE FOR ALL UTILITY LOCATES.
 LAYOUT MUST BE REVIEWED AND APPROVED BY THE DESIGNER / DESIGNER REPRESENTATIVE, DESIGNATED
- ENGINEER, AND THE CONTRACT ADMINISTRATOR.
- 6. CONSTRUCTION OBSERVATION IS TO BE PERFORMED BY A CERTIFIED FLUVIAL GEOMORPHOLOGIST OR EXPERIENCED ENVIRONMENTAL INSPECTOR UNDER DIRECTION FROM THE DESIGNER.
- 7. ON-SITE SUPPORT FROM PROJECT ENGINEER (E.G., GEOTECHNICAL, HYDROGEOLOGICAL, AND/OR WATER RESOURCES ENGINEER) REQUIRED TO ASSESS AND ENSURE FAVOURABLE SURFICIAL AND SUBSURFACE CONDITIONS TO SUPPORT CHANNEL REALIGNMENT CONSTRUCTION.
- 8. BE ADVISED THAT THE LOCAL REGULATORY BODY MAY, AT ANY TIME, WITHDRAW THIS PERMISSION, IF, IN THE OPINION OF THE AUTHORITY. THE CONDITIONS OF THE PERMIT ARE NOT BEING COMPLIED WITH, THIS APPROVAL DOES NOT EXEMPT THE PROPERTY OWNER/APPLICANT/AGENT FROM THE PROVISIONS OF ANY OTHER FEDERAL,

- 1. WORKS SHALL BE COMPLETED DURING THE DESIGNATED IN-WATER WORKS WINDOW SET OUT BY MNRF/DFO. TREE CLEARING IS TO BE COMPLETED OUTSIDE THE BIRD NESTING SEASON (APRIL 1ST TO AUGUST 1ST) TO COMPLY WITH THE FEDERAL MIGRATORY BIRDS CONVENTION ACT. ANY TREES THAT REQUIRE REMOVAL OUTSIDE
- OF THIS TIMING WINDOW MUST FIRST BE INSPECTED BY A QUALIFIED BIOLOGIST TO DETERMINE THE PRESENCE OF

PROVINCIAL OR MUNICIPAL STATUTES, REGULATIONS OR BY-LAWS, OR ANY RIGHTS UNDER COMMON LAW.

- 3. THE WEATHER FORECAST SHOULD BE CONTINUALLY MONITORED TO ENSURE THAT WORKS ARE UNDERTAKEN ONLY DURING FAVOURABLE WEATHER CONDITIONS.
- 4. COMPLETE THE WORKS WITH MINIMAL AVOIDABLE INTERRUPTIONS ONCE THEY COMMENCE.

SITE AND MATERIAL MANAGEMENT

- ALL CONSTRUCTION EQUIPMENT AND MATERIALS (IMPORTED OR EXCAVATED) MUST BE STORED AT LEAST 30 m AWAY FROM ANY WATERBODY IN A STABLE AREA ABOVE THE ACTIVE FLOODPLAIN, OR IN A DESIGNATED
- 2. IN THE EVENT OF AN UNEXPECTED STORM, ALL UNFIXED ITEMS THAT HAVE THE POTENTIAL TO CAUSE A SPILL OR AN OBSTRUCTION TO FLOW MUST BE MOVED A STABLE AREA ABOVE ACTIVE FLOODPLAIN.
- 3. STOCKPILES MUST BE LOCATED OUTSIDE THE ISOLATED WORK AREAS. STABILIZE, TEMPORARILY OR PERMANENTLY, ANY DISTURBED AREAS AS WORK PROGRESSES, OR SOON AS CONDITIONS ALLOW.
- 5. MINIMIZE THE AREA OF DISTURBANCE TO THE EXTENT POSSIBLE. ALL DISTURBED GROUND LEFT INACTIVE FOR
- MORE THAN 30 DAYS SHALL BE STABILIZED USING APPROPRIATE EROSION CONTROL MEASURES AND AN APPROPRIATE SEED MIX AS NOTED WITHIN THE FINAL APPROVED RESTORATION PLAN.
- 6. ALL VEGETATION, ADJACENT TO THE WORK AREA, MUST BE PROTECTED AND DELINEATED WITH CONSTRUCTION FENCING OR TREE PROTECTION BARRIERS.
- 7. ALL GRADES IN THE AREA REGULATED BY THE CONSERVATION AUTHORITY MUST BE MAINTAINED OR MATCHED, UNLESS OTHERWISE AUTHORIZED IN THE APPLICABLE PERMIT.
- AN AFTER-HOURS CONTACT NUMBER IS TO BE VISIBLY POSTED ONSITE FOR EMERGENCIES. ALL THE PLANS SHOULD HAVE NAME AND CONTACT INFO OF THE PERSON RESPONSIBLE FOR ESC MEASURES.

EROSION AND SEDIMENT CONTROL

- 1. ALL TEMPORARY EROSION AND SEDIMENT CONTROL MEASURES MUST BE INSTALLED PRIOR TO START OF WORKS. 2. FOLLOWING INSTALLATION OF THE PROPOSED ESC MEASURES, A QUALIFIED AGENT OF THE PROPONENT (E.G. CAN-CISEC CERTIFIED MONITOR) WILL CONDUCT REGULAR SITÉ VISITS TO MONITOR ALL WORKS, PARTICULARLY THE CONDITION OF THE ESC MEASURES, DEWATERING, AND IN- OR NEAR-WATER WORKS. SHOULD CONCERNS ARISE; THE ENVIRONMENTAL MONITOR WILL CONTACT THE PROPONENT, THE CONSERVATION AUTHORITY, AND
- ANY OTHER APPROPRIATE PARTIES. 3. EROSION AND SEDIMENT CONTROLS MUST BE MAINTAINED DURING CONSTRUCTION, AND ANY REQUIRED REPAIRS OR REPLACEMENTS MUST BE COMPLETED WITHIN 24 HOURS AFTER THEY HAVE BEEN IDENTIFIED DURING THE
- EROSION AND SEDIMENT CONTROLS MAY REQUIRE PERIODIC ADJUSTMENTS TO REFLECT CHANGING SITE CONDITIONS. THE CONTRACTOR WILL BE RESPONSIBLE FOR THESE ADJUSTMENTS TO ENSURE PROPER
- 5. ANY CHANGES TO THE EROSION AND SEDIMENT CONTROL PLAN BEYOND MINOR ADJUSTMENTS MUST BE APPROVED BY THE CONTRACT ADMINISTRATOR. 6. ADDITIONAL EROSION AND SEDIMENT CONTROL SUPPLIES MUST BE KEPT ON SITE IN ORDER TO FACILITATE
- IMMEDIATE REPAIRS AND/OR UPGRADES AS NEEDED.
 7. ALL TEMPORARY SEDIMENT CONTROLS MUST BE REMOVED AFTER THE CONTRACT ADMINISTRATOR DEEMS THE
- 8. THE PROJECT PROPONENT OR THEIR REPRESENTATIVE IS ULTIMATELY RESPONSIBLE FOR CONTROLLING SEDIMENT AND EROSION WITHIN THE CONSTRUCTION SITE FOR THE TOTAL PERIOD OF THE CONSTRUCTION. 9. IF EXCESSIVE SILTATION RESULTS FROM THE CONSTRUCTION ACTIVITIES, THE ONSITE SUPERVISOR/INSPECTOR
- AND/OR THE LOCAL REGULATORY BODY RESERVE THE RIGHT TO REQUEST ADDITIONAL ESC MEASURES WHICH WOULD BE INSTALLED PRIOR TO FURTHER CONSTRUCTION ACTIVITIES.

DELETERIOUS SUBSTANCE CONTROL/SPILL MANAGEMENT

- 1. PREVENT THE RELEASE OF SEDIMENT, SEDIMENT-LADEN WATER, RAW CONCRETE, CONCRETE LEACHATE OR ANY OTHER DELETERIOUS SUBSTANCES INTO ANY WATERBODY, RAVINE OR STORM SEWER SYSTEM. 2. ENSURE EQUIPMENT AND MACHINERY ARE IN GOOD OPERATING CONDITION (POWER WASHED), FREE OF LEAKS, EXCESS OIL, AND GREASE.

 3. NO EQUIPMENT REFUELLING OR SERVICING SHOULD BE UNDERTAKEN WITHIN 30 m OF ANY WATERCOURSE OR
- SURFACE WATER DRAINAGE. 4. A SPILL CONTAINMENT KIT MUST BE READILY ACCESSIBLE ON SITE IN THE EVENT OF A RELEASE OF A DELETERIOUS SUBSTANCE TO THE ENVIRONMENT. ONSITE STAFF MUST BE TRAINED IN ITS USE.
- 5. THE CONTRACT ADMINISTRATOR MUST BE NOTIFIED IMMEDIATELY IN THE EVENT OF A SPILL OF DELETERIOUS SUBSTANCE. ANY SEDIMENT SPILL FROM THE SITE SHOULD BE REPORTED TO MINISTRY OF ENVIRONMENT (SPILL ACTION CENTER) AT 1-800-268-6060.

WORK AREA ISOLATION

- 1. ALL WORK IN ISOLATED WORK AREAS MUST BE COMPLETED IN THE DRY. AN ADEQUATE NUMBER OF PUMPS MUST BE USED FOR UNWATERING.
 2. CROSSING AN ACTIVE WATERCOURSE OR WETLAND BY EQUIPMENT, VEHICLES, PERSONNEL, ETC. IS NOT
- PERMITTED UNLESS APPROVED BY THE CONSERVATION AUTHORITY. ALL ACCESS TO WORK SITES SHALL BE FROM
- EITHER SIDES OF THE WATERCOURSE OR WETLAND. 3. THE UNWATERING DISCHARGE LOCATION MUST BE LOCATED AT LEAST 30 M FROM ANY WATERCOURSE OR WETLAND IN AN AREA WITH DENSE VEGETATIVE GROUNDCOVER, AND WHERE THE DISCHARGE CAN RETURN TO
- THE WATERBODY DOWNSTREAM OF THE WORK AREA OVER THE GROUNDCOVER. 4. FISH MUST BE REMOVED FROM THE WORK AREA ONCE ISOLATED. FISH SALVAGE MUST BE COMPLETED BY A QUALIFIED TECHNICIAN WITH A LICENSE FROM THE ONTARIO MINISTRY OF NATURAL RESOURCES AND FORESTRY

	DATE	BY	REVISIONS	
DESIGNED BY: LD/AS		CHECKED BY: PV		
DRAWN BY: AL/CP/SC			DATE: JUNE 2024	

DRAFT FOR

INTERNAL DISCUSSION

NOT FOR CONSTRUCTION

 $M O R P H I X^{\mathsf{m}}$ 36 Main St N., P.O. Box 205 Campbellville, Ontario L0P 1B0 T: 416.920.0926

www.geomorphix.com


ALLOA SPA **TOWN OF CALEDON**


ETOBICOKE CREEK - ALLOA DRAIN CONCEPTUAL CHANNEL DESIGN CHANNEL CROSS SECTION DETAILS


SHEET 30 OF 35

DRAWING No.: DET-4 PROJECT No.: PN24009

SCALE: AS NOTED

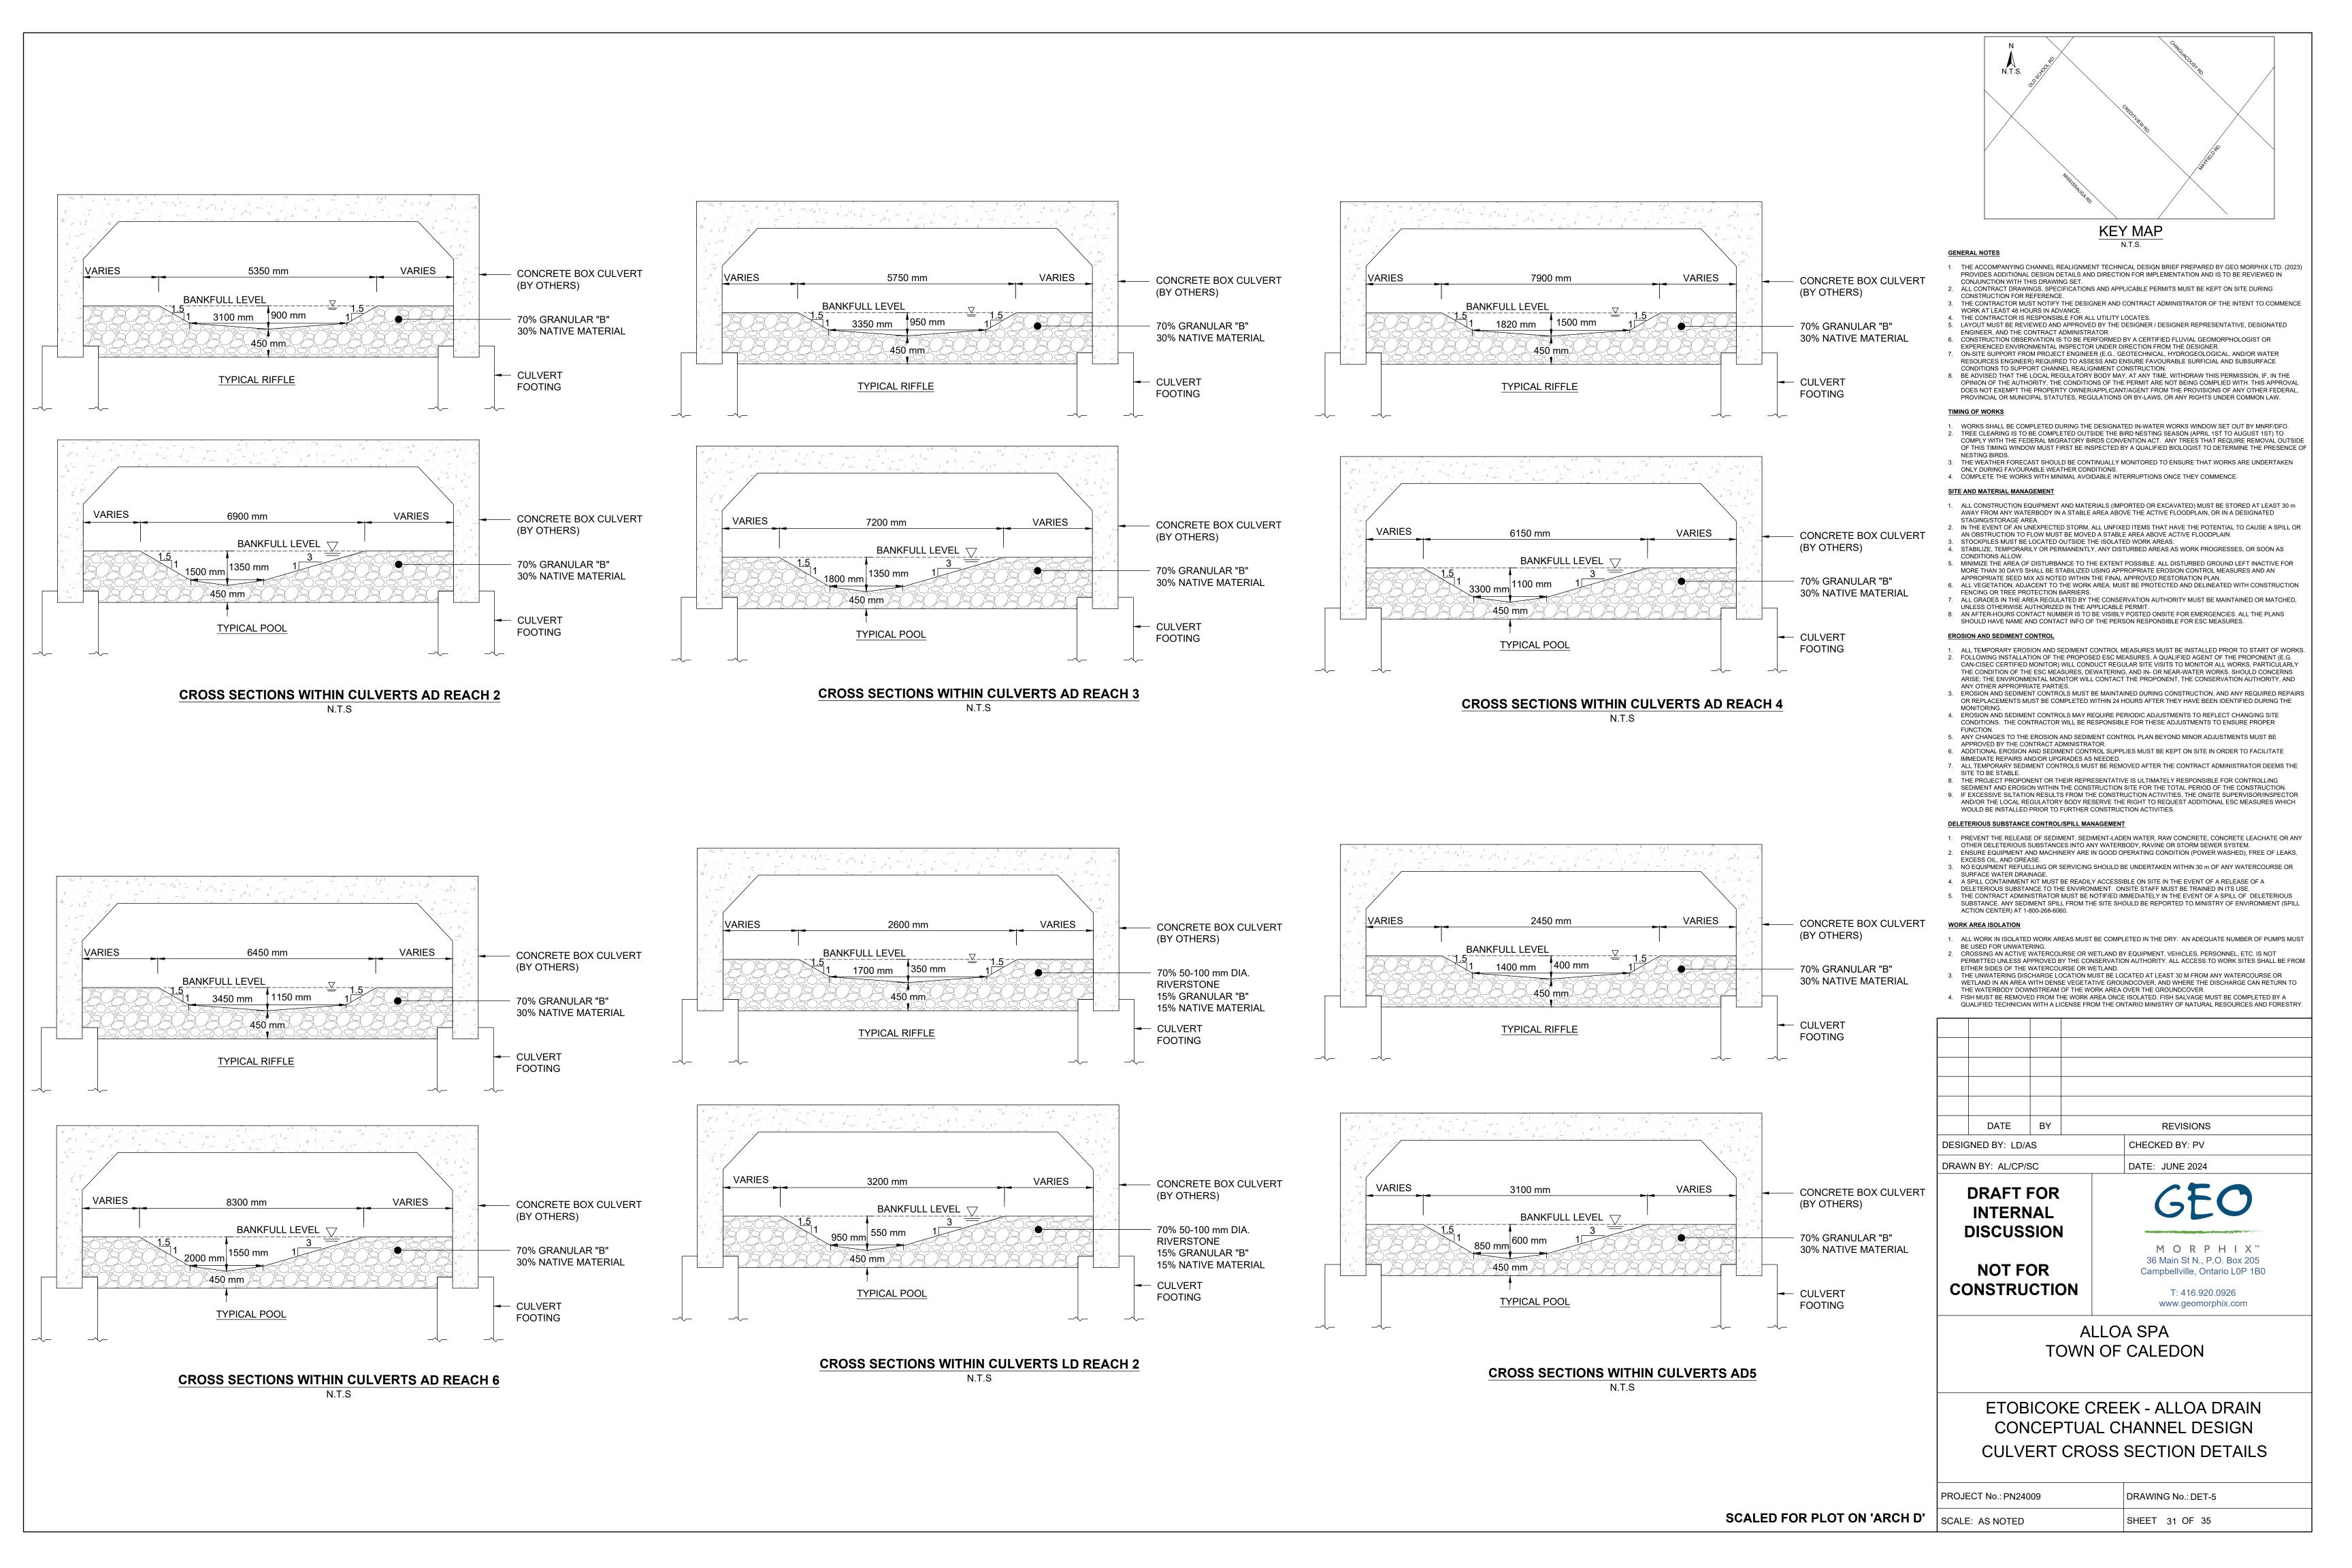

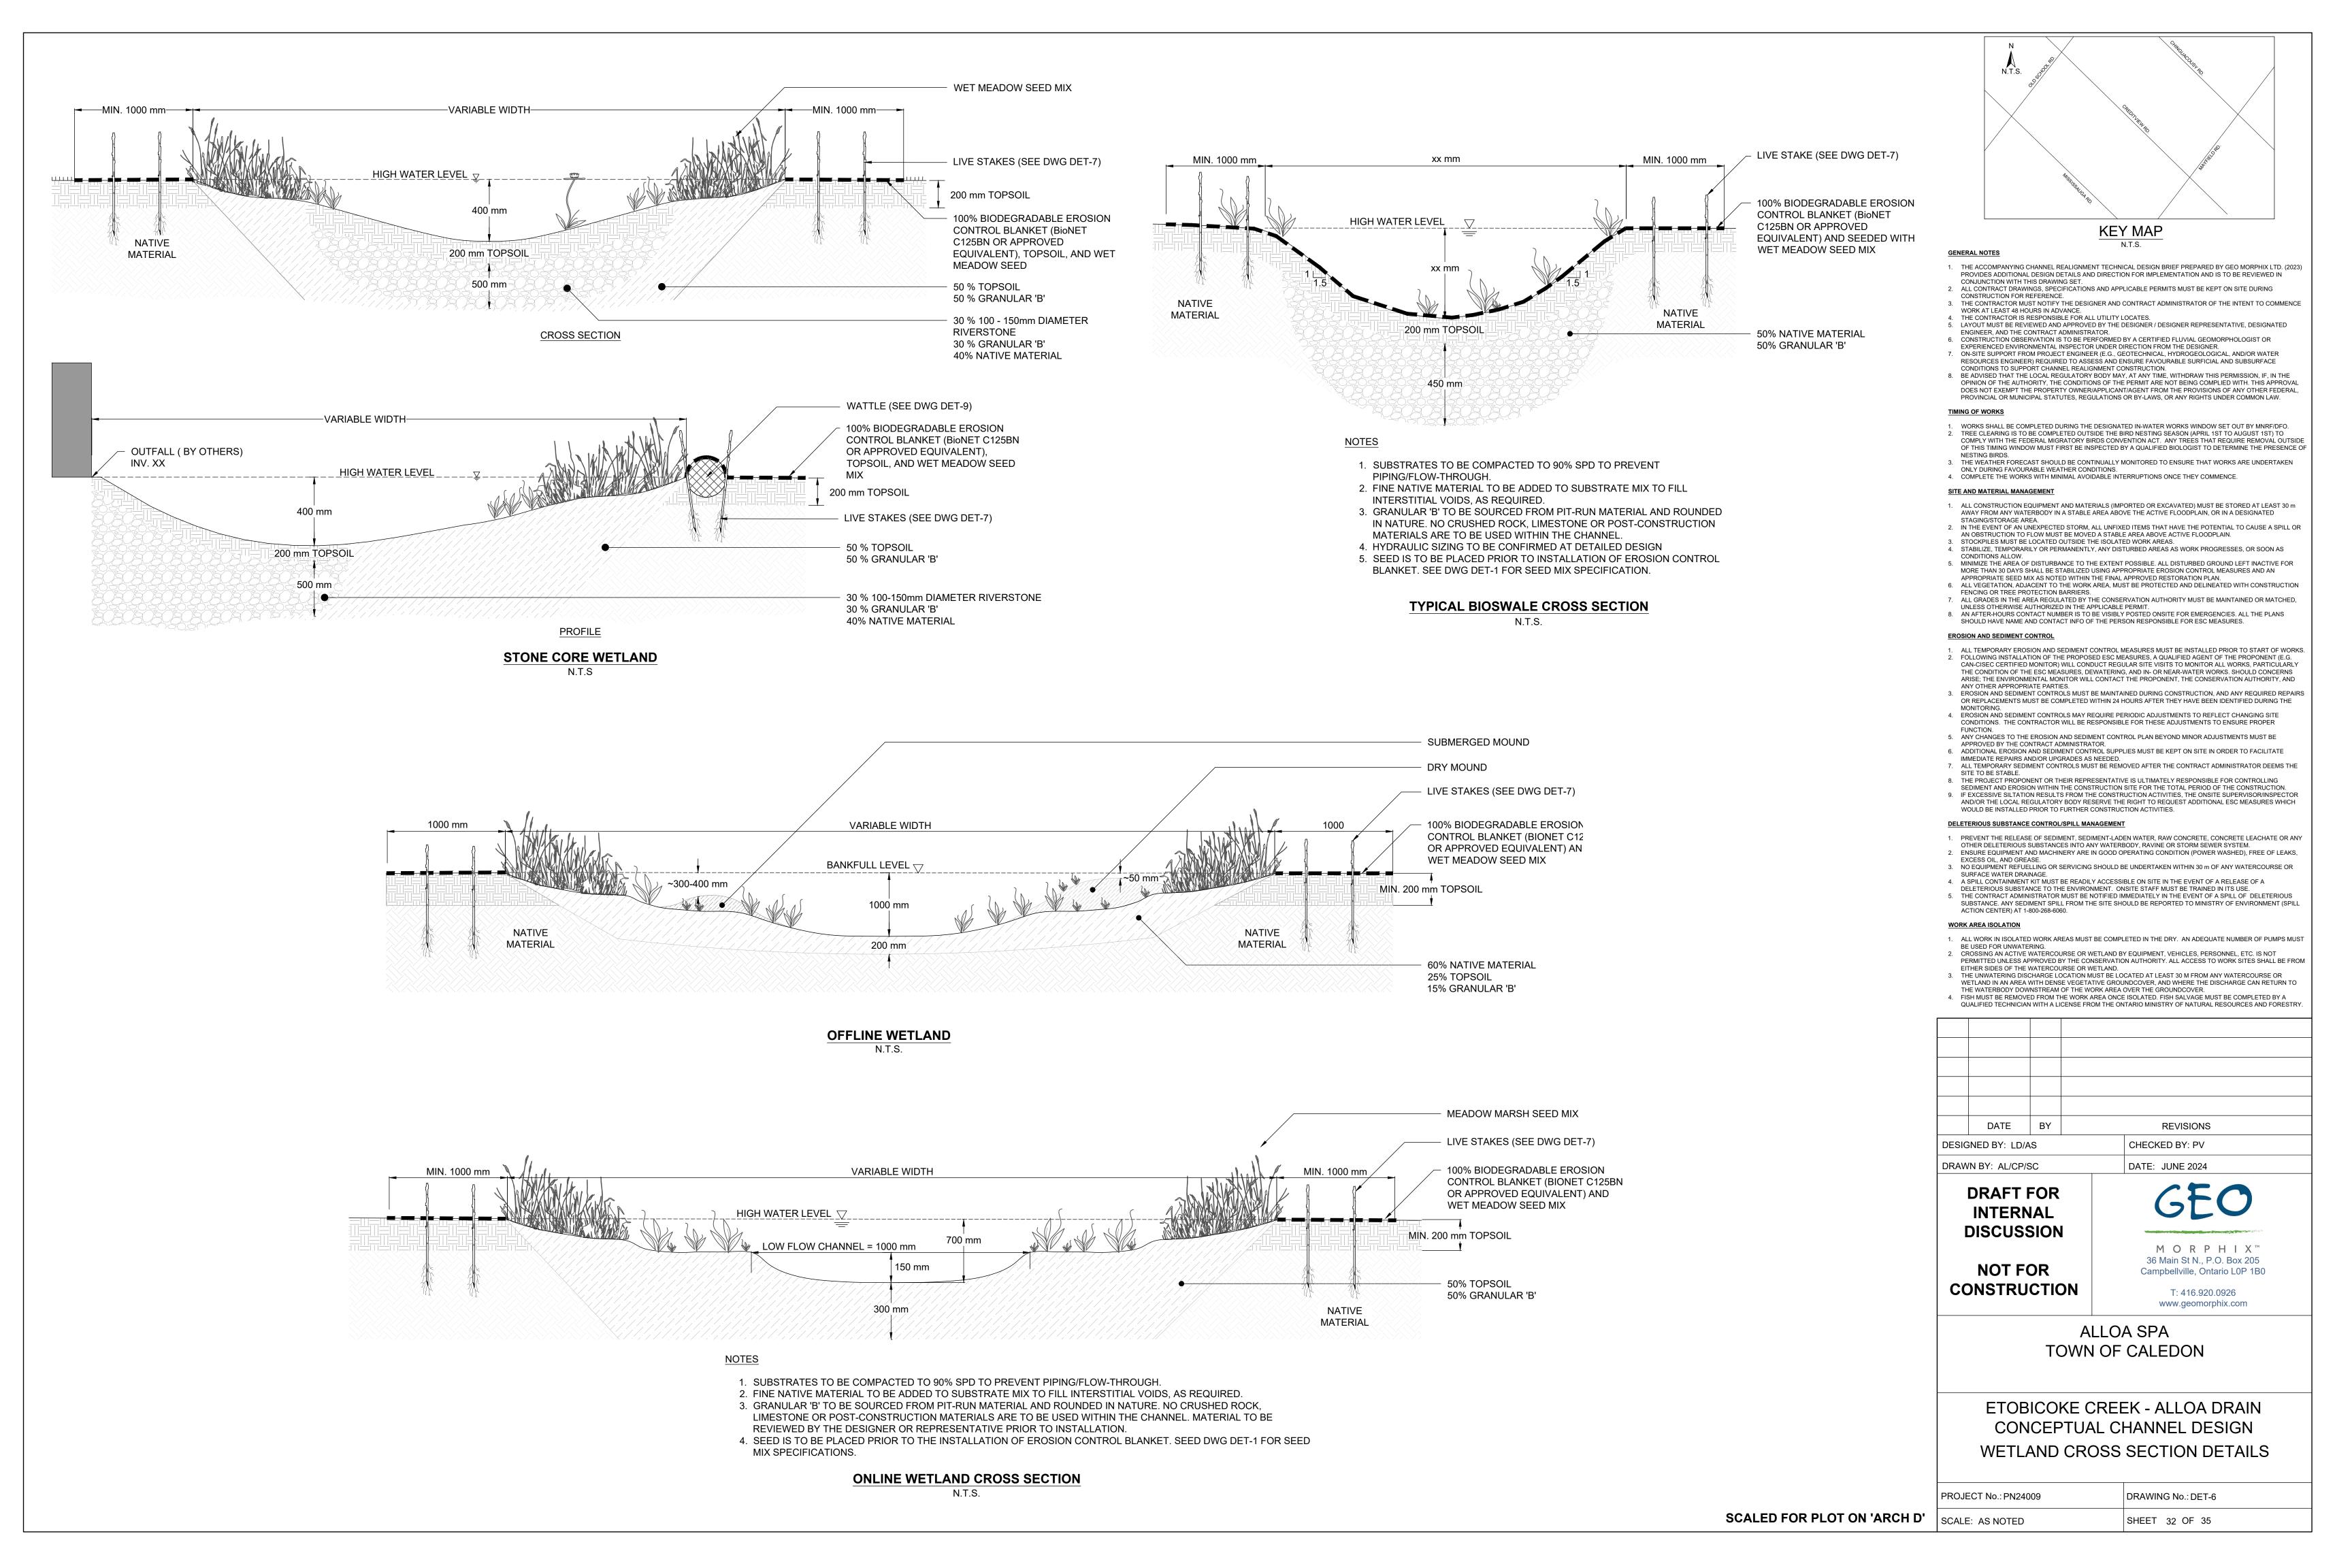


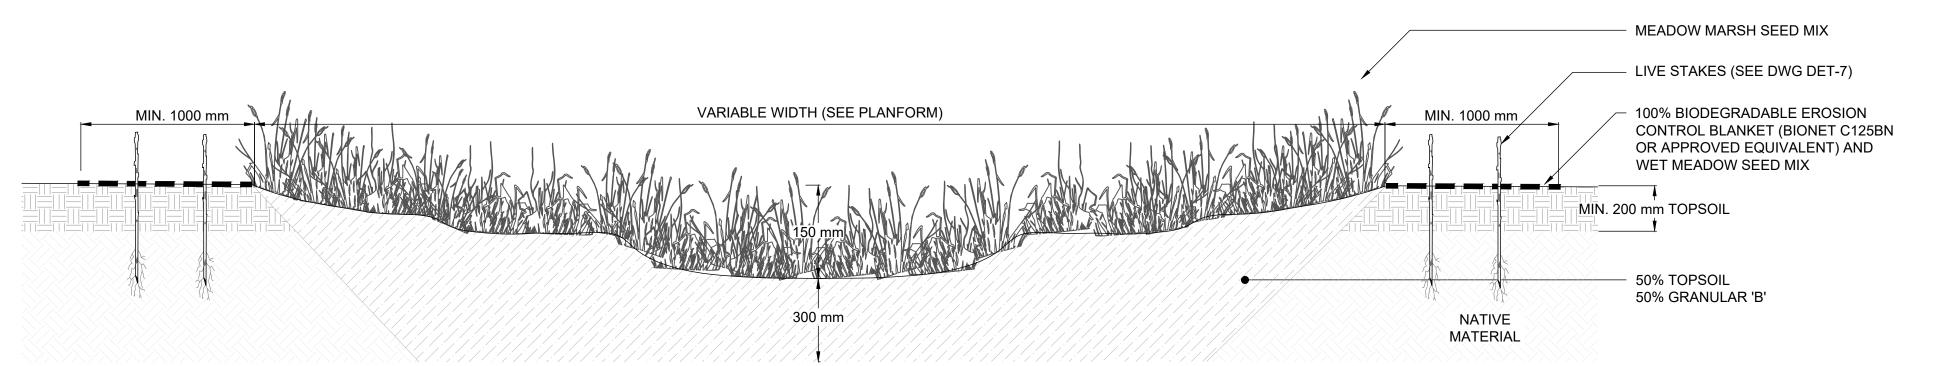

<u>NOTES</u>

- SUBSTRATES TO BE COMPACTED TO 90% SPD TO PREVENT PIPING/FLOW-THROUGH.
- 2. FINE NATIVE MATERIAL TO BE ADDED TO SUBSTRATE MIX TO FILL INTERSTITIAL VOIDS, AS REQUIRED.
- 3. GRANULAR 'B' TO BE SOURCED FROM PIT-RUN MATERIAL AND ROUNDED IN NATURE. NO CRUSHED ROCK, LIMESTONE OR POST-CONSTRUCTION MATERIALS ARE TO BE USED WITHIN THE CHANNEL. MATERIAL TO BE
- REVIEWED BY THE DESIGNER OR REPRESENTATIVE PRIOR TO INSTALLATION.
- 4. SEED IS TO BE PLACED PRIOR TO THE INSTALLATION OF EROSION CONTROL BLANKET. SEED DWG DET-1 FOR SEED
- MIX SPECIFICATIONS.

MEADOW SWALE CROSS SECTION

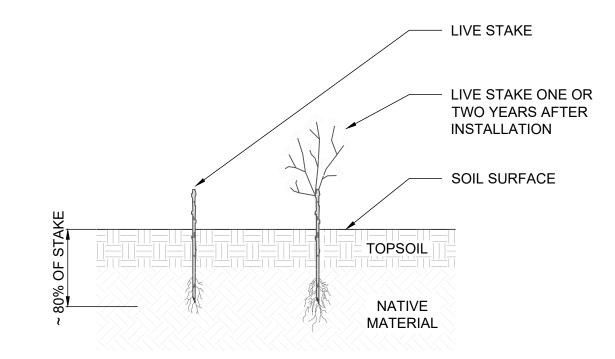



DIVERSE STREAM BANK PLANTING

SCIENTIFIC NAME	COMMON NAME	CONDITION
CORNUS SERICEA	RED OSIER DOGWOOD	1 m, LIVE STAKE
PHYSOCARPUS OPULIFOLIUS	COMMON NINEBARK	1 m, LIVE STAKE
SALIX BEBBIANA	BEBB'S WILLOW	1 m, LIVE STAKE
SALIX DISCOLOR	PUSSY WILLOW	1 m, LIVE STAKE
SALIX EXIGUA	SANDBAR WILLOW	1 m, LIVE STAKE
SALIX LUCIDA	SHINING WILLOW	1 m, LIVE STAKE
SAMBUCUS CANADENSIS	COMMON ELDERBERRY	1 m, LIVE STAKE

- . QUANTITY TO BE DETERMINED BASED ON AREA OF DISTURBANCE TO BE RESTORED
- 2. LIVE STAKES SHOULD BE FROM AT MINIMUM 2-YEAR OLD STOCK.
- 3. LIVE STAKES ARE TO BE INSTALLED AT A DENSITY OF 3 STAKES PER SQUARE METRE.
- 4. LIVE STAKES SHOULD BE PRE-SOAKED (SUBMERGED IN WATER) FOR AT LEAST 24 HOURS
- AFTER HARVESTING AND IMMEDIATELY BEFORE INSTALLATION. 5. LIVE STAKES SHOULD NOT BE STORED FOR A PERIOD LONGER THAN 2 DAYS, UNLESS THEY ARE
- BEING SOAKED.
- 6. THE CONTRACTOR SHALL PROTECT PLANT MATERIALS FROM DRYING FROM THE TIME OF
- HARVEST UNTIL INSTALLED.
- 7. LIVE STAKES ARE TO BE A MINIMUM OF 25 mm IN DIAMETER AND CUT TO A LENGTH OF 1000 mm. 8. CUT ANGLE AT THE BOTTOM OF THE STAKE AND FLAT ON THE TOP.
- 9. TRIM ALL SIDE BRANCHES WHILE TAKING CARE NOT TO DAMAGE THE BARK.
- 10. INSTALL STAKES WITH BUDS POINTING UPWARDS AND THICKER STEM IN THE BED.
- 11. LIVE STAKES SHOULD BE INSTALLED USING A LARGE RUBBER MALLET.
- 12. 80% OF THE STAKE IS TO BE BELOW SURFACE.
- 13. TAMP THE LIVE STAKE INTO THE GROUND AT RIGHT ANGLE TO THE SURFACE.
- 14. IN COMPACT SOIL A PILOT HOLE SHOULD BE USED TO LIMIT DAMAGE TO THE STAKES.
- 15. IF USING A PILOT HOLE REPACK SOIL AROUND THE LIVE STAKE.
- 16. LIVE STAKES SHOULD STAND FIRM FROM THE SOIL FOLLOWING INSTALLATION.
- 17. ALL STAKES NOT PLANTED TO THE SPECIFICATIONS ABOVE WILL BE REPLACED AT THE
- CONTRACTOR'S EXPENSE.

LIVE STAKING

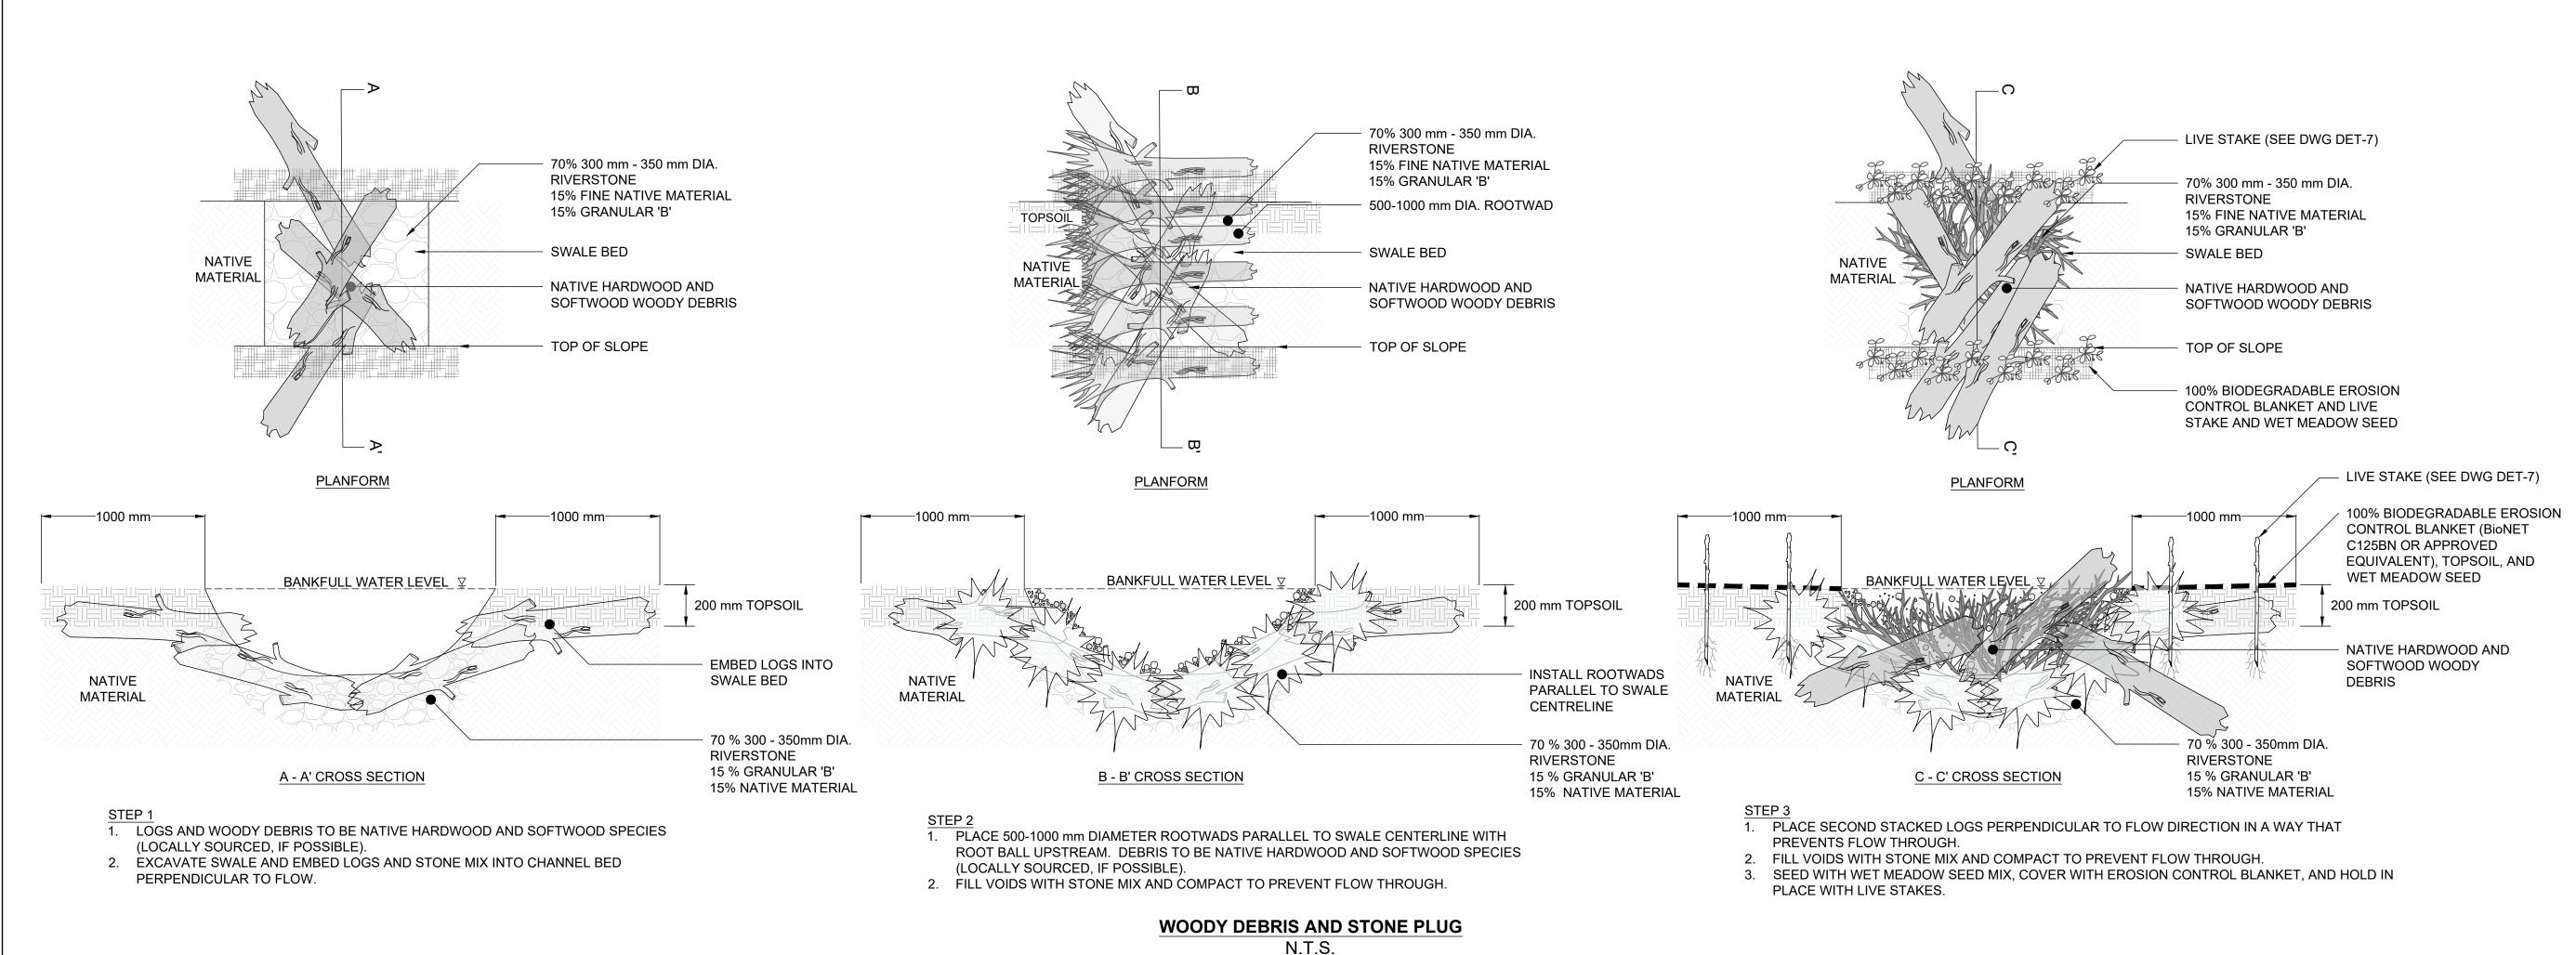

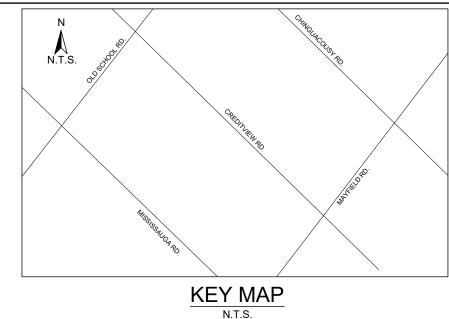

- 1. THE ACCOMPANYING CHANNEL REALIGNMENT TECHNICAL DESIGN BRIEF PREPARED BY GEO MORPHIX LTD. (2023) PROVIDES ADDITIONAL DESIGN DETAILS AND DIRECTION FOR IMPLEMENTATION AND IS TO BE REVIEWED IN
- CONJUNCTION WITH THIS DRAWING SET. 2. ALL CONTRACT DRAWINGS, SPECIFICATIONS AND APPLICABLE PERMITS MUST BE KEPT ON SITE DURING
- CONSTRUCTION FOR REFERENCE. 3. THE CONTRACTOR MUST NOTIFY THE DESIGNER AND CONTRACT ADMINISTRATOR OF THE INTENT TO COMMENCE WORK AT LEAST 48 HOURS IN ADVANCE.
- 4. THE CONTRACTOR IS RESPONSIBLE FOR ALL UTILITY LOCATES. 5. LAYOUT MUST BE REVIEWED AND APPROVED BY THE DESIGNER / DESIGNER REPRESENTATIVE, DESIGNATED
- ENGINEER, AND THE CONTRACT ADMINISTRATOR.
- 6. CONSTRUCTION OBSERVATION IS TO BE PERFORMED BY A CERTIFIED FLUVIAL GEOMORPHOLOGIST OR
- EXPERIENCED ENVIRONMENTAL INSPECTOR UNDER DIRECTION FROM THE DESIGNER.
- 7. ON-SITE SUPPORT FROM PROJECT ENGINEER (E.G., GEOTECHNICAL, HYDROGEOLOGICAL, AND/OR WATER RESOURCES ENGINEER) REQUIRED TO ASSESS AND ENSURE FAVOURABLE SURFICIAL AND SUBSURFACE CONDITIONS TO SUPPORT CHANNEL REALIGNMENT CONSTRUCTION.
- 8. BE ADVISED THAT THE LOCAL REGULATORY BODY MAY, AT ANY TIME, WITHDRAW THIS PERMISSION, IF, IN THE OPINION OF THE AUTHORITY THE CONDITIONS OF THE PERMIT ARE NOT BEING COMPLIED WITH THIS APPROVAL DOES NOT EXEMPT THE PROPERTY OWNER/APPLICANT/AGENT FROM THE PROVISIONS OF ANY OTHER FEDERAL, PROVINCIAL OR MUNICIPAL STATUTES, REGULATIONS OR BY-LAWS, OR ANY RIGHTS UNDER COMMON LAW.

- 1 WORKS SHALL BE COMPLETED DURING THE DESIGNATED IN-WATER WORKS WINDOW SET OUT BY MNRE/DEO TREE CLEARING IS TO BE COMPLETED OUTSIDE THE BIRD NESTING SEASON (APRIL 1ST TO AUGUST 1ST) TO COMPLY WITH THE FEDERAL MIGRATORY BIRDS CONVENTION ACT. ANY TREES THAT REQUIRE REMOVAL OUTSIDE
- OF THIS TIMING WINDOW MUST FIRST BE INSPECTED BY A QUALIFIED BIOLOGIST TO DETERMINE THE PRESENCE OF
- 3. THE WEATHER FORECAST SHOULD BE CONTINUALLY MONITORED TO ENSURE THAT WORKS ARE UNDERTAKEN

ONLY DURING FAVOURABLE WEATHER CONDITIONS. 4. COMPLETE THE WORKS WITH MINIMAL AVOIDABLE INTERRUPTIONS ONCE THEY COMMENCE.

SITE AND MATERIAL MANAGEMENT

- 1. ALL CONSTRUCTION EQUIPMENT AND MATERIALS (IMPORTED OR EXCAVATED) MUST BE STORED AT LEAST 30 m
- AWAY FROM ANY WATERBODY IN A STABLE AREA ABOVE THE ACTIVE FLOODPLAIN, OR IN A DESIGNATED
- 2. IN THE EVENT OF AN UNEXPECTED STORM, ALL UNFIXED ITEMS THAT HAVE THE POTENTIAL TO CAUSE A SPILL OR
- AN OBSTRUCTION TO FLOW MUST BE MOVED A STABLE AREA ABOVE ACTIVE FLOODPLAIN. 3. STOCKPILES MUST BE LOCATED OUTSIDE THE ISOLATED WORK AREAS.
- 4. STABILIZE, TEMPORARILY OR PERMANENTLY, ANY DISTURBED AREAS AS WORK PROGRESSES, OR SOON AS CONDITIONS ALLOW.
- 5. MINIMIZE THE AREA OF DISTURBANCE TO THE EXTENT POSSIBLE. ALL DISTURBED GROUND LEFT INACTIVE FOR MORE THAN 30 DAYS SHALL BE STABILIZED USING APPROPRIATE EROSION CONTROL MEASURES AND AN
- APPROPRIATE SEED MIX AS NOTED WITHIN THE FINAL APPROVED RESTORATION PLAN.
- 6. ALL VEGETATION, ADJACENT TO THE WORK AREA, MUST BE PROTECTED AND DELINEATED WITH CONSTRUCTION FENCING OR TREE PROTECTION BARRIERS.
- 7. ALL GRADES IN THE AREA REGULATED BY THE CONSERVATION AUTHORITY MUST BE MAINTAINED OR MATCHED,
- UNLESS OTHERWISE AUTHORIZED IN THE APPLICABLE PERMIT.

 8. AN AFTER-HOURS CONTACT NUMBER IS TO BE VISIBLY POSTED ONSITE FOR EMERGENCIES. ALL THE PLANS

SHOULD HAVE NAME AND CONTACT INFO OF THE PERSON RESPONSIBLE FOR ESC MEASURES.

EROSION AND SEDIMENT CONTROL

- 1. ALL TEMPORARY EROSION AND SEDIMENT CONTROL MEASURES MUST BE INSTALLED PRIOR TO START OF WORKS 2. FOLLOWING INSTALLATION OF THE PROPOSED ESC MEASURES. A QUALIFIED AGENT OF THE PROPONENT (E.G. CAN-CISEC CERTIFIED MONITOR) WILL CONDUCT REGULAR SITÉ VISITS TO MONITOR ALL WORKS, PARTICULARLY THE CONDITION OF THE ESC MEASURES, DEWATERING, AND IN- OR NEAR-WATER WORKS, SHOULD CONCERNS ARISE; THE ENVIRONMENTAL MONITOR WILL CONTACT THE PROPONENT, THE CONSERVATION AUTHORITY, AND
- 3 FROSION AND SEDIMENT CONTROLS MUST BE MAINTAINED DURING CONSTRUCTION, AND ANY REQUIRED REPAIRS OR REPLACEMENTS MUST BE COMPLETED WITHIN 24 HOURS AFTER THEY HAVE BEEN IDENTIFIED DURING THE
- 4. EROSION AND SEDIMENT CONTROLS MAY REQUIRE PERIODIC ADJUSTMENTS TO REFLECT CHANGING SITE CONDITIONS. THE CONTRACTOR WILL BE RESPONSIBLE FOR THESE ADJUSTMENTS TO ENSURE PROPER
- 5. ANY CHANGES TO THE EROSION AND SEDIMENT CONTROL PLAN BEYOND MINOR ADJUSTMENTS MUST BE
- APPROVED BY THE CONTRACT ADMINISTRATOR. 6. ADDITIONAL EROSION AND SEDIMENT CONTROL SUPPLIES MUST BE KEPT ON SITE IN ORDER TO FACILITATE IMMEDIATE REPAIRS AND/OR UPGRADES AS NEEDED.
- 7. ALL TEMPORARY SEDIMENT CONTROLS MUST BE REMOVED AFTER THE CONTRACT ADMINISTRATOR DEEMS THE 8. THE PROJECT PROPONENT OR THEIR REPRESENTATIVE IS ULTIMATELY RESPONSIBLE FOR CONTROLLING
- SEDIMENT AND EROSION WITHIN THE CONSTRUCTION SITE FOR THE TOTAL PERIOD OF THE CONSTRUCTION. 9. IF EXCESSIVE SILTATION RESULTS FROM THE CONSTRUCTION ACTIVITIES, THE ONSITE SUPERVISOR/INSPECTOR AND/OR THE LOCAL REGULATORY BODY RESERVE THE RIGHT TO REQUEST ADDITIONAL ESC MEASURES WHICH WOULD BE INSTALLED PRIOR TO FURTHER CONSTRUCTION ACTIVITIES.

DELETERIOUS SUBSTANCE CONTROL/SPILL MANAGEMENT

- 1. PREVENT THE RELEASE OF SEDIMENT, SEDIMENT-LADEN WATER, RAW CONCRETE, CONCRETE LEACHATE OR ANY OTHER DELETERIOUS SUBSTANCES INTO ANY WATERBODY. RAVINE OR STORM SEWER SYSTEM. 2. ENSURE EQUIPMENT AND MACHINERY ARE IN GOOD OPERATING CONDITION (POWER WASHED), FREE OF LEAKS,
- 3. NO EQUIPMENT REFUELLING OR SERVICING SHOULD BE UNDERTAKEN WITHIN 30 m OF ANY WATERCOURSE OR SURFACE WATER DRAINAGE.
- 4. A SPILL CONTAINMENT KIT MUST BE READILY ACCESSIBLE ON SITE IN THE EVENT OF A RELEASE OF A DELETERIOUS SUBSTANCE TO THE ENVIRONMENT. ONSITE STAFF MUST BE TRAINED IN ITS USE. 5. THE CONTRACT ADMINISTRATOR MUST BE NOTIFIED IMMEDIATELY IN THE EVENT OF A SPILL OF DELETERIOUS

SUBSTANCE. ANY SEDIMENT SPILL FROM THE SITE SHOULD BE REPORTED TO MINISTRY OF ENVIRONMENT (SPILL ACTION CENTER) AT 1-800-268-6060. **WORK AREA ISOLATION**

- 1. ALL WORK IN ISOLATED WORK AREAS MUST BE COMPLETED IN THE DRY. AN ADEQUATE NUMBER OF PUMPS MUST
- BE USED FOR UNWATERING.
 2. CROSSING AN ACTIVE WATERCOURSE OR WETLAND BY EQUIPMENT, VEHICLES, PERSONNEL, ETC. IS NOT PERMITTED UNLESS APPROVED BY THE CONSERVATION AUTHORITY. ALL ACCESS TO WORK SITES SHALL BE FROM
- EITHER SIDES OF THE WATERCOURSE OR WETLAND.

 3. THE UNWATERING DISCHARGE LOCATION MUST BE LOCATED AT LEAST 30 M FROM ANY WATERCOURSE OR WETLAND IN AN AREA WITH DENSE VEGETATIVE GROUNDCOVER, AND WHERE THE DISCHARGE CAN RETURN TO
- THE WATERBODY DOWNSTREAM OF THE WORK AREA OVER THE GROUNDCOVER 4. FISH MUST BE REMOVED FROM THE WORK AREA ONCE ISOLATED. FISH SALVAGE MUST BE COMPLETED BY A QUALIFIED TECHNICIAN WITH A LICENSE FROM THE ONTARIO MINISTRY OF NATURAL RESOURCES AND FORESTR'S

DATE BY **REVISIONS** CHECKED BY: PV DESIGNED BY: LD/AS

DRAFT FOR **INTERNAL**

DRAWN BY: AL/CP/SC

DATE: JUNE 2024

NOT FOR CONSTRUCTION


DISCUSSION

 $M O R P H I X^{\mathsf{TM}}$ 36 Main St N., P.O. Box 205 Campbellville, Ontario L0P 1B0 T: 416.920.0926 www.geomorphix.com

ALLOA SPA TOWN OF CALEDON


ETOBICOKE CREEK - ALLOA DRAIN CONCEPTUAL CHANNEL DESIGN RESTORATION DETAILS

DRAWING No.: DET-7 PROJECT No.: PN24009 SCALE: AS NOTED SHEET 33 OF 35

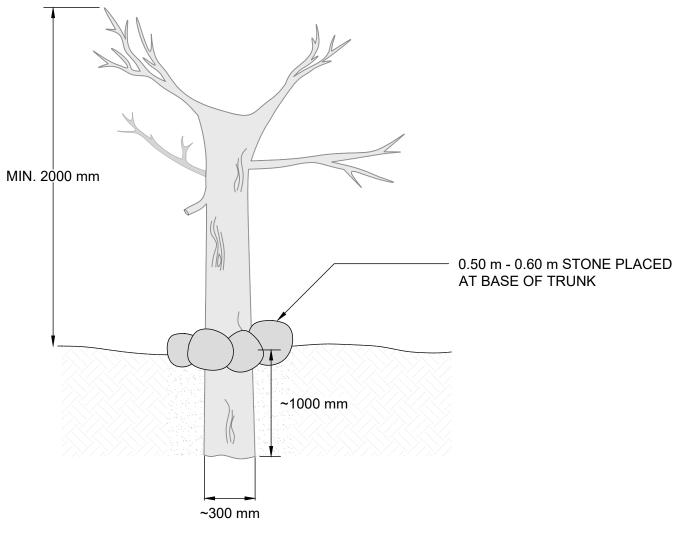


- 1. CONSTRUCT WITH CONIFER TRUNKS WITH TWO OR MORE NATURAL
- BRANCHES.
- AT LEAST 75% OF THE BARK SHOULD BE INTACT. 3. AUGER HOLE TO A DEPTH OF ~1.0 m INSTALL TRUNK AND TAMP IN SAND
- AROUND BASE
- 4. ~1.0 m OF TRUNK IS TO BE BURIED.
- PLACE 0.50 m 0.60 m STONE AROUND BASE FOR ADDITIONAL SUPPORT.
- IF ROOT WAD IS USED PLACE ROOT AT TOP. LOGS SHOULD BE SOURCED ON SITE (WHERE POSSIBLE).

RAPTOR POLE

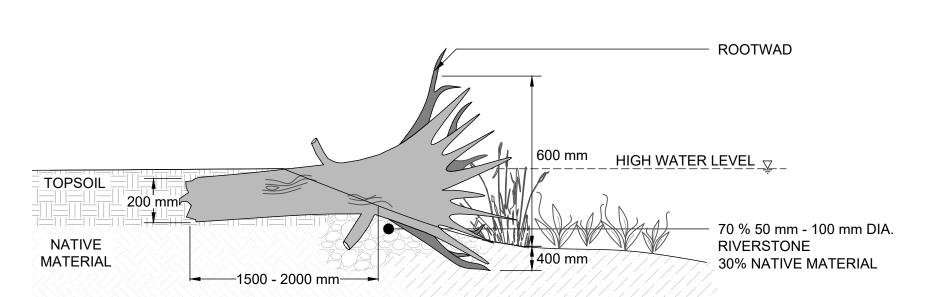


- 1. SALVAGE NATIVE TREES ON SITE. IF POSSIBLE. AND CUT TO
- DIMENSIONS SHOWN.
- 2. ROOT BALL TO BE ~1000 mm IN DIAMETER AND ~2000 mm IN LENGTH
- 3. INSTALL BOTTOM 1/3 OF LIVE ROOT WAD INTO WETLAND.

ROOT WAD

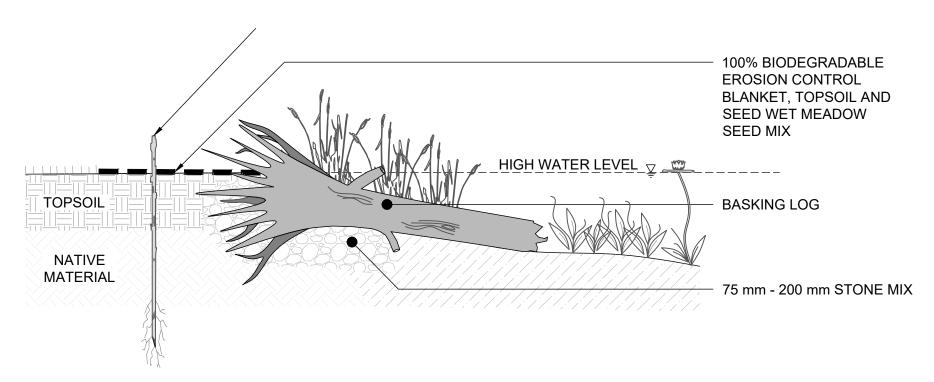

- ANCHOR AND SUPPORT BASKING LOGS WITH 75 mm 200 mm STONE MIX.
- FIRMLY COMPACT STONE MIX TO PREVENT THROUGH FLOW.
- . BURY 1/3 OF LOG INTO SOIL.
- 4. LENGTH OF BASKING LOGS ARE TO BE INSTALLED 1000 1500 mm INTO WET AREA.
- BASKING LOGS TO BE A MINIMUM 500 mm IN DIAMETER AND 2000 2500 mm IN LENGTH.
- BASKING LOGS SHOULD BE ANGLED TO PROMOTE TURTLE BASKING.
- BASKING LOGS SHOULD BE A MIXTURE OF SUITABLE HARDWOOD AND SOFTWOOD SPECIES.


BASKING LOG

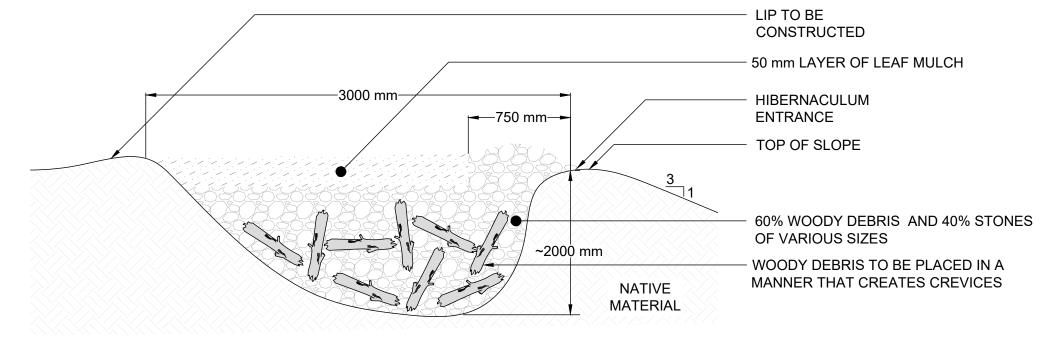

- 1. SNAKE HIBERNACULUM PLACEMENT TO BE CONFIRMED BY A QUALIFIED BIOLOGIST. 2. SNAKE HIBERNACULUM TO BE CONSTRUCTED INTO TOP OF SLOPE (SEE PLAN) ALONG WEST
- OR SOUTH FACING SLOPES IN A LOCATION FREE OF SHADE. 3. A LIP IS TO BE CONSTRUCTED ALONG THE TOP OF SLOPE TO PREVENT RUNOFF FROM
- ENTERING THE HIBERNACULUM. 4. LARGER STONES WITH BRUSH TO BE INSTALLED AT OPENING. DO NOT FILL VOIDS OR
- COMPACT MATERIAL AROUND STONES. CREATE CREVICES TO PROMOTE ENTRANCE INTO HIBERNACULUM.
- 5. LOOSELY PLACE ANGULAR STONE RANGING IN SIZE FROM 0.10 m 0.50 m AND WOODY DEBRIS SUCH THAT VOIDS REMAIN.
- 6. CONCRETE DEBRIS MAY BE USED IF SOURCED ON SITE.
- 7. HARDWOOD OR SOFTWOOD SPECIES ARE ACCEPTABLE FOR WOODY DEBRIS. LOGS SHOULD

BE SOURCED ON SITE (WHERE POSSIBLE).

SNAKE HIBERNACULUM

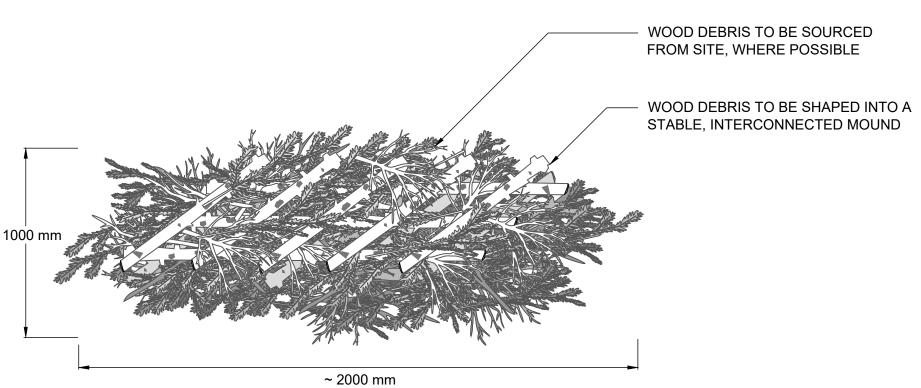


- 1. LARGEST AND HEAVIEST LOG MATERIAL SHOULD BE PLACED ON THE BASE OF THE BRUSH PILE. THE SMALLEST BRUSH MATERIAL SHOULD BE
- 2. LOGS SHOULD BE FORMED INTO A PALLET SHAPE.
- 3. HEIGHT OF BRUSH PILE IS NOT TO EXCEED 1000 mm.
- 4. A MIX OF HARDWOOD AND SOFTWOOD SHOULD BE USED. 5. PLANT WITH NATIVE FRUIT BEARING VINES.

PALLET TYPE WOOD PILE


EROSION CONTROL BLANKET SPECIFICATIONS

- 1. A BIODEGRADABLE EROSION CONTROL BLANKET (ECB) SHALL BE INSTALLED ON ALL DISTURBED NATURAL SURFACES FOLLOWING THE PLACEMENT OF TOPSOIL AND APPLICATION OF THE NATIVE SEED MIX.
- 2. THE ECB MUST BE CONSTRUCTED OF 100% WOVEN COCONUT FIBRE (E.G., COIR) OR STRAW MAT WITHIN A GEOJUTE NETTING (TOP AND BOTTOM) WITH BIODEGRADABLE THREAD. NON-BIODEGRADABLE MATERIAL INCLUDING POLYPROPELENE OR PLASTICS WITH A BIODEGRADABLE RATING ARE NOT ACCEPTABLE. THE MINIMUM WEIGHT OF THE ECB MUST BE $400 \text{ g/m}^2 (12 \text{ oz./yd}^2).$
- 3. TO INSTALL, THE ECB MUST BE UNROLLED DOWNSLOPE OR IN DIRECTION OF WATER FLOW ADJACENT ECBS SHOULD OVERLAP A MINIMUM OF 150 mm ALONG THE EDGES. AT THE END OF EACH ROLL, FOLD BACK 100 mm TO 200 mm OF THE ECB. OVERLAP THIS 100 mm TO 200 mm OVER THE START OF THE NEXT ROLL. SECURE THE TWO LAYERS TO THE GROUND SECURELY.
- 4. BIODEGRADABLE OR TAPERED WOODEN STAKES SHALL BE USED TO SECURE THE BLANKET. STAKES SHALL BE INSTALLED AT THE SPACING RECOMMENDED BY THE ECB MANUFACTURER TO PREVENT SURFACE RUNOFF FROM ERODING THE UNDERLYING SOIL.

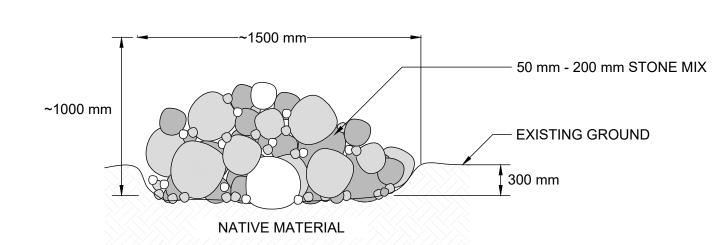


- 50 mm 200 mm STONE MIX WITH SOME ANGULAR STONES.
- THE STONE MIX SHOULD PROVIDE A VARIETY OF INTERSTITIAL SPACES.
- PILES ARE AT LEAST 1500 mm IN DIAMETER AND ~1000 mm HIGH. EMBED ROCK PILE 300 mm TO AVOID ROCKFALL.

ROCK PILE

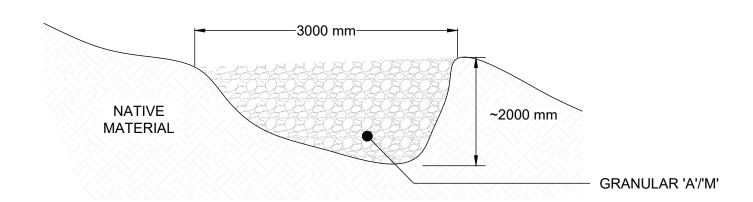


- . TURTLE NESTING SITE TO BE INSTALLED ON SLOPES AWAY FROM THE WATERCOURSE AND ON SOUTH OR WEST FACING SLOPES.
- 2. FEATURE TO BE CONSTRUCTED USING ROAD SHOULDER GRANULAR 'A'/'M' TYPE MATERIAL ONLY.
- NO VEGETATION OR WOODY DEBRIS IS TO BE INCLUDED.

TURTLE NEST

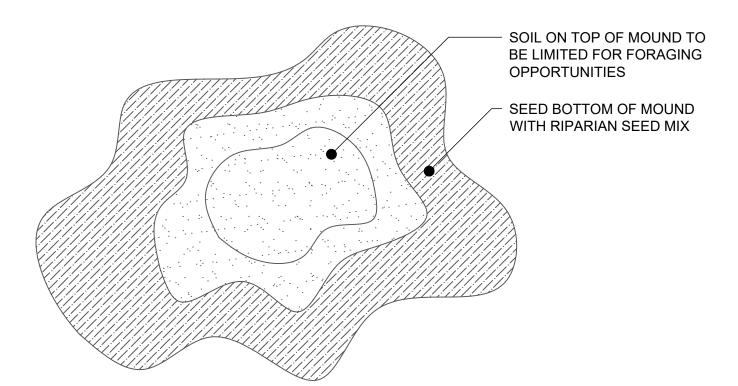

- HEIGHT OF TERRESTRIAL MOUND SHALL BE 500 mm TO 1000 mm.
- 2. LOCATION OF VEGETATED TERRESTRIAL MOUND IS TO BE DETERMINED BY THE DESIGNER IN FIELD, IN DRY AREAS ONLY.
- 3. CONSTRUCTION OF MOUND TO BE COMPLETED IN CONJUNCTION WITH VERNAL POOL EXCAVATION.
- 4. TERRESTRIAL MOUNDS TO BE GRADED TO MATCH EXISTING GROUND AND/OR TIE INTO EXISTING SLOPES.
- TERRESTRIAL MOUND TO BE SLIGHTLY CONCAVE/DIMPLED ON TOP.
- TERRESTRIAL MOUND TO BE SEEDED AND COVERED WITH 100% BIODEGRADABLE EROSION CONTROL BLANKET (BioNET C125BN OR APPROVED EQUIVALENT) IMMEDIATELY FOLLOWING SHAPING. EROSION CONTROL BLANKET TO BE SECURED WITH WOOD
- 7. SEED MIX TO BE COMPRISED OF WOODLAND SPECIES. SEE DET-1 DRAWINGS FOR SEED MIX SPECIFICATIONS.

TERRESTRIAL MOUND N.T.S

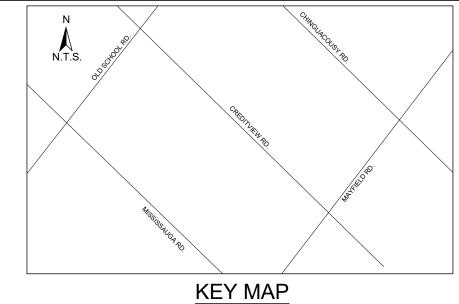

- 1. THE ACCOMPANYING CHANNEL REALIGNMENT TECHNICAL DESIGN BRIEF PREPARED BY GEO MORPHIX LTD. (2023) PROVIDES ADDITIONAL DESIGN DETAILS AND DIRECTION FOR IMPLEMENTATION AND IS TO BE REVIEWED IN CONJUNCTION WITH THIS DRAWING SET.
- 2. ALL CONTRACT DRAWINGS, SPECIFICATIONS AND APPLICABLE PERMITS MUST BE KEPT ON SITE DURING
- CONSTRUCTION FOR REFERENCE.

 3. THE CONTRACTOR MUST NOTIFY THE DESIGNER AND CONTRACT ADMINISTRATOR OF THE INTENT TO COMMENCE
- WORK AT LEAST 48 HOURS IN ADVANCE. 4. THE CONTRACTOR IS RESPONSIBLE FOR ALL UTILITY LOCATES. LAYOUT MUST BE REVIEWED AND APPROVED BY THE DESIGNER / DESIGNER REPRESENTATIVE, DESIGNATED
- ENGINEER, AND THE CONTRACT ADMINISTRATOR.
- 6. CONSTRUCTION OBSERVATION IS TO BE PERFORMED BY A CERTIFIED FLUVIAL GEOMORPHOLOGIST OR
- EXPERIENCED ENVIRONMENTAL INSPECTOR UNDER DIRECTION FROM THE DESIGNER. 7. ON-SITE SUPPORT FROM PROJECT ENGINEER (E.G., GEOTECHNICAL, HYDROGEOLOGICAL, AND/OR WATER
- RESOURCES ENGINEER) REQUIRED TO ASSESS AND ENSURE FAVOURABLE SURFICIAL AND SUBSURFACE CONDITIONS TO SUPPORT CHANNEL REALIGNMENT CONSTRUCTION.
- 8. BE ADVISED THAT THE LOCAL REGULATORY BODY MAY, AT ANY TIME, WITHDRAW THIS PERMISSION, IF, IN THE OPINION OF THE AUTHORITY. THE CONDITIONS OF THE PERMIT ARE NOT BEING COMPLIED WITH, THIS APPROVAL DOES NOT EXEMPT THE PROPERTY OWNER/APPLICANT/AGENT FROM THE PROVISIONS OF ANY OTHER FEDERAL, PROVINCIAL OR MUNICIPAL STATUTES, REGULATIONS OR BY-LAWS, OR ANY RIGHTS UNDER COMMON LAW.

- 1. WORKS SHALL BE COMPLETED DURING THE DESIGNATED IN-WATER WORKS WINDOW SET OUT BY MNRF/DFO. TREE CLEARING IS TO BE COMPLETED OUTSIDE THE BIRD NESTING SEASON (APRIL 1ST TO AUGUST 1ST) TO COMPLY WITH THE FEDERAL MIGRATORY BIRDS CONVENTION ACT. ANY TREES THAT REQUIRE REMOVAL OUTSIDE
- OF THIS TIMING WINDOW MUST FIRST BE INSPECTED BY A QUALIFIED BIOLOGIST TO DETERMINE THE PRESENCE OF 3. THE WEATHER FORECAST SHOULD BE CONTINUALLY MONITORED TO ENSURE THAT WORKS ARE UNDERTAKEN
- ONLY DURING FAVOURABLE WEATHER CONDITIONS. 4. COMPLETE THE WORKS WITH MINIMAL AVOIDABLE INTERRUPTIONS ONCE THEY COMMENCE.

SITE AND MATERIAL MANAGEMENT

- 1. ALL CONSTRUCTION EQUIPMENT AND MATERIALS (IMPORTED OR EXCAVATED) MUST BE STORED AT LEAST 30 m
- AWAY FROM ANY WATERBODY IN A STABLE AREA ABOVE THE ACTIVE FLOODPLAIN, OR IN A DESIGNATED
- 2. IN THE EVENT OF AN UNEXPECTED STORM, ALL UNFIXED ITEMS THAT HAVE THE POTENTIAL TO CAUSE A SPILL OR AN OBSTRUCTION TO FLOW MUST BE MOVED A STABLE AREA ABOVE ACTIVE FLOODPLAIN.
- 3. STOCKPILES MUST BE LOCATED OUTSIDE THE ISOLATED WORK AREAS.
- 4. STABILIZE, TEMPORARILY OR PERMANENTLY, ANY DISTURBED AREAS AS WORK PROGRESSES, OR SOON AS CONDITIONS ALLOW. 5. MINIMIZE THE AREA OF DISTURBANCE TO THE EXTENT POSSIBLE. ALL DISTURBED GROUND LEFT INACTIVE FOR
- MORE THAN 30 DAYS SHALL BE STABILIZED USING APPROPRIATE EROSION CONTROL MEASURES AND AN APPROPRIATE SEED MIX AS NOTED WITHIN THE FINAL APPROVED RESTORATION PLAN.
- 6. ALL VEGETATION, ADJACENT TO THE WORK AREA, MUST BE PROTECTED AND DELINEATED WITH CONSTRUCTION FENCING OR TREE PROTECTION BARRIERS.
- 7. ALL GRADES IN THE AREA REGULATED BY THE CONSERVATION AUTHORITY MUST BE MAINTAINED OR MATCHED, UNLESS OTHERWISE AUTHORIZED IN THE APPLICABLE PERMIT.

 8. AN AFTER-HOURS CONTACT NUMBER IS TO BE VISIBLY POSTED ONSITE FOR EMERGENCIES. ALL THE PLANS
- SHOULD HAVE NAME AND CONTACT INFO OF THE PERSON RESPONSIBLE FOR ESC MEASURES.

EROSION AND SEDIMENT CONTROL

- 1. ALL TEMPORARY EROSION AND SEDIMENT CONTROL MEASURES MUST BE INSTALLED PRIOR TO START OF WORKS. 2. FOLLOWING INSTALLATION OF THE PROPOSED ESC MEASURES, A QUALIFIED AGENT OF THE PROPONENT (E.G. CAN-CISEC CERTIFIED MONITOR) WILL CONDUCT REGULAR SITÉ VISITS TO MONITOR ALL WORKS, PARTICULARLY THE CONDITION OF THE ESC MEASURES, DEWATERING, AND IN- OR NEAR-WATER WORKS. SHOULD CONCERNS ARISE; THE ENVIRONMENTAL MONITOR WILL CONTACT THE PROPONENT, THE CONSERVATION AUTHORITY, AND
- 3. EROSION AND SEDIMENT CONTROLS MUST BE MAINTAINED DURING CONSTRUCTION, AND ANY REQUIRED REPAIRS OR REPLACEMENTS MUST BE COMPLETED WITHIN 24 HOURS AFTER THEY HAVE BEEN IDENTIFIED DURING THE
- 4. EROSION AND SEDIMENT CONTROLS MAY REQUIRE PERIODIC ADJUSTMENTS TO REFLECT CHANGING SITE CONDITIONS. THE CONTRACTOR WILL BE RESPONSIBLE FOR THESE ADJUSTMENTS TO ENSURE PROPER
- 5. ANY CHANGES TO THE EROSION AND SEDIMENT CONTROL PLAN BEYOND MINOR ADJUSTMENTS MUST BE APPROVED BY THE CONTRACT ADMINISTRATOR.
- 6. ADDITIONAL EROSION AND SEDIMENT CONTROL SUPPLIES MUST BE KEPT ON SITE IN ORDER TO FACILITATE IMMEDIATE REPAIRS AND/OR UPGRADES AS NEEDED.
- 7. ALL TEMPORARY SEDIMENT CONTROLS MUST BE REMOVED AFTER THE CONTRACT ADMINISTRATOR DEEMS THE 8. THE PROJECT PROPONENT OR THEIR REPRESENTATIVE IS ULTIMATELY RESPONSIBLE FOR CONTROLLING
- SEDIMENT AND EROSION WITHIN THE CONSTRUCTION SITE FOR THE TOTAL PERIOD OF THE CONSTRUCTION. 9. IF EXCESSIVE SILTATION RESULTS FROM THE CONSTRUCTION ACTIVITIES, THE ONSITE SUPERVISOR/INSPECTOR AND/OR THE LOCAL REGULATORY BODY RESERVE THE RIGHT TO REQUEST ADDITIONAL ESC MEASURES WHICH WOULD BE INSTALLED PRIOR TO FURTHER CONSTRUCTION ACTIVITIES.

DELETERIOUS SUBSTANCE CONTROL/SPILL MANAGEMENT

- 1. PREVENT THE RELEASE OF SEDIMENT, SEDIMENT-LADEN WATER, RAW CONCRETE, CONCRETE LEACHATE OR AN OTHER DELETERIOUS SUBSTANCES INTO ANY WATERBODY. RAVINE OR STORM SEWER SYSTEM. 2. ENSURE EQUIPMENT AND MACHINERY ARE IN GOOD OPERATING CONDITION (POWER WASHED), FREE OF LEAKS,
- 3. NO EQUIPMENT REFUELLING OR SERVICING SHOULD BE UNDERTAKEN WITHIN 30 m OF ANY WATERCOURSE OR SURFACE WATER DRAINAGE.
- 4. A SPILL CONTAINMENT KIT MUST BE READILY ACCESSIBLE ON SITE IN THE EVENT OF A RELEASE OF A DELETERIOUS SUBSTANCE TO THE ENVIRONMENT. ONSITE STAFF MUST BE TRAINED IN ITS USE. 5. THE CONTRACT ADMINISTRATOR MUST BE NOTIFIED IMMEDIATELY IN THE EVENT OF A SPILL OF DELETERIOUS

SUBSTANCE. ANY SEDIMENT SPILL FROM THE SITE SHOULD BE REPORTED TO MINISTRY OF ENVIRONMENT (SPILL ACTION CENTER) AT 1-800-268-6060.

- **WORK AREA ISOLATION** 1. ALL WORK IN ISOLATED WORK AREAS MUST BE COMPLETED IN THE DRY. AN ADEQUATE NUMBER OF PUMPS MUST BE USED FOR UNWATERING.
 CROSSING AN ACTIVE WATERCOURSE OR WETLAND BY EQUIPMENT, VEHICLES, PERSONNEL, ETC. IS NOT
- PERMITTED UNLESS APPROVED BY THE CONSERVATION AUTHORITY. ALL ACCESS TO WORK SITES SHALL BE FROM EITHER SIDES OF THE WATERCOURSE OR WETLAND.
- THE UNWATERING DISCHARGE LOCATION MUST BE LOCATED AT LEAST 30 M FROM ANY WATERCOURSE OR WETLAND IN AN AREA WITH DENSE VEGETATIVE GROUNDCOVER, AND WHERE THE DISCHARGE CAN RETURN TO THE WATERBODY DOWNSTREAM OF THE WORK AREA OVER THE GROUNDCOVER
- 4. FISH MUST BE REMOVED FROM THE WORK AREA ONCE ISOLATED. FISH SALVAGE MUST BE COMPLETED BY A QUALIFIED TECHNICIAN WITH A LICENSE FROM THE ONTARIO MINISTRY OF NATURAL RESOURCES AND FORESTR

	DATE	BY	REVISIONS	
DESIGNED BY: LD/AS				CHECKED BY: PV

DRAWN BY: AL/CP/SC DRAFT FOR **INTERNAL**

DISCUSSION



DATE: JUNE 2024


NOT FOR CONSTRUCTION


36 Main St N., P.O. Box 205 Campbellville, Ontario L0P 1B0 T: 416.920.0926 www.geomorphix.com

ALLOA SPA TOWN OF CALEDON

ETOBICOKE CREEK - ALLOA DRAIN CONCEPTUAL CHANNEL DESIGN RESTORATION DETAILS

DRAWING No.: DET-8 PROJECT No.: PN24009 SCALE: AS NOTED SHEET 34 OF 35

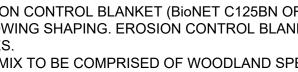

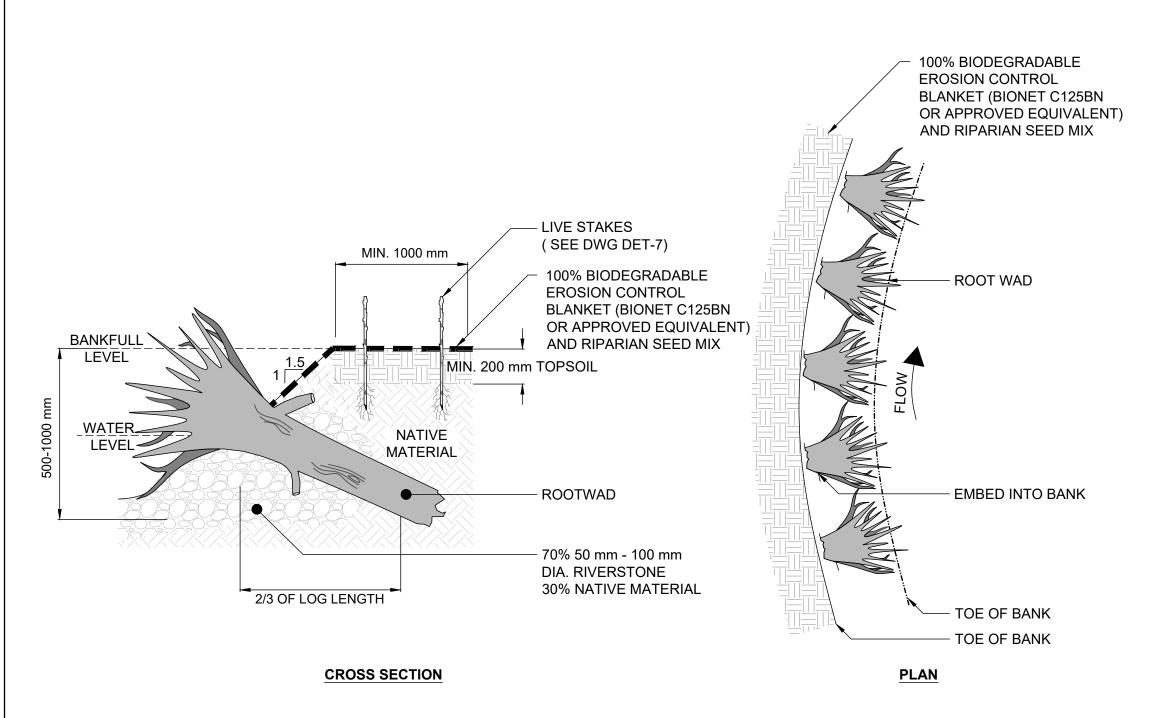

ROOT WADS TO BE SOURCED ON-SITE.

- 2. ANCHOR ROOT WADS INTO BANK AND SUPPORT WITH STONE. 3. ROOT WAD LOGS TO BE A MINIMUM 500 mm IN DIAMETER AND 2000 mm IN
- LENGTH WITH A 1000 1500 mm ROOT BALL.
- 4. BURY 2/3 OF THE ROOT WAD LOG (APPROXIMATELY 1000 mm) INTO THE
- 5. ROOT WADS TO BE SPACED SUCH THAT ROOT STEMS OVERLAP.

XX mm


ROOT WAD BANK ENHANCEMENT


SCIENTIFIC NAME	COMMON NAME	PERCENTAGE
ASCLEPIAS INCARNATA	SWAMP MILKWEED	2%
BROMUS CILIATUS	FRINGED BROME	2%
CAREX BEBBII	BEBB'S SEDGE*	1%
CAREX STIPATA	AWL-FRUITED SEDGE	1%
CAREX VULPINOIDEA	FOX SEDGE	5%
DOELLINGERIA UMBELLATA	FLAT-TOPPED ASTER	1%
ELYMUS RIPARIUS	RIVERBANK RYE	10%
ELYMUS VIRGINICUS	VIRGINIA WLID RYE	10%
EUPATORIUM MACULATUM	JOE-PYE WEED	3%
EUPATORIUM PERFOLIATUM	BONESET	2%
GLYCERIA STRIATA	FOWL MANNA GRASS	3%
JUNCUS ARTICULATUS	JOINTED RUSH	2%
JUNCUS BALTICUS	BALTIC RUSH	1%
JUNCUS EFFUSUS	SOFT RUSH	1%
JUNCUS TENUIS	PATH RUSH	2%
JUNCUS TORREYI	TORREY'S RUSH*	1%
LIATRIS SPICATA	DENSE BLAZING STAR	1%
LOBELIA CARDINALIS	CARDINAL FLOWER	1%
LOBELIA SIPHILITICA	BLUE LOBELIA	1%
MIMULUS RINGENS	MONKEY FLOWER	1%
MONARDA FISTULOSA	WILD BERGAMONT	3%
OENOTHERA BIENNIS	EVENING PRIMROSE	2%
PANICUM VIRIGATUM	SWITCH GRASS	10%
PENSTEMON DIGITALIS	FOXGLOVE BEARDTONGUE	2%
PHYSOSTEGIA VIRGINIANA SSP. VIRGINIANA	FALSE DRAGONHEAD OR OBEDIENT PLANT	2%
RUDBECKIA HIRTA	BLACK EYED SUSAN	5%
RUDBECKIA LACINIATA	GREEN CONEFLOWER*	1%
SCIRPUS ATROVIRENS	GREEN BULRUSH	3%
SCIRPUS CYPERINUS	WOOLGRASS BULRUSH	3%
SOLIDAGO GRAMINIFOLIA	LANCE-LEAVED GOLDENROD*	1%
SORGHASTRUM NUTANS	INDIAN GRASS	7%
SYMPHYOTRICHUM ERICOIDES	HEATH ASTER	2%
SYMPHYOTRICHUM NOVAE-ANGLIAE	NEW ENGLAND ASTER	1%
SYMPHYOTRICHUM PILOSUM	HAIRY ASTER	2%
SYMPHYOTRICHUM PUNICEUM	SWAMP ASTER	2%
VERBENA HASTATA	BLUE VERVAIN	3%
NOTES:		

TRCA - RIPARIAN MIX

SCIENTIFIC NAME	COMMON NAME	PERCENTA
ASCLEPIAS INCARNATA	SWAMP MILKWEED	1.0%
BROMUS CILIATUS	FRINGED BROME	5.0%
CAREX BEBBII	BEBB'S SEDGE*	1.0%
CAREX STIPATA	AWL-FRUITED SEDGE	1.0%
CAREX VULPINOIDEA	FOX SEDGE	5.0%
DOELLINGERIA UMBELLATA	FLAT-TOPPED ASTER	1.0%
ELYMUS RIPARIUS	RIVERBANK RYE	15.0%
ELYMUS VIRGINICUS	VIRGINIA WILD RYE	20.0%
EUPATORIUM MACULATUM	JOE-PYE WEED	2.0%
EUPATORIUM PERFOLIATUM	BONESET	2.0%
GLYCERIA STRIATA	FOWL MANNA GRASS	5.0%
JUNCUS ARTICULATUS	JOINTED RUSH	1.0%
JUNCUS BALTICUS	BALTIC RUSH	1.0%
JUNCUS EFFUSUS	SOFT RUSH	1.0%
JUNCUS TENUIS	PATH RUSH	1.0%
JUNCUS TORREYI	TORREY'S RUSH*	1.0%
LIATRIS SPICATA	DENSE BLAZING STAR	1.0%
LOBELIA CARDINALIS	CARDINAL FLOWER	1.0%
LOBELIA SIPHILITICA	BLUE LOBELIA	1.0%
MIMULUS RINGENS	MONKEY FLOWER	1.0%
MONARDA FISTULOSA	WILD BERGAMONT	4.0%
OENOTHERA BIENNIS	EVENING PRIMROSE	1.0%
PANICUM VIRIGATUM	SWITCH GRASS	5.0%
PENSTEMON DIGITALIS	FOXGLOVE BEARDTONGUE	2.0%
PHYSOSTEGIA VIRGINIANA SSP. VIRGINIANA	FALSE DRAGONHEAD OR OBEDIENT PLANT	2.0%
RUDBECKIA HIRTA	BLACK EYED SUSAN	2.0%
RUDBECKIA LACINIATA	GREEN CONEFLOWER*	1.0%
SCIRPUS ATROVIRENS	GREEN BULRUSH	4.0%
SCIRPUS CYPERINUS	WOOLGRASS BULRUSH	4.0%
SOLIDAGO GRAMINIFOLIA	LANCE-LEAVED GOLDENROD*	1.0%
SYMPHYOTRICHUM NOVAE-ANGLIAE	NEW ENGLAND ASTER	2.0%
SYMPHYOTRICHUM PILOSUM	HAIRY ASTER	2.0%
SYMPHYOTRICHUM PUNICEUM	SWAMP ASTER	1.0%
VERBENA HASTATA	BLUE VERVAIN	2.0%
NOTES:		

- 3. SIMULTANEOUSLY APPLY A NURSE CROP AT A RATE OF 30 kg PER HECTARE 4. WATER SOIL AFTER SEED APPLICATION.

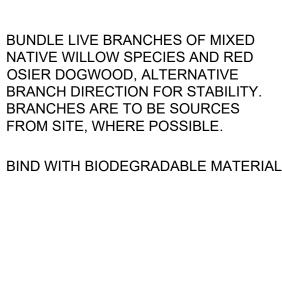


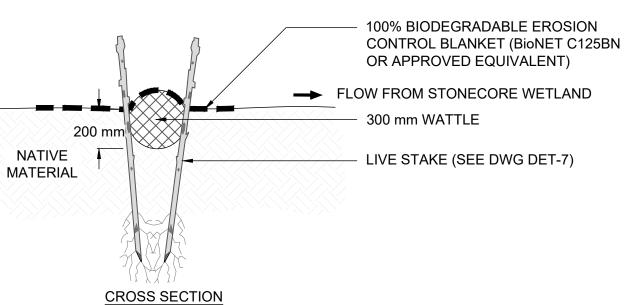

300 mm - 400 mm

1. WATTLES TO BE INSTALLED IN A 200 mm WIDE TRENCH AND STAKED EVERY METER. 2. WATTLE AND GRADING INSTALLATION TO RESULT IN A LEVEL BERM WITHOUT BREAKS.

WATTLE/ FASCINE DETAIL

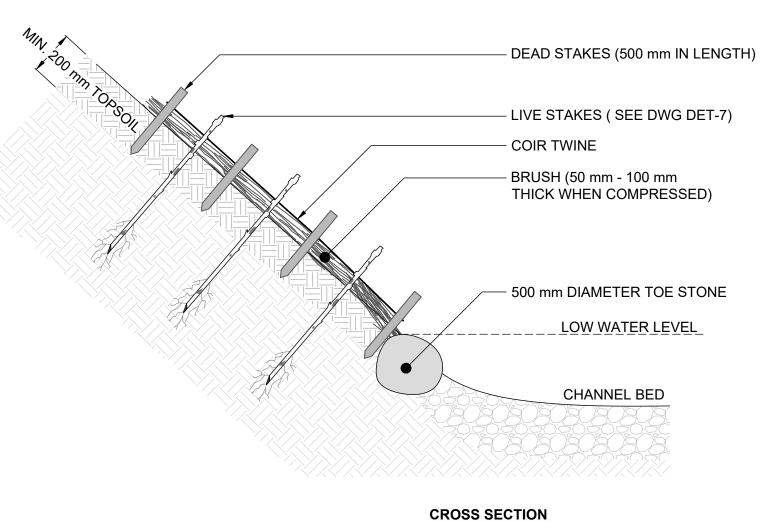


1. APPLY SEED MIX AT A RATE OF 16 kg PER HECTARE.

4. WATER SOIL AFTER SEED APPLICATION.

2. SEEDING SHALL OVERLAP ADJACENT GROUND COVER BY 300 mm.

3. SIMULTANEOUSLY APPLY A NURSE CROP AT A RATE OF 30 kg PER HECTARE

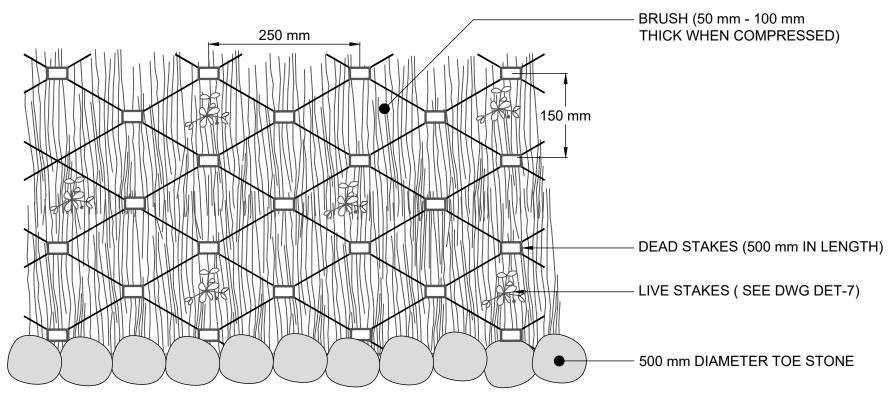

- 1. LIVE BRANCHES TO CONSIST OF WILLOW AND DOGWOOD SPECIES, APPROXIMATELY 1 m IN LENGTH AND 50 mm -
- 2. BRANCHES TO BE KEPT IN MOIST AND COLD UNTIL INSTALLATION. 3. BRUSH MATTRESS TO BE INSTALLED WHILE BRANCHES ARE DORMANT.
- 4. BRANCHES TO BE PLACED ON SLOPE WITH BUTT END TOWARDS VALLEY FLOOR AND PUSHED INTO SOIL. 5. BRANCHES MUST BE FLEXIBLE ENOUGH TO CONFORM TO THE SLOPE SURFACE IRREGULARITIES.
- 6. POUND DEAD STAKES TO HALF THEIR LENGTH INTO SOIL BETWEEN BRANCHES. TIE COIR TWINE AROUND DEAD STAKES AND TIGHTLY OVER BRANCHES. USE A CLOVE HITCH TO SECURE STAKES. POUND STAKES INTO SLOPE TO

PLAN

- COMPRESS BRANCHES AGAINST GROUND. 7. TAMP LIVE STAKES BETWEEN DEAD STAKES.
- 8. FILL VOIDS BETWEEN BRANCHES OF THE BRUSH MATTRESS WITH SOIL TO PROMOTE ROOTING.

BRUSH MATTRESS



1. THE ACCOMPANYING CHANNEL REALIGNMENT TECHNICAL DESIGN BRIEF PREPARED BY GEO MORPHIX LTD. (2023) PROVIDES ADDITIONAL DESIGN DETAILS AND DIRECTION FOR IMPLEMENTATION AND IS TO BE REVIEWED IN

CONJUNCTION WITH THIS DRAWING SET. 2. ALL CONTRACT DRAWINGS, SPECIFICATIONS AND APPLICABLE PERMITS MUST BE KEPT ON SITE DURING

- CONSTRUCTION FOR REFERENCE. 3. THE CONTRACTOR MUST NOTIFY THE DESIGNER AND CONTRACT ADMINISTRATOR OF THE INTENT TO COMMENCE WORK AT LEAST 48 HOURS IN ADVANCE.
- THE CONTRACTOR IS RESPONSIBLE FOR ALL UTILITY LOCATES.
 LAYOUT MUST BE REVIEWED AND APPROVED BY THE DESIGNER / DESIGNER REPRESENTATIVE, DESIGNATED
- ENGINEER, AND THE CONTRACT ADMINISTRATOR.
- 6. CONSTRUCTION OBSERVATION IS TO BE PERFORMED BY A CERTIFIED FLUVIAL GEOMORPHOLOGIST OR EXPERIENCED ENVIRONMENTAL INSPECTOR UNDER DIRECTION FROM THE DESIGNER. 7. ON-SITE SUPPORT FROM PROJECT ENGINEER (E.G., GEOTECHNICAL, HYDROGEOLOGICAL, AND/OR WATER
- RESOURCES ENGINEER) REQUIRED TO ASSESS AND ENSURE FAVOURABLE SURFICIAL AND SUBSURFACE CONDITIONS TO SUPPORT CHANNEL REALIGNMENT CONSTRUCTION. 8. BE ADVISED THAT THE LOCAL REGULATORY BODY MAY, AT ANY TIME, WITHDRAW THIS PERMISSION, IF, IN THE
- OPINION OF THE AUTHORITY. THE CONDITIONS OF THE PERMIT ARE NOT BEING COMPLIED WITH. THIS APPROVAL DOES NOT EXEMPT THE PROPERTY OWNER/APPLICANT/AGENT FROM THE PROVISIONS OF ANY OTHER FEDERAL, PROVINCIAL OR MUNICIPAL STATUTES, REGULATIONS OR BY-LAWS, OR ANY RIGHTS UNDER COMMON LAW.

- 1 WORKS SHALL BE COMPLETED DURING THE DESIGNATED IN-WATER WORKS WINDOW SET OUT BY MNRE/DEO TREE CLEARING IS TO BE COMPLETED OUTSIDE THE BIRD NESTING SEASON (APRIL 1ST TO AUGUST 1ST) TO COMPLY WITH THE FEDERAL MIGRATORY BIRDS CONVENTION ACT. ANY TREES THAT REQUIRE REMOVAL OUTSIDE OF THIS TIMING WINDOW MUST FIRST BE INSPECTED BY A QUALIFIED BIOLOGIST TO DETERMINE THE PRESENCE OF
- 3. THE WEATHER FORECAST SHOULD BE CONTINUALLY MONITORED TO ENSURE THAT WORKS ARE UNDERTAKEN ONLY DURING FAVOURABLE WEATHER CONDITIONS.

4. COMPLETE THE WORKS WITH MINIMAL AVOIDABLE INTERRUPTIONS ONCE THEY COMMENCE.

SITE AND MATERIAL MANAGEMENT

1. ALL CONSTRUCTION EQUIPMENT AND MATERIALS (IMPORTED OR EXCAVATED) MUST BE STORED AT LEAST 30 m AWAY FROM ANY WATERBODY IN A STABLE AREA ABOVE THE ACTIVE FLOODPLAIN, OR IN A DESIGNATED

- 2. IN THE EVENT OF AN UNEXPECTED STORM, ALL UNFIXED ITEMS THAT HAVE THE POTENTIAL TO CAUSE A SPILL OR AN OBSTRUCTION TO FLOW MUST BE MOVED A STABLE AREA ABOVE ACTIVE FLOODPLAIN.
- 3. STOCKPILES MUST BE LOCATED OUTSIDE THE ISOLATED WORK AREAS. 4. STABILIZE, TEMPORARILY OR PERMANENTLY, ANY DISTURBED AREAS AS WORK PROGRESSES, OR SOON AS
- CONDITIONS ALLOW. 5. MINIMIZE THE AREA OF DISTURBANCE TO THE EXTENT POSSIBLE. ALL DISTURBED GROUND LEFT INACTIVE FOR MORE THAN 30 DAYS SHALL BE STABILIZED USING APPROPRIATE EROSION CONTROL MEASURES AND AN
- APPROPRIATE SEED MIX AS NOTED WITHIN THE FINAL APPROVED RESTORATION PLAN. 6. ALL VEGETATION, ADJACENT TO THE WORK AREA, MUST BE PROTECTED AND DELINEATED WITH CONSTRUCTION
- FENCING OR TREE PROTECTION BARRIERS. 7. ALL GRADES IN THE AREA REGULATED BY THE CONSERVATION AUTHORITY MUST BE MAINTAINED OR MATCHED,
- UNLESS OTHERWISE AUTHORIZED IN THE APPLICABLE PERMIT. AN AFTER-HOURS CONTACT NUMBER IS TO BE VISIBLY POSTED ONSITE FOR EMERGENCIES. ALL THE PLANS SHOULD HAVE NAME AND CONTACT INFO OF THE PERSON RESPONSIBLE FOR ESC MEASURES.

EROSION AND SEDIMENT CONTROL

- 1. ALL TEMPORARY EROSION AND SEDIMENT CONTROL MEASURES MUST BE INSTALLED PRIOR TO START OF WORKS. 2. FOLLOWING INSTALLATION OF THE PROPOSED ESC MEASURES, A QUALIFIED AGENT OF THE PROPONENT (E.G. CAN-CISEC CERTIFIED MONITOR) WILL CONDUCT REGULAR SITÉ VISITS TO MONITOR ALL WORKS, PARTICULARLY THE CONDITION OF THE ESC MEASURES, DEWATERING, AND IN- OR NEAR-WATER WORKS. SHOULD CONCERNS ARISE; THE ENVIRONMENTAL MONITOR WILL CONTACT THE PROPONENT, THE CONSERVATION AUTHORITY, AND
- ANY OTHER APPROPRIATE PARTIES. 3. EROSION AND SEDIMENT CONTROLS MUST BE MAINTAINED DURING CONSTRUCTION, AND ANY REQUIRED REPAIRS
- OR REPLACEMENTS MUST BE COMPLETED WITHIN 24 HOURS AFTER THEY HAVE BEEN IDENTIFIED DURING THE 4. EROSION AND SEDIMENT CONTROLS MAY REQUIRE PERIODIC ADJUSTMENTS TO REFLECT CHANGING SITE
- CONDITIONS. THE CONTRACTOR WILL BE RESPONSIBLE FOR THESE ADJUSTMENTS TO ENSURE PROPER
- 5. ANY CHANGES TO THE EROSION AND SEDIMENT CONTROL PLAN BEYOND MINOR ADJUSTMENTS MUST BE APPROVED BY THE CONTRACT ADMINISTRATOR. 6. ADDITIONAL EROSION AND SEDIMENT CONTROL SUPPLIES MUST BE KEPT ON SITE IN ORDER TO FACILITATE
- IMMEDIATE REPAIRS AND/OR UPGRADES AS NEEDED. 7. ALL TEMPORARY SEDIMENT CONTROLS MUST BE REMOVED AFTER THE CONTRACT ADMINISTRATOR DEEMS THE
- 8. THE PROJECT PROPONENT OR THEIR REPRESENTATIVE IS ULTIMATELY RESPONSIBLE FOR CONTROLLING
- SEDIMENT AND EROSION WITHIN THE CONSTRUCTION SITE FOR THE TOTAL PERIOD OF THE CONSTRUCTION. 9. IF EXCESSIVE SILTATION RESULTS FROM THE CONSTRUCTION ACTIVITIES, THE ONSITE SUPERVISOR/INSPECTOR AND/OR THE LOCAL REGULATORY BODY RESERVE THE RIGHT TO REQUEST ADDITIONAL ESC MEASURES WHICH
- WOULD BE INSTALLED PRIOR TO FURTHER CONSTRUCTION ACTIVITIES.

DELETERIOUS SUBSTANCE CONTROL/SPILL MANAGEMENT

- 1. PREVENT THE RELEASE OF SEDIMENT, SEDIMENT-LADEN WATER, RAW CONCRETE, CONCRETE LEACHATE OR ANY OTHER DELETERIOUS SUBSTANCES INTO ANY WATERBODY. RAVINE OR STORM SEWER SYSTEM. 2. ENSURE EQUIPMENT AND MACHINERY ARE IN GOOD OPERATING CONDITION (POWER WASHED), FREE OF LEAKS, EXCESS OIL. AND GREASE 3. NO EQUIPMENT REFUELLING OR SERVICING SHOULD BE UNDERTAKEN WITHIN 30 m OF ANY WATERCOURSE OR
- SURFACE WATER DRAINAGE. 4. A SPILL CONTAINMENT KIT MUST BE READILY ACCESSIBLE ON SITE IN THE EVENT OF A RELEASE OF A
- DELETERIOUS SUBSTANCE TO THE ENVIRONMENT. ONSITE STAFF MUST BE TRAINED IN ITS USE. 5. THE CONTRACT ADMINISTRATOR MUST BE NOTIFIED IMMEDIATELY IN THE EVENT OF A SPILL OF DELETERIOUS SUBSTANCE. ANY SEDIMENT SPILL FROM THE SITE SHOULD BE REPORTED TO MINISTRY OF ENVIRONMENT (SPILL ACTION CENTER) AT 1-800-268-6060.

WORK AREA ISOLATION

- 1. ALL WORK IN ISOLATED WORK AREAS MUST BE COMPLETED IN THE DRY. AN ADEQUATE NUMBER OF PUMPS MUST BE USED FOR UNWATERING.
 2. CROSSING AN ACTIVE WATERCOURSE OR WETLAND BY EQUIPMENT, VEHICLES, PERSONNEL, ETC. IS NOT
- PERMITTED UNLESS APPROVED BY THE CONSERVATION AUTHORITY. ALL ACCESS TO WORK SITES SHALL BE FROM EITHER SIDES OF THE WATERCOURSE OR WETLAND.
- 3. THE UNWATERING DISCHARGE LOCATION MUST BE LOCATED AT LEAST 30 M FROM ANY WATERCOURSE OR WETLAND IN AN AREA WITH DENSE VEGETATIVE GROUNDCOVER, AND WHERE THE DISCHARGE CAN RETURN TO THE WATERBODY DOWNSTREAM OF THE WORK AREA OVER THE GROUNDCOVER
- 4. FISH MUST BE REMOVED FROM THE WORK AREA ONCE ISOLATED. FISH SALVAGE MUST BE COMPLETED BY A QUALIFIED TECHNICIAN WITH A LICENSE FROM THE ONTARIO MINISTRY OF NATURAL RESOURCES AND FORESTRY

	DATE	BY	REVISIONS
DESIGNED BY: LD/AS			CHECKED BY: PV

DRAWN BY: AL/CP/SC DATE: JUNE 2024

DRAFT FOR INTERNAL DISCUSSION

 $M O R P H I X^{\mathsf{m}}$ 36 Main St N., P.O. Box 205 Campbellville, Ontario L0P 1B0

NOT FOR CONSTRUCTION

T: 416.920.0926 www.geomorphix.com

ALLOA SPA **TOWN OF CALEDON**

ETOBICOKE CREEK - ALLOA DRAIN CONCEPTUAL CHANNEL DESIGN RESTORATION DETAILS

SHEET 35 OF 35

DRAWING No.: DET-9 PROJECT No.: PN24009

SCALE: AS NOTED

Appendix J:
Proposed Crossing Locations



